UNITED STATES DEPARTMENT OF THE INTERIOR BUREAU OF LAND MANAGEMENT

OCD Artesia

FORM APPROVED OMB NO. 1004-0137

Expires:	January	
ase Serial No.	_	

SUNDRY N	OTICES AND	REPORTS	ON WELLS
Do not use this	form for propo	osals to drill	or to re-enter an
abandoned well.	Use form 316	0-3 (APD) for	r such proposals

5. Lease Serial No. NMNM94839

Do not use thi abandoned wel	s form for proposals to II. Use form 3160-3 (API	drill or to re- D) for such p	enter an roposals.	<u> </u>	6. If Indian, Allottee or	Tribe N	lame
SUBMIT IN 1	TRIPLICATE - Other inst	tructions on	page 2		7. If Unit or CA/Agree	ment, N	ame and/or No.
1. Type of Well ☑ Oil Well ☐ Gas Well ☐ Oth					8. Well Name and No. WIGEON 23 FED	COM 4I	H
Name of Operator CIMAREX ENERGY COMPAN	Contact: NY OF C Đ -Mail: tstathem@	TERRI STAT	HEM		9. API Well No. 30-015-43156-0	0-X1	
3a. Address 202 S CHEYENNE AVE SUIT TULSA, OK 74103.4346	E 1000	3b. Phone No Ph: 432-62	. (include area code) 0-1936		10. Field and Pool or E WILDCAT 979/6 wc	•	-
4. Location of Well (Footage, Sec., T.	, R., M., or Survey Description)			979/6 WC	tate	Rone Sprin
Sec 23 T25S R26E NENE 305 32.071865 N Lat, 104.152660					EDDY COUNTY	, NM	
12. CHECK THE AF	PPROPRIATE BOX(ES)	TO INDICA	TE NATURE OI	F NOTICE,	REPORT, OR OTH	ER D	ATA
TYPE OF SUBMISSION			TYPE OF	ACTION			
Notice of Intent ■ Notice of Intent Notice of	☐ Acidize	☐ Dee	pen	☐ Producti	ion (Start/Resume)	□ W	ater Shut-Off
_	☐ Alter Casing	☐ Hyd	raulic Fracturing	☐ Reclama	ation	□ W	ell Integrity
☐ Subsequent Report	Casing Repair	New	Construction	□ Recomp	lete	Ot	ther
☐ Final Abandonment Notice	☐ Change Plans	□ Plug	and Abandon		arily Abandon		
·	Convert to Injection	Plug		□ Water D	-		
13. Describe Proposed or Completed Ope If the proposal is to deepen directions Attach the Bond under which the wor following completion of the involved testing has been completed. Final Ab determined that the site is ready for fi	ally or recomplete horizontally; rk will be performed or provide operations. If the operation re pandonment Notices must be fil	give subsurface the Bond No. or sults in a multipl	locations and measur file with BLM/BIA e completion or reco	red and true ve . Required sub mpletion in a r	rtical depths of all pertine psequent reports must be new interval, a Form 316	ent mark filed wit 0-4 must	kers and zones. thin 30 days t be filed once
Cimarex Energy respectfully re Com #4H well and future wells	equests approval of a nev s.	w off pad batt	ery for the Wigeo	n 23 Federa	al		
Please see the following attac infrastructure related plats for Exhibit B & J - Public access r Exhibit D - Location Layout	the proposed battery: oad map	for the propo	sed battery locat	ion and oth	Strategic C		ÎZÎPÎPÎ (1903) STRICT
Exhibit C-2 - Proposed new ac Exhibit G - Gas sales pipeline Exhibit I - SWD pipeline route Exhibit H - Powerline route	& gas buy back pipeline				API	₹ 1 0	2017
					R	CFN	Æ
14. I hereby certify that the foregoing is	true and correct. Electronic Submission # For CIMAREX ENE itted to AFMSS for process	RGY COMPA	NY OF CO, sent to	o the Carlsba	adĺ		
Name (Printed/Typed) TERRI ST	•	sing by DEBO			ATORY COMPLIAN	CE	
Signature (Electronic S			Date 01/02/20	017			
	THIS SPACE FO	OR FEDERA			SE		
Approved By Approved By	lastr		FOR F	LD MA	NAGER		Dale 4/13/17
Conditions of approval, if and, are attached certify that the applicant holds legal or equalified would entitle the applicant to conduct the conductions of the conduction of	ital e title to those rights in the	not warrant or e subject lease	BLN	1-CARL	SBAD FIELD	OFF	ICE

Title 18 U.S.C. Section 1001 and Title 43 U.S.C. Section 1212, make it a crime for any person knowingly and willfully to make to any department or agency of the United States any false, fictitious or fraudulent statements or representations as to any matter within its jurisdiction.

Additional data for EC transaction #362427 that would not fit on the form

32. Additional remarks, continued

Please see the following attached On-lease pipeline ROW plats from the Wigeon 23 Fed com #4H well to the proposed battery:

Exhibit G-1 - Flowline & Gas lift pipeline routes

Revisions to Operator-Submitted EC Data for Sundry Notice #362427

Operator Submitted

BLM Revised (AFMSS)

Sundry Type:

NEWCON

NOI

NEWCON

NOI

Lease:

NMNM26105

NMNM94839

Agreement:

Operator:

CIMAREX ENERGY COMPANY 202 S. CHEYENNE AVE, STE 1000 TULSA, OK 74103

Ph: 432-620-1936

CIMAREX ENERGY COMPANY OF CO 202 S CHEYENNE AVE SUITE 1000 TULSA, OK 74103.4346 Ph: 432.620.1936 Fx: 918.749.8059

Admin Contact:

TERRI STATHEM MANAGER REGULATORY COMPLIANCE

E-Mail: tstathem@cimarex.com

Ph: 432-620-1936

TERRI STATHEM MANAGER REGULATORY COMPLIANCE E-Mail: tstathem@cimarex.com

Ph: 432-620-1936

Tech Contact:

TERRI STATHEM

MANAGER REGULATORY COMPLIANCE

E-Mail: tstathem@cimarex.com

Ph: 432-620-1936

TERRI STATHEM

MANAGER REGULATORY COMPLIANCE

E-Mail: tstathem@cimarex.com

Ph: 432-620-1936

Location: State: County:

NM

EDDY

NM EDDY

Field/Pool:


WILDCAT WOLFCAMP

WILDCAT

Well/Facility:

WIGEON 23 FEDERAL COM 4H Sec 23 T25S R26E NENE 305FNL 757FEL

WIGEON 23 FED COM 4H Sec 23 T25S R26E NENE 305FNL 757FEL 32.071865 N Lat, 104.152660 W Lon

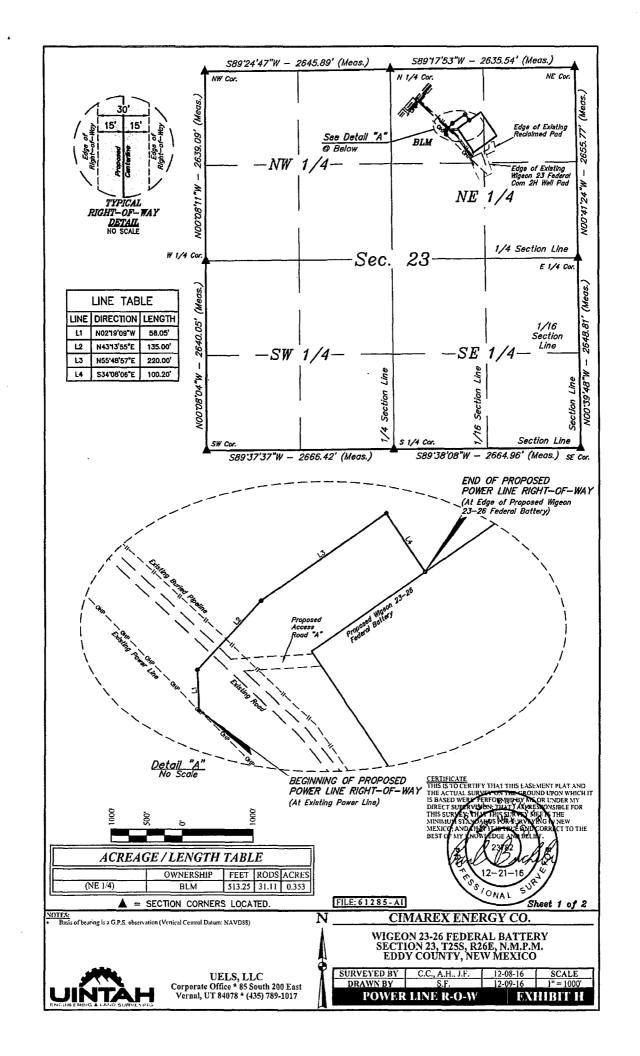

POWER LINE RIGHT-OF-WAY DESCRIPTION ON BLM LANDS

A 30' WIDE RIGHT-OF-WAY 15' ON EACH SIDE OF THE FOLLOWING DESCRIBED CENTERLINE.

BEGINNING AT A POINT IN THE NW 1/4 NE 1/4 OF SECTION 23, T25S, R26E, N.M.P.M., WHICH BEARS \$40'55'18"E 1204.59' FROM THE NORTH 1/4 CORNER OF SAID SECTION 23, THENCE N02'19'09"W 58.05'; THENCE N43'13'55"E 135.00'; THENCE N55'48'57"E 220.00'; THENCE \$34'08'06"E 100.20' TO A POINT IN THE NW 1/4 NE 1/4 OF SAID SECTION 23, WHICH BEARS \$40'55'18"E 1204.59' FROM THE NORTH 1/4 CORNER OF SAID SECTION 23. THE SIDE LINES OF SAID DESCRIBED RIGHT-OF-WAY BEING SHORTENED OR ELONGATED TO MEET THE GRANTOR'S PROPERTY LINES. BASIS OF BEARINGS IS A G.P.S. OBSERVATION. CONTAINS 0.353 ACRES MORE OR LESS.

BEGINNING OF POWER LINE BEARS \$40'55'18"E 1204.59' FROM THE NORTH 1/4 CORNER OF SECTION 23, T25S, R26E, N.M.P.M.

END OF POWER LINE BEARS S57'27'07"E 1325.57' FROM THE NORTH 1/4 CORNER OF SECTION 23, T25S, R26E, N.M.P.M.

WIGEON 23-26 FEDERAL BATTERY POWER LINE R-O-W				
SECTION CORNER	SECTION CORNER DESC.	LATITUDE (NAD 83)	LONGITUDE (NAD 83)	
NW COR. SEC. 23, T25S, R26E	1/2" IRON ROD	N 32°07'21.16"	W 104°15'19.24"	
N 1/4 COR. SEC. 23, T255, R26E	1.5" IRON PIPE WITH BRASS CAP	N 32°07'21.44"	W 104°15'48,48"	
NE COR. SEC. 23, T25S, R26E	2" IRON PIPE WITH BRASS CAP	N 32°07'21.76"	W 104°15'17.84"	
E 1/4 COR. SEC. 23, T25S, R26E	1.5" IRON PIPE WITH BRASS CAP	N 32°06'55.49"	W 104°15'17.47"	
SE COR. SEC. 23, T25S, R26E	2" IRON PIPE WITH BRASS CAP	N 32°06'29.28"	W 104°15'17.10"	
S 1/4 COR. SEC. 23, T255, R26E	1.5" IRON PIPE WITH BRASS CAP	N 32°06'29.11"	W 104°15'48.08"	
SW COR. SEC. 23, T25S, R26E	2" IRON PIPE WITH BRASS CAP	N 32"06'28.93"	W 104*16'19.08"	
W 1/4 COR. SEC. 23, T25S, R26E	1.5" IRON PIPE WITH BRASS CAP	N 32°06′55.05"	W 104°16'19.16"	

	WIGEON 23-26 FEDERAL BATTERY POWER LINE R-O-W					
NUMBER	STATION	LATITUDE (NAD 83)	LONGITUDE (NAD 83)			
BEGIN	0+00	N 32°07'12.43"	W 104°15'39.31"			
1	0+58.05	N 32°07'13.01"	W 104°15'39.33"			
2	1+93.05	N 32°07'13.98"	W 104°15'38.26"			
3	4+13.05	N 32°07'15.20"	W 104*15'36.14"			
END	5+13.25	N 32°07'14,38"	W 104°15'35.49"			

CERTIFICATE
THIS IS TO CERTIFY THAT THIS LASEMENT PLAY AND
THE ACTUAL SUBJECTION THE CROUND UPON WHICH IT
IS BASED WERE FERFOR EDBY IN OR LYDER MY
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Sheet 2 of 2


CIMAREX ENERGY CO.

SS/ONAL

WIGEON 23-26 FEDERAL BATTERY SECTION 23, T25S, R26E, N.M.P.M. EDDY COUNTY, NEW MEXICO



SURVEYED BY	C.C., A.H., J.F.	12-08-16	SCALE
DRAWN BY	S.F.	12-08-16	N/A
POWER	LINE R-O-W	EXI	HRIT H

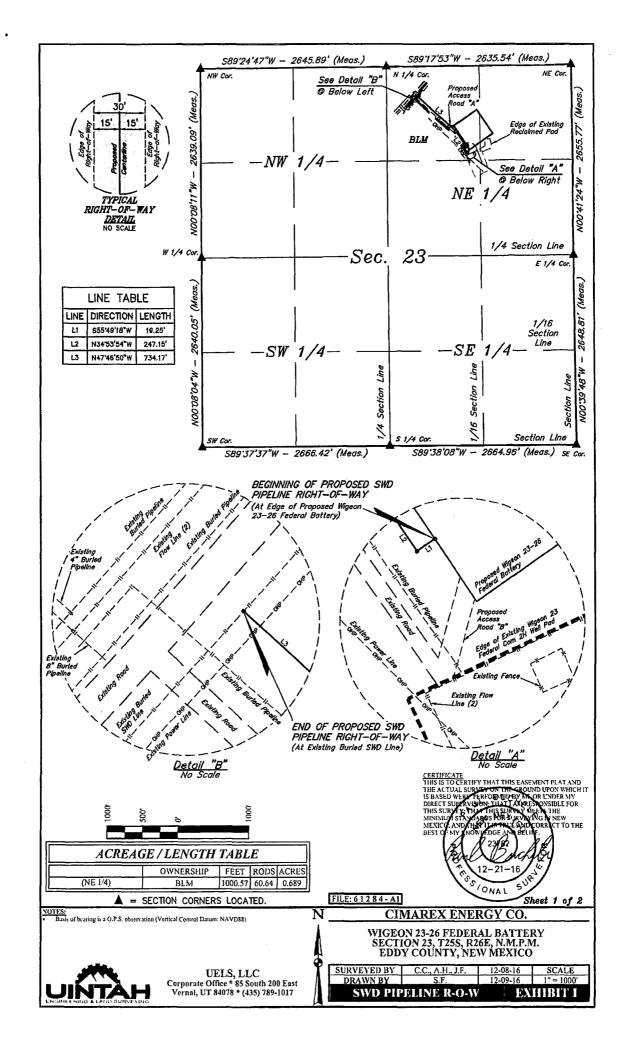

SWD PIPELINE RIGHT-OF-WAY DESCRIPTION ON BLM LANDS

A 30' WIDE RIGHT-OF-WAY 15' ON EACH SIDE OF THE FOLLOWING DESCRIBED CENTERLINE.

BEGINNING AT A POINT IN THE NW 1/4 NE 1/4 OF SECTION 23, T25S, R26E, N.M.P.M., WHICH BEARS S45'58'03"E 1584.65' FROM THE NORTH 1/4 CORNER OF SAID SECTION 23, THENCE S55'49'18"W 19.25'; THENCE N34'53'54"W 247.15'; THENCE N47'46'50"W 734.17' TO A POINT IN THE NW 1/4 NE 1/4 OF SAID SECTION 23, WHICH BEARS S46'28'37"E 604.39' FROM THE NORTH 1/4 CORNER OF SAID SECTION 23. THE SIDE LINES OF SAID DESCRIBED RIGHT-OF-WAY BEING SHORTENED OR ELONGATED TO MEET THE GRANTOR'S PROPERTY LINES. BASIS OF BEARINGS IS A G.P.S. OBSERVATION. CONTAINS 0.689 ACRES MORE OR LESS.

BEGINNING OF SWD PIPELINE BEARS S45'58'03"E 1584.65' FROM THE NORTH 1/4 CORNER OF SECTION 23, T25S, R26E, N.M.P.M.

END OF SWD PIPELINE BEARS \$46'28'37"E 604.39' FROM THE NORTH 1/4 CORNER OF SECTION 23, T25S, R26E, N.M.P.M.

WIGEON 23-26 FEDERAL BATTERY SWD PIPELINE R-O-W					
SECTION CORNER	SECTION CORNER DESC.	LATITUDE (NAD 83)	LONGITUDE (NAD 83)		
NW COR. SEC. 23, T255, R26E	1/2" IRON ROD	N 32°07'21.16"	W 104°16'19.24"		
N 1/4 COR. SEC. 23, T255, R26E	1.5" IRON PIPE WITH BRASS CAP	N 32°07'21.44"	W 104°15'48.48"		
NE COR. SEC. 23, T255, R26E	2" IRON PIPE WITH BRASS CAP	N 32°07'21.76"	W 104°15'17.84"		
E 1/4 COR. SEC. 23, T25S, R26E	1.5" IRON PIPE WITH BRASS CAP	N 32°06'55.49"	W 104°15'17.47"		
SE COR. SEC. 23, T25S, R26E	2" IRON PIPE WITH BRASS CAP	N 32°06'29.28"	W 104°15'17.10"		
S 1/4 COR. SEC. 23, T25S, R26E	1.5" IRON PIPE WITH BRASS CAP	N 32"06'29.11"	W 104°15'48.08"		
SW COR. SEC. 23, T25S, R26E	2" IRON PIPE WITH BRASS CAP	N 32°06'28.93"	W 104°16'19.08"		
W 1/4 COR. SEC. 23, T255, R26E	1.5" IRON PIPE WITH BRASS CAP	N 32°06'55.05"	W 104°16'19.16"		

	WIGEON 23-26 FEDERAL BATTERY SWD PIPELINE R-O-W					
NUMBER	STATION	LATITUDE (NAD 83)	LONGITUDE (NAD 83)			
BEGIN	0+00	N 32°07'10.54"	W 104°15'35.24"			
. 1	0+19.25	N 32°07'10.43"	W 104°15'35.42"			
2	2+66.40	N 32°07'12.44"	W 104°15'37.06"			
END	10+00.57	N 32°07'17.32"	W 104°15'43.39"			

CERTIFICATE
THIS IS TO CERTIFY THAT THIS EASEMENT PLAT AND
THE ACTUAL SURVEY OF THE CROUND UPON WHICH IS
BASED WERE TERPOIS DUPLY MORE CUNDER MY
DIRECT SUPPRISHED. THAT TAY SUPSIGNABLE FOR
THIS SURVEY, THAT THIS SUPPRISHED SHE THE
MINIMUM STAYON SOS PROSE REVENING IN NEW
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12-21-16


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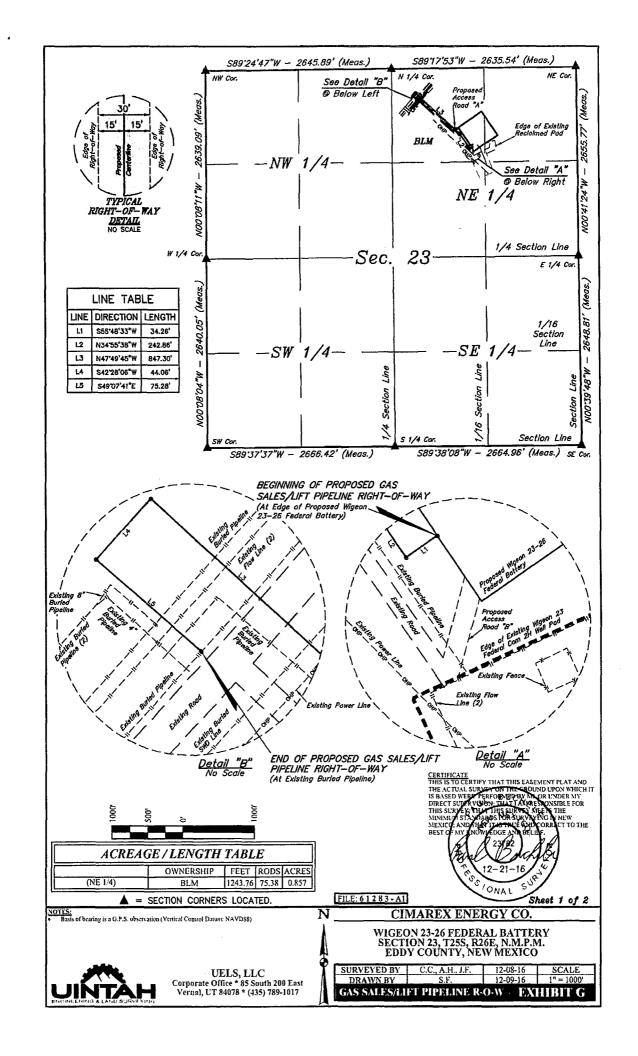
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CIMAREX ENERGY CO.

WIGEON 23-26 FEDERAL BATTERY SECTION 23, T25S, R26E, N.M.P.M. EDDY COUNTY, NEW MEXICO





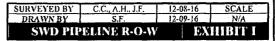

GAS SALES/LIFT PIPELINE RIGHT-OF-WAY DESCRIPTION ON BLM LANDS

A 30' WIDE RIGHT-OF-WAY 15' ON EACH SIDE OF THE FOLLOWING DESCRIBED CENTERLINE.

BEGINNING AT A POINT IN THE NW 1/4 NE 1/4 OF SECTION 23, T25S, R26E, N.M.P.M., WHICH BEARS \$45'59'34"E 1581.31' FROM THE NORTH 1/4 CORNER OF SAID SECTION 23, THENCE \$55'48'33"W 34.26'; THENCE N34'55'38"W 242.86'; THENCE N47'49'45"W 847.30'; THENCE \$42'28'06"W 44.06'; THENCE \$49'07'41"E 75.28' TO A POINT IN THE NW 1/4 NE 1/4 OF SAID SECTION 23, WHICH BEARS \$40'32'14"E 568.01' FROM THE NORTH 1/4 CORNER OF SAID SECTION 23. THE SIDE LINES OF SAID DESCRIBED RIGHT—OF—WAY BEING SHORTENED OR ELONGATED TO MEET THE GRANTOR'S PROPERTY LINES. BASIS OF BEARINGS IS A G.P.S. OBSERVATION. CONTAINS 0.857 ACRES MORE OR LESS.

BEGINNING OF GAS SALES/LIFT PIPELINE BEARS \$45'59'34"E 1581.31' FROM THE NORTH 1/4 CORNER OF SECTION 23, T25S, R26E, N.M.P.M.

END OF GAS SALES/LIFT PIPELINE BEARS S40'32'14"E 568.01' FROM THE NORTH 1/4 CORNER OF SECTION 23, T25S, R26E, N.M.P.M.

WIGEON 23-26 FEDERAL BATTERY GAS SALES/LIFT PIPELINE R-O-W					
SECTION CORNER	SECTION CORNER DESC.	LATITUDE (NAD 83)	LONGITUDE (NAD 83)		
NW COR. SEC. 23, T25S, R26E	1/2" IRON ROD	N 32°07'21.16"	W 104°16'19.24"		
N 1/4 COR. SEC. 23, T25S, R26E	1.5" IRON PIPE WITH BRASS CAP	N 32°07'21.44"	W 104°15'48.48"		
NE COR. SEC. 23, T255, R26E	2" IRON PIPE WITH BRASS CAP	N 32°07'21.76"	W 104°15'17.84"		
E 1/4 COR. SEC. 23, T25S, R26E	1.5" IRON PIPE WITH BRASS CAP	N 32°06'55.49"	W 104°15'17.47"		
SE COR. SEC. 23, T25S, R26E	2" IRON PIPE WITH BRASS CAP	N 32*06'29.28"	W 104°15'17.10"		
S 1/4 COR. SEC. 23, T25S, R26E	1.5" IRON PIPE WITH BRASS CAP	N 32°06'29.11"	W 104°15'48.08"		
SW COR. SEC. 23, T25S, R26E	2" IRON PIPE WITH BRASS CAP	N 32°06'28.93"	W 104°16'19.08"		
W 1/4 COR. SEC. 23, T255, R26E	1.5" IRON PIPE WITH BRASS CAP	N 32°06'55.05"	W 104°16'19.16"		

NUMBER	STATION	LATITUDE (NAD 83)	LONGITUDE (NAD 83
BEGIN	0+00	N 32°07'10.57"	W 104°15'35.26"
1	0+34.26	N 32°07'10.38"	W 104°15'35.59"
2	2+77.12	N 32*07'12.35"	W 104°15'37.20"
3	11+24.42	N 32°07'17.97"	W 104°15'44.51"
4	11+68.48	N 32°07'17.65"	W 104°15'44.85"
END	12+43.76	N 32°07'17.17"	W 104°15'44.19"

CERTIFICATE
THIS IS TO CERTIFY THAT THIS EASEMENT PLAT AND
THE ACTUAL SURVEY ON THE BOUND UPON WHICH IT
IS BASED WERE PERFORMED BY MA OR KINDER MY
DIRECT SUBPLICATION THAT TAKES DONSIBLE FOR
THIS SURVEY THAT THIS SURVEY MEET THE
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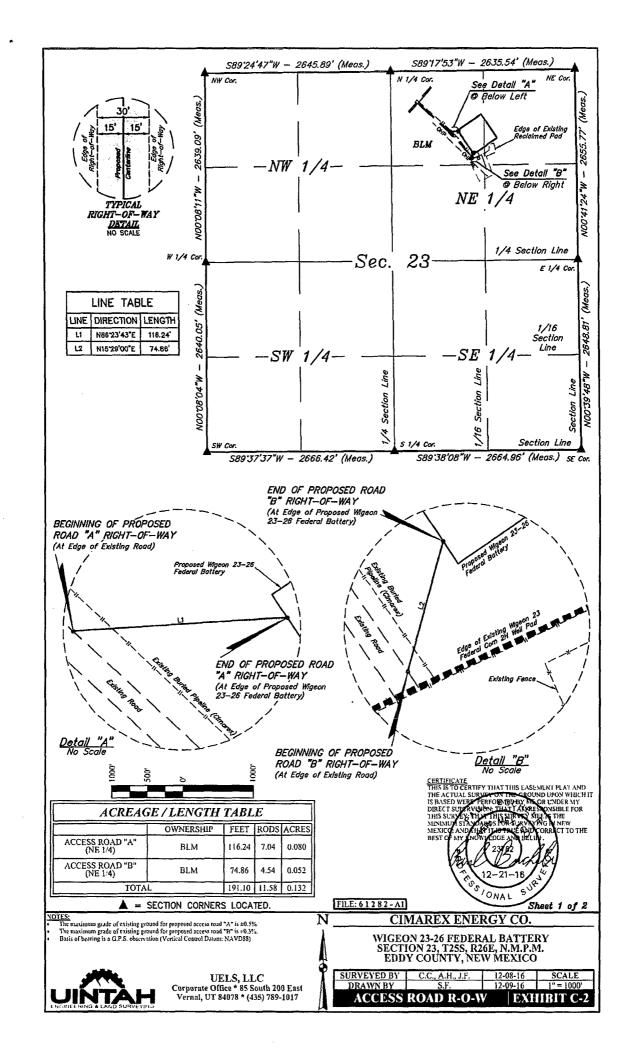
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CIMAREX ENERGY CO.

WIGEON 23-26 FEDERAL BATTERY SECTION 23, T25S, R26E, N.M.P.M. EDDY COUNTY, NEW MEXICO



SURVEYED BY	C.C., A.H., J.F.	12-08-16	SCALE
DRAWN BY	S.F.	12-09-16	N/A
GAS SALES/LI	FT PIPELINE R-	O-W EX	HIBIT G



ROAD "A" RIGHT-OF-WAY DESCRIPTION

A 30' WIDE RIGHT-OF-WAY 15' ON EACH SIDE OF THE FOLLOWING DESCRIBED CENTERLINE.

BEGINNING AT A POINT IN THE NW 1/4 NE 1/4 OF SECTION 23, T25S, R26E, N.M.P.M., WHICH BEARS S44'5B'12"E 1194.57' FROM THE NORTH 1/4 CORNER OF SAID SECTION 23, THENCE NB6'23'43"E 116.24' TO A POINT IN THE NW 1/4 NE 1/4 OF SAID SECTION 23, WHICH BEARS S48'53'44"E 1274,38' FROM THE NORTH 1/4 CORNER OF SAID SECTION 23. THE SIDE LINES OF SAID DESCRIBED RIGHT—OF—WAY BEING SHORTENED OR ELONGATED TO MEET THE GRANTOR'S PROPERTY LINES. BASIS OF BEARINGS IS A G.P.S. OBSERVATION. CONTAINS 0.080 ACRES MORE OR LESS.

BEGINNING OF ROAD "A" BEARS \$44'58'12"E 1194.57' FROM THE NORTH 1/4 CORNER OF SECTION 23, T25S, R26E, N.M.P.M.

END OF ROAD "A" BEARS S48'53'44"E 1274.38' FROM THE NORTH 1/4 CORNER OF SECTION 23, T25S, R26E, N.M.P.M.

ROAD "B" RIGHT-OF-WAY DESCRIPTION

A 30' WIDE RIGHT-OF-WAY 15' ON EACH SIDE OF THE FOLLOWING DESCRIBED CENTERLINE.

BEGINNING AT A POINT IN THE NW 1/4 NE 1/4 OF SECTION 23, T25S, R26E, N.M.P.M., WHICH BEARS S43'21'10"E 1672.74' FROM THE NORTH 1/4 CORNER OF SAID SECTION 23, THENCE N15'29'00"E 74.86' TO A POINT IN THE NW 1/4 NE 1/4 OF SAID SECTION 23, WHICH BEARS S45'35'51"E 1635.26' FROM THE NORTH 1/4 CORNER OF SAID SECTION 23. THE SIDE LINES OF SAID DESCRIBED RIGHT-OF-WAY BEING SHORTENED OR ELONGATED TO MEET THE GRANTOR'S PROPERTY LINES. BASIS OF BEARINGS IS A G.P.S. OBSERVATION. CONTAINS 0.052 ACRES MORE OR LESS.

BEGINNING OF ROAD "B" BEARS \$43'21'10"E 1672.74' FROM THE NORTH 1/4 CORNER OF SECTION 23, T25S, R26E, N.M.P.M.

END OF ROAD "B" BEARS $$45^{\circ}35^{\circ}51"E$ 1635.26' FROM THE NORTH 1/4 CORNER OF SECTION 23, T25S, R26E, N.M.P.M.

WIGEON 23-26 FEDERAL BATTERY ACCESS ROAD R-O-W				
SECTION CORNER	SECTION CORNER DESC.	LATITUDE (NAD 83)	LONGITUDE (NAD 83)	
NW COR. SEC. 23, T255, R26E	1/2" IRON ROD	N 32°07'21.16"	W 104°16'19.24"	
N 1/4 COR. SEC. 23, T25S, R26E	1.5" IRON PIPE WITH BRASS CAP	N 32°07'21.44"	W 104°15'48.48"	
NE COR. SEC. 23, T255, R26E	2" IRON PIPE WITH BRASS CAP	N 32°07'21.76"	W 104°15'17.84"	
E 1/4 COR. SEC. 23, T255, R26E	1.5" IRON PIPE WITH BRASS CAP	N 32°06'55.49"	W 104°15'17.47"	
SE COR. SEC. 23, T25S, R26E	2" IRON PIPE WITH BRASS CAP	N 32°06'29.28"	W 104°15'17.10"	
S 1/4 COR. SEC. 23, T255, R26E	1.5" IRON PIPE WITH BRASS CAP	N 32*06'29.11"	W 104°15'48.08"	
SW COR. SEC. 23, T25S, R26E	2" IRON PIPE WITH BRASS CAP	N 32°06'28.93"	W 104°16'19.08"	
W 1/4 COR. SEC. 23, T25S, R26E	1.5" IRON PIPE WITH BRASS CAP	N 32"06'55.05"	W 104°16'19.16"	

\	WIGEON 23-26 FEDERAL BATTERY ACCESS ROAD R-O-W "A"				
NUMBER STATION LATITUDE (NAD 83) LONGITUDE (NAD 83)					
BEGIN	0+00	N 32°07'13.08"	W 104°15'38.67"		
END	1+16.24	N 32°07'13.15"	W 104°15'37.32"		

WIGEON 23-26 FEDERAL BATTERY ACCESS ROAD R-O-W "B"			
NUMBER	STATION	LATITUDE (NAD 83)	LONGITUDE (NAD 83)
BEGIN	0+00	N 32°07'09.40"	W 104°15'35.13"
END	0+74.86	N 32°07'10.12"	W 104°15'34.90"

CERTIFICATE
THIS IS TO CERTIFY THAT THIS EASEMENT PLAT AND
THE ACTUAL SURVEY OF THE GROUND UPON WHICH IT
IS BASED WEST FERFOR 10-89. AND RUNDER MY
DIRECT SURVEY OF THAT A MARE NONSIBLE FOR
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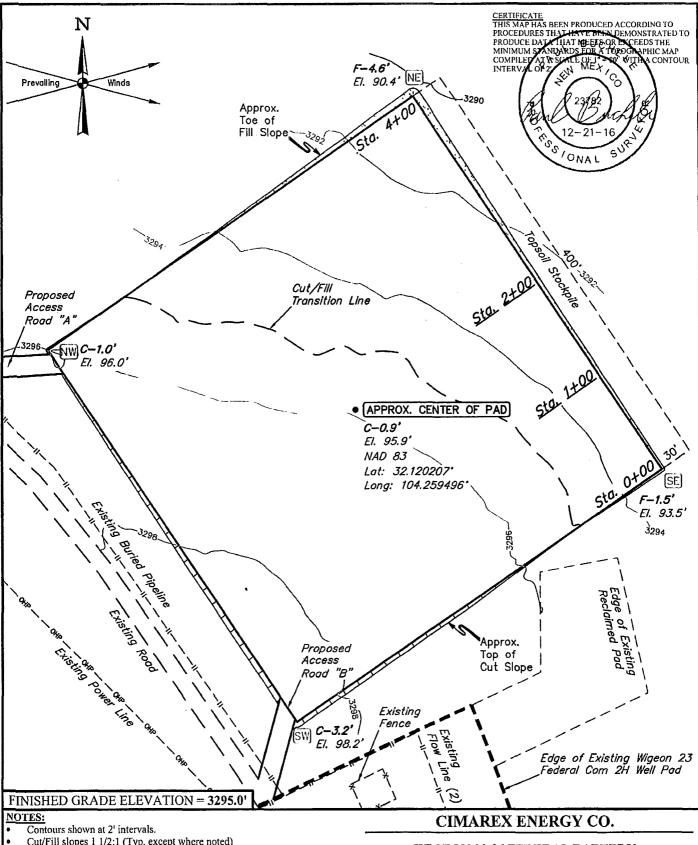
Sheet 2 of 2

CIMAREX ENERGY CO.

WIGEON 23-26 FEDERAL BATTERY SECTION 23, T25S, R26E, N.M.P.M. EDDY COUNTY, NEW MEXICO



SURVEYED BY	C.C., A.H., J.F.	12-08-16	SCALE
DRAWN BY	S.F.	12-09-16	N/A
ACCESS	ROAD R-O-W	EXI	HBIT C-2




- Cut/Fill slopes 1 1/2:1 (Typ. except where noted)
- Underground utilities shown on this sheet are for visualization purposes only, actual locations to be determined prior to construction.



UELS, LLC Corporate Office * 85 South 200 East Vernal, UT 84078 * (435) 789-1017

WIGEON 23-26 FEDERAL BATTERY N 1/2 NE 1/4, SECTION 23, T25S, R26E, N.M.P.M. EDDY COUNTY, NEW MEXICO

LOCATI	ON LAYOUT	EX	HIBIT D
DRAWN BY	S.F.	12-09-16	1" = 80'
SURVEYED BY	C.C., A.H., J.F.	12-08-16	SCALE

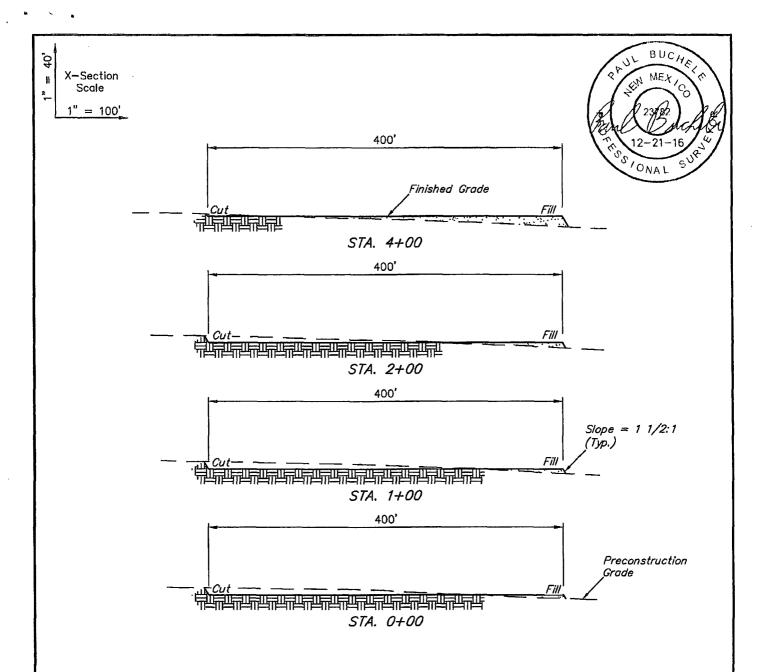

APPROXIMATE EARTHWORK QUANTITIES			
(4") TOPSOIL STRIPPING	2,040 Cu. Yds.		
REMAINING LOCATION	4,680 Cu. Yds.		
TOTAL CUT	6,720 Cu. Yds.		
FILL	4,680 Cu. Yds.		
EXCESS MATERIAL	2,040 Cu. Yds.		
TOPSOIL	2,040 Cu. Yds.		
EXCESS UNBALANCE (After Interim Rehabilitation)	0 Cu. Yds.		

	DISTANCE	ACRES
WELL SITE DISTURBANCE	NA	±4.034
30' WIDE ACCESS ROAD R-O-W DISTURBANCE	±191.10'	±0.132
30' WIDE SALES/GAS LIFT PIPELINE R-O-W DISTURBANCE	±1,243.76'	±0.857
30' WIDE SWD PIPELINE R-O-W DISTURBANCE	±1,000.57'	±0.689
30' WIDE POWER LINE R-O-W DISTURBANCE	±513.25'	±0.353
TOTAL SURFACE USE AREA		±6.065

NOTES


- Fill quantity includes 5% for compaction.
- Cut/Fill slopes 1 1/2:1 (Typ. except where noted)

CIMAREX ENERGY CO.

WIGEON 23-26 FEDERAL BATTERY N 1/2 NE 1/4, SECTION 23, T25S, R26E, N.M.P.M. EDDY COUNTY, NEW MEXICO





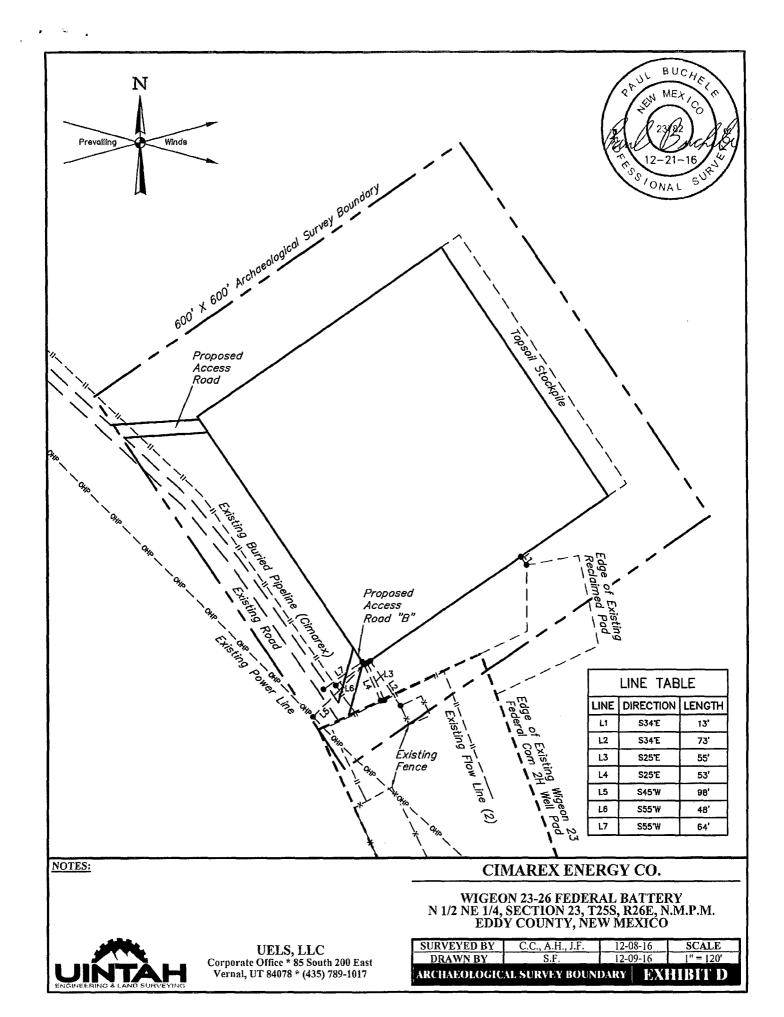

BEGINNING AT THE INTERSECTION OF OLD CAVERN HIGHWAY AND AN EXISTING ROAD TO THE WEST LOCATED IN THE NW 1/4 OF SECTION 18, T25S, R27E, N.M.P.M. PROCEED IN A WESTERLY, THEN NORTHWESTERLY DIRECTION APPROXIMATELY 0.9 MILES TO THE JUNCTION OF THIS ROAD AND AN EXISTING ROAD TO THE WEST; TURN LEFT AND PROCEED IN A WESTERLY, THEN SOUTHWESTERLY DIRECTION APPROXIMATELY 1.1 MILES TO THE JUNCTION OF THIS ROAD AND AN EXISTING ROAD TO THE SOUTHEAST; TURN LEFT AND PROCEED IN A SOUTHEASTERLY DIRECTION APPROXIMATELY 0.1 MILES TO THE BEGINNING OF THE PROPOSED ACCESS ROAD TO THE EAST; FOLLOW ROAD FLAGS IN AN EASTERLY DIRECTION APPROXIMATELY 116' TO THE PROPOSED LOCATION.


TOTAL DISTANCE FROM THE INTERSECTION OF OLD CAVERN HIGHWAY AND AN EXISTING ROAD TO THE WEST LOCATED IN THE NW 1/4 OF SECTION 18, T25S, R27E, N.M.P.M. TO THE PROPOSED WELL LOCATION IS APPROXIMATELY 2.1 MILES.


CIMAREX ENERGY CO.

WIGEON 23-26 FEDERAL BATTERY N 1/2 NE 1/4, SECTION 23, T25S, R26E, N.M.P.M. EDDY COUNTY, NEW MEXICO



SURVEYED BY	C.C, A.H., J.F.	12-08-16	
DRAWN BY	J.L.G.	12-16-16	
ROAD DE	ESCRIPTIO	N EX	HIBIT J

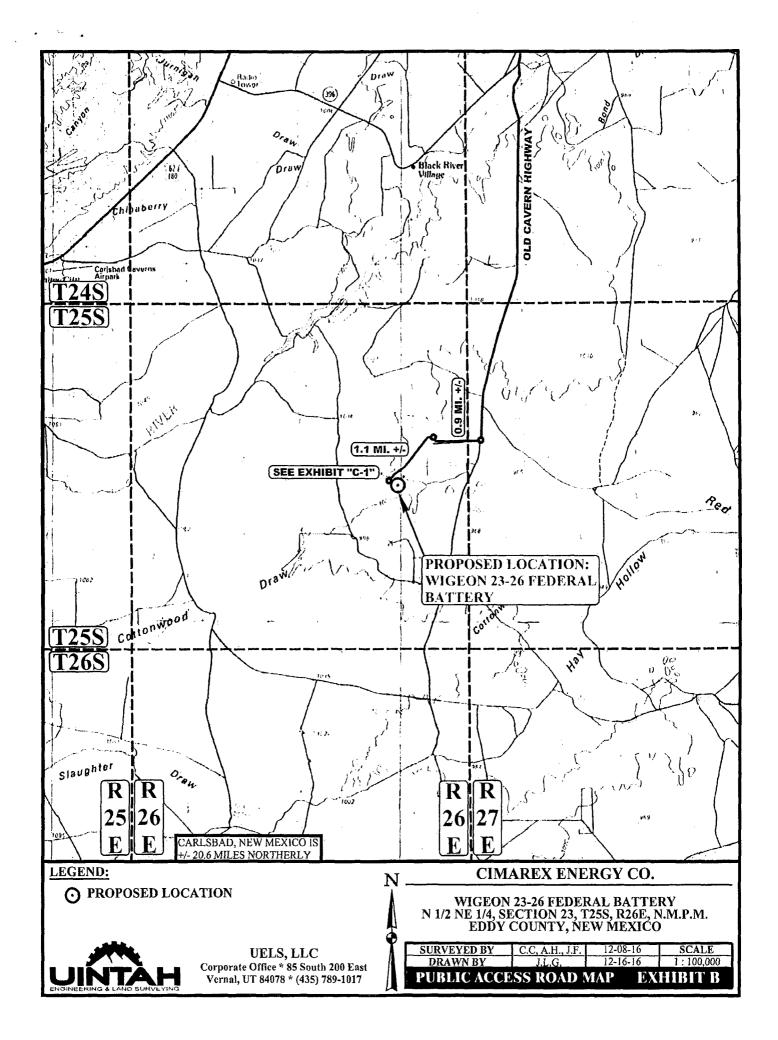

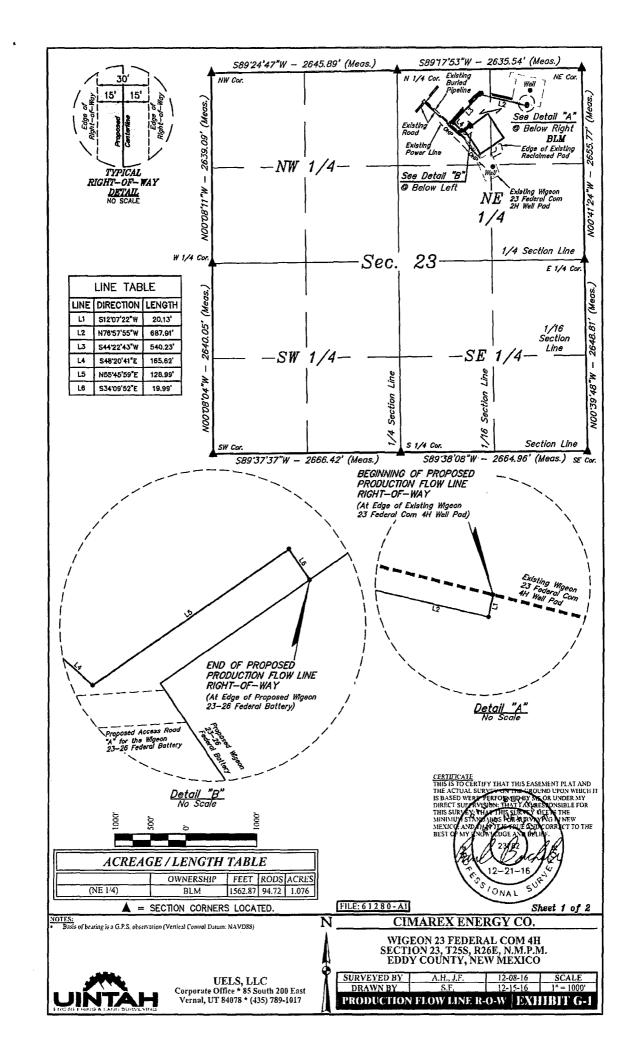

PRODUCTION FLOW LINE RIGHT-OF-WAY DESCRIPTION

A 30' WIDE RIGHT-OF-WAY 15' ON EACH SIDE OF THE FOLLOWING DESCRIBED CENTERLINE.

BEGINNING AT A POINT IN THE NE 1/4 NE 1/4 OF SECTION 23, T25S, R26E, N.M.P.M., WHICH BEARS S57'49'37"W 935.31' FROM THE NORTHEAST CORNER OF SAID SECTION 23, THENCE S12'07'22"W 20.13'; THENCE N76'57'55"W 687.91'; THENCE S44'22'43"W 540.23'; THENCE S48'20'41"E 165.62'; THENCE N55'45'59"E 128.99'; THENCE S34'09'52"E 19.99' TO A POINT IN THE NW 1/4 NE 1/4 OF SAID SECTION 23, WHICH BEARS S53'17'01"E 1288.70' FROM THE NORTH 1/4 CORNER OF SAID SECTION 23. THE SIDE LINES OF SAID DESCRIBED RIGHT—OF—WAY BEING SHORTENED OR ELONGATED TO MEET THE GRANTOR'S PROPERTY LINES. BASIS OF BEARINGS IS A G.P.S. OBSERVATION. CONTAINS 1.076 ACRES MORE OR LESS.

BEGINNING OF PRODUCTION FLOW LINE BEARS S57'49'37"W 935.31' FROM THE NORTHEAST CORNER OF SECTION 23, T25S, R26E, N.M.P.M.

END OF PRODUCTION FLOW LINE BEARS \$53"17"01"E 1288.70' FROM THE NORTH 1/4 CORNER OF SECTION 23, T25S, R26E, N.M.P.M.

	WIGEON 23 FEDERAL COM 4H PRO	DUCTION FLOW LINE R-O-W	
SECTION CORNER	SECTION CORNER DESC.	LATITUDE (NAD 83)	LONGITUDE (NAD 83)
NW COR. SEC. 23, T255, R26E	1/2" IRON ROD	N 32°07'21.16"	W 104°16'19.24"
N 1/4 COR. SEC. 23, T25S, R26E	1.5" IRON PIPE WITH BRASS CAP	N 32°07'21.44"	W 104°15'48.48"
NE COR. SEC. 23, T25S, R26E	2" IRON PIPE WITH BRASS CAP	N 32°07'21.76"	W 104°15'17.84"
E 1/4 COR. SEC. 23, T25S, R26E	1.5" IRON PIPE WITH BRASS CAP	N 32°06'55.49"	W 104°15'17.47"
SE COR. SEC. 23, T25S, R26E	2" IRON PIPE WITH BRASS CAP	N 32°06'29.28"	W 104°15'17.10"
S 1/4 COR. SEC. 23, T25S, R26E	1.5" IRON PIPE WITH BRASS CAP	N 32°06'29.11"	W 104°15'48.08"
SW COR. SEC. 23, T25S, R26E	2" IRON PIPE WITH BRASS CAP	N 32°06'28.93"	W 104°16'19.08"
W 1/4 COR. SEC. 23, T25S, R26E	1.5" IRON PIPE WITH BRASS CAP	N 32°06'55.05"	W 104°16'19.16"

	WIGEON 23 FEDERAL COM 4H PRODUCTION LINE R-O-W				
NUMBER	STATION	LATITUDE (NAD 83)	LONGITUDE (NAD 83)		
BEGIN	0+00	N 32°07'16.83"	W 104°15'27.05"		
1	0+20.13	N 32'07'16.64"	W 104°15′27.10"		
2	7+08.04	N 32°07'18.17"	W 104°15'34.89"		
3	12+48.27	N 32°07'14.35"	W 104°15'39.28"		
4	14+13.89	N 32*07'13.26"	W 104°15'37.84"		
5	15+42.88	N 32°07'13.98"	W 104°15'36.60"		
END	15+62.87	N 32°07'13.81"	W 104°15'36.47"		

CERTIFICATE
THIS IS TO CERTIFY THAT THIS EASEMENT PLAT AND
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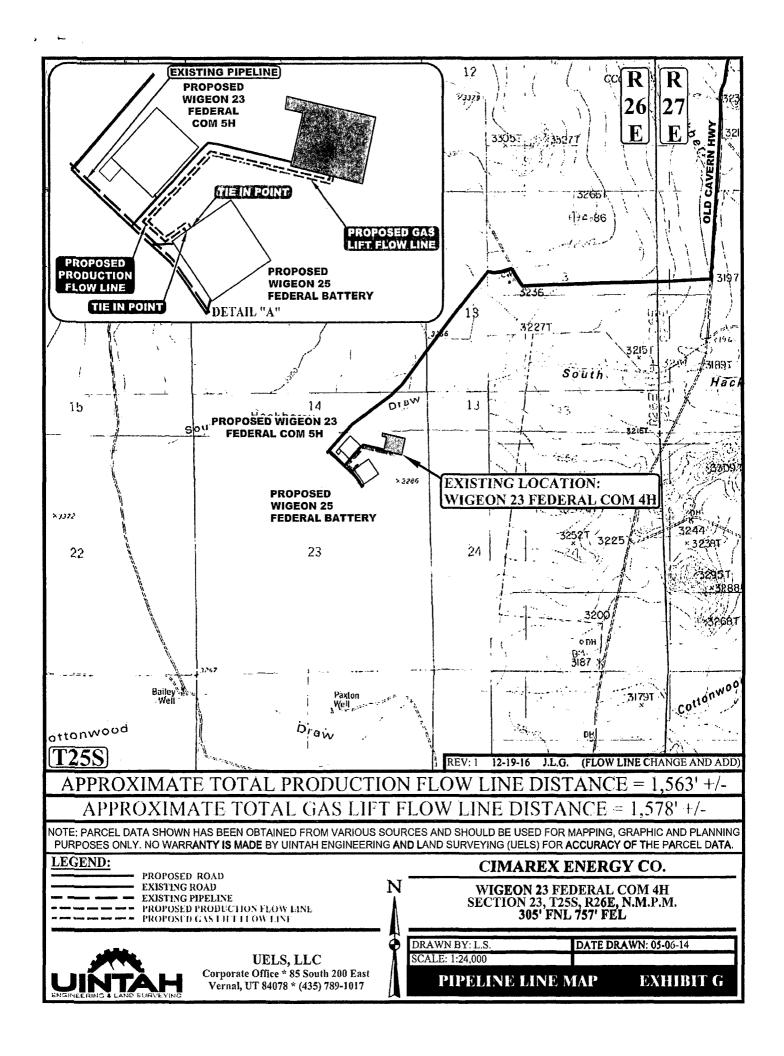
Sheet 2 of 2


CIMAREX ENERGY CO.

WIGEON 23 FEDERAL COM 4H SECTION 23, T25S, R26E, N.M.P.M. EDDY COUNTY, NEW MEXICO



SURVEYED BY	A.H., J.F.	12-08-16	SCALE
DRAWN BY	\$.F,	12-15-16	N/A
PRODUCTION	FLOW LINE R	-0-w EXI	HBIT G-1



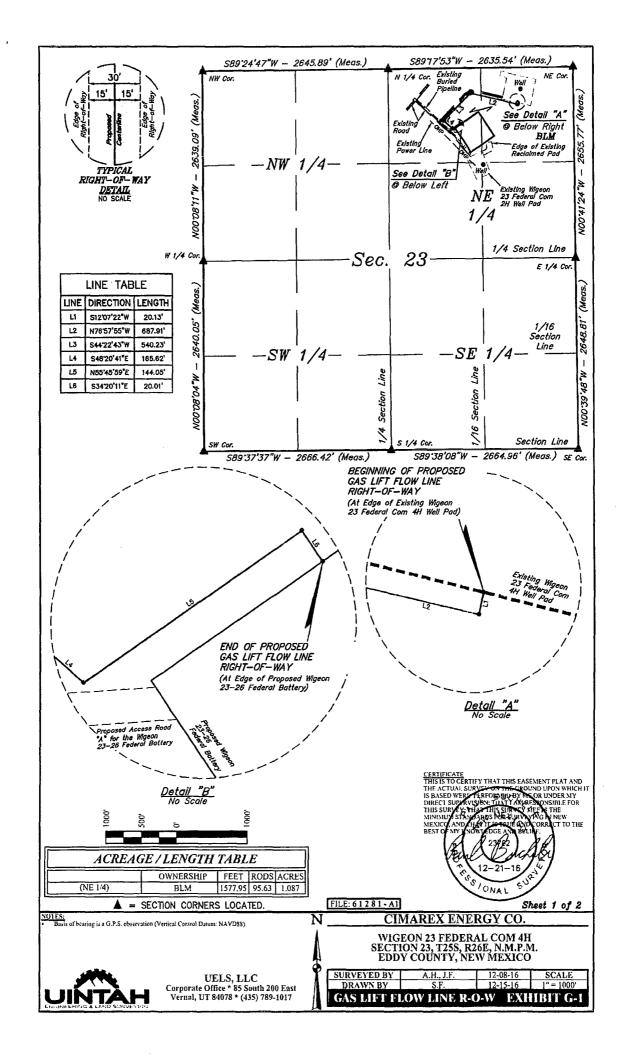

GAS LIFT FLOW LINE RIGHT-OF-WAY DESCRIPTION

A 30' WIDE RIGHT-OF-WAY 15' ON EACH SIDE OF THE FOLLOWING DESCRIBED CENTERLINE.

BEGINNING AT A POINT IN THE NE 1/4 NE 1/4 OF SECTION 23, T25S, R26E, N.M.P.M., WHICH BEARS S57'49'37"W 935.31' FROM THE NORTHEAST CORNER OF SAID SECTION 23, THENCE S12'07'22"W 20.13'; THENCE N76'57'55"W 687.91'; THENCE S44'22'43"W 540.23'; THENCE S48'20'41"E 165.62'; THENCE N55'45'59"E 144.05'; THENCE S34'20'11"E 20.01' TO A POINT IN THE NW 1/4 NE 1/4 OF SAID SECTION 23, WHICH BEARS S53'55'00"E 1293.72' FROM THE NORTH 1/4 CORNER OF SAID SECTION 23. THE SIDE LINES OF SAID DESCRIBED RIGHT-OF-WAY BEING SHORTENED OR ELONGATED TO MEET THE GRANTOR'S PROPERTY LINES. BASIS OF BEARINGS IS A G.P.S. OBSERVATION. CONTAINS 1.087 ACRES MORE OR LESS.

BEGINNING OF GAS LIFT FLOW LINE BEARS S57'49'37"W 935.31' FROM THE NORTHEAST CORNER OF SECTION 23, T25S, R26E, N.M.P.M.

END OF GAS LIFT FLOW LINE BEARS S53'55'00"E 1293.72' FROM THE NORTH 1/4 CORNER OF SECTION 23, T25S, R26E, N.M.P.M.

	WIGEON 23 FEDERAL COM 4H G	SAS LIFT FLOW LINE R-O-W	
SECTION CORNER	SECTION CORNER DESC.	LATITUDE (NAD 83)	LONGITUDE (NAD 83)
NW COR. SEC. 23, T255, R26E	1/2" IRON ROD	N 32°07'21.16"	W 104°16'19.24"
N 1/4 COR. SEC. 23, T25S, R26E	1.5" IRON PIPE WITH BRASS CAP	N 32°07'21,44"	W 104°15'48.48"
NE COR. SEC. 23, T25S, R26E	2" IRON PIPE WITH BRASS CAP	N 32°07'21.76"	W 104°15'17.84"
E 1/4 COR. SEC. 23, T25S, R26E	1.5" IRON PIPE WITH BRASS CAP	N 32°06'55.49"	W 104*15'17.47"
SE COR. SEC. 23, T25S, R26E	2" IRON PIPE WITH BRASS CAP	N 32°06'29.28"	W 104°15'17.10"
S 1/4 COR. SEC. 23, T25S, R26E	1.5" IRON PIPE WITH BRASS CAP	N 32°06'29.11"	W 104°15'48.08"
SW COR. SEC. 23, T25S, R26E	2" IRON PIPE WITH BRASS CAP	N 32°06'28.93"	W 104°16'19.08"
W 1/4 COR. SEC. 23, T25S, R26E	1.5" IRON PIPE WITH BRASS CAP	N 32°06'55.05"	W 104°16'19.16"

WIGEON 23 FEDERAL COM 4H GAS LIFT FLOW LINE R-O-W				
NUMBER	STATION	LATITUDE (NAD 83)	LONGITUDE (NAD 83	
BEGIN	0+00	N 32°07'16.83"	W 104°15'27.05"	
1	0+20.13	N 32°07'16.64"	W 104°15'27.10"	
2	7+08.04	N 32°07'18.17"	W 104°15'34.89"	
3	12+48.27	N 32°07'14.35"	W 104°15'39.28"	
4	14+13.89	N 32°07'13.26"	W 104°15'37.84"	
5	15+57.94	N 32*07'14.06"	W 104°15'36.46"	
END	15+77.95	N 32°07'13.90"	W 104°15'36.33"	

CERTIFICATE
THIS IS TO CERTIFY THAT THIS EASEMENT PLAT AND
THE ACTUAL SURVEY TO THE CROUND UPON WHICH IT
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CIMAREX ENERGY CO.

WIGEON 23 FEDERAL COM 4H SECTION 23, T25S, R26E, N.M.P.M. EDDY COUNTY, NEW MEXICO



SURVEYED BY	۸.H., J.F.	12-08-16	SCALE
DRAWN BY	S.F.	12-15-16	NIA
GAS LIFT FI	OW LINE R-O-W EXHIBIT		HBIT G-1

BLM LEASE NUMBER: COMPANY NAME: ASSOCIATED WELL NAME:

BURIED PIPELINE STIPULATIONS

A copy of the application (Grant, APD, or Sundry Notice) and attachments, including conditions of approval, survey plat and/or map, will be on location during construction. BLM personnel may request to you a copy of your permit during construction to ensure compliance with all stipulations.

Holder agrees to comply with the following stipulations to the satisfaction of the Authorized Officer:

- 1. The Holder shall indemnify the United States against any liability for damage to life or property arising from the occupancy or use of public lands under this grant.
- 2. The Holder shall comply with all applicable Federal laws and regulations existing or hereafter enacted or promulgated. In any event, the holder shall comply with the Toxic Substances Control Act of 1976 as amended, 15 USC 2601 et seq. (1982) with regards to any toxic substances that are used, generated by or stored on the right-of-way or on facilities authorized under this right-of-way grant. (See 40 CFR Part 702-799 and especially, provisions on polychlorinated biphenyls, 40 CFR 761.1-761.193.) Additionally, any release of toxic substances (leaks, spills, etc.) in excess of the reportable quantity established by 40 CFR Part 117 shall be reported as required by the Comprehensive Environmental Response, Compensation, and Liability Act, section 102b. A copy of any report required or requested by any Federal agency or State government as a result of a reportable release or spill of any toxic substances shall be furnished to the authorized officer concurrent with the filing of the reports to the involved Federal agency or State government.
- 3. The holder agrees to indemnify the United States against any liability arising from the release of any hazardous substance or hazardous waste (as these terms are defined in the Comprehensive Environmental Response, Compensation and Liability Act of 1980, 42 U.S.C. 9601, et seq. or the Resource Conservation and Recovery Act, 42 U.S.C.6901, et seq.) on the Right-of-Way (unless the release or threatened release is wholly unrelated to the Right-of-Way holder's activity on the Right-of-Way), or resulting from the activity of the Right-of-Way holder on the Right-of-Way. This agreement applies without regard to whether a release is caused by the holder, its agent, or unrelated third parties.
- 4. If, during any phase of the construction, operation, maintenance, or termination of the pipeline, any oil or other pollutant should be discharged from the pipeline system, impacting Federal lands, the control and total removal, disposal, and cleaning up of such oil or other pollutant, wherever found, shall be the responsibility of holder, regardless of fault. Upon failure of holder to control, dispose of, or clean up such discharge on or affecting Federal lands, or to repair all damages resulting therefrom, on the Federal lands, the Authorized Officer may take such measures as he deems necessary to control and clean up the discharge and restore the area, including where appropriate, the aquatic environment and fish and wildlife habitats, at the full expense of the holder. Such action by the Authorized Officer shall not relieve holder of any responsibility as provided herein.

5. All construction and maintenance activity will be confined to the authorized right-of-way. 6. The pipeline will be buried with a minimum cover of 36 inches between the top of the pipe and ground level. 7. The maximum allowable disturbance for construction in this right-of-way will be 30 feet: • Blading of vegetation within the right-of-way will be allowed: maximum width of blading operations will not exceed **20** feet. The trench is included in this area. (*Blading* is defined as the complete removal of brush and ground vegetation.) • Clearing of brush species within the right-of-way will be allowed: maximum width of clearing operations will not exceed 30 feet. The trench and bladed area are included in this area. (Clearing is defined as the removal of brush while leaving ground vegetation (grasses, weeds, etc.) intact. Clearing is best accomplished by holding the blade 4 to 6 inches above the ground surface.) The remaining area of the right-of-way (if any) shall only be disturbed by compressing the vegetation. (Compressing can be caused by vehicle tires, placement of equipment, etc.) 8. The holder shall stockpile an adequate amount of topsoil where blading is allowed. The topsoil to be stripped is approximately 6 inches in depth. The topsoil will be segregated from other spoil piles from trench construction. The topsoil will be evenly distributed over the bladed area for the preparation of seeding. 9. The holder shall minimize disturbance to existing fences and other improvements on public lands. The holder is required to promptly repair improvements to at least their former state. Functional use of these improvements will be maintained at all times. The holder will contact the owner of any improvements prior to disturbing them. When necessary to pass through a fence line, the fence shall be braced on both sides of the passageway prior to cutting of the fence. No permanent gates will be allowed unless approved by the Authorized Officer. 10. Vegetation, soil, and rocks left as a result of construction or maintenance activity will be randomly scattered on this right-of-way and will not be left in rows, piles, or berms, unless otherwise approved by the Authorized Officer. The entire right-of-way shall be recontoured to match the surrounding landscape. The backfilled soil shall be compacted and a 6 inch berm will be left over the ditch line to allow for settling back to grade. 11. In those areas where erosion control structures are required to stabilize soil conditions, the holder will install such structures as are suitable for the specific soil conditions being encountered and which are in accordance with sound resource management practices. 12. The holder will reseed all disturbed areas. Seeding will be done according to the attached seeding requirements, using the following seed mix. () seed mixture 1 () seed mixture 3 () seed mixture 2 (X) seed mixture 4 () seed mixture 2/LPC () Aplomado Falcon Mixture

- 13. All above-ground structures not subject to safety requirements shall be painted by the holder to blend with the natural color of the landscape. The paint used shall be color which simulates "Standard Environmental Colors" **Shale Green**, Munsell Soil Color No. 5Y 4/2.
- 14. The pipeline will be identified by signs at the point of origin and completion of the right-of-way and at all road crossings. At a minimum, signs will state the holder's name, BLM serial number, and the product being transported. All signs and information thereon will be posted in a permanent, conspicuous manner, and will be maintained in a legible condition for the life of the pipeline.
- 15. The holder shall not use the pipeline route as a road for purposes other than routine maintenance as determined necessary by the Authorized Officer in consultation with the holder before maintenance begins. The holder will take whatever steps are necessary to ensure that the pipeline route is not used as a roadway. As determined necessary during the life of the pipeline, the Authorized Officer may ask the holder to construct temporary deterrence structures.
- 16. Any cultural and/or paleontological resources (historic or prehistoric site or object) discovered by the holder, or any person working on his behalf, on public or Federal land shall be immediately reported to the Authorized Officer. Holder shall suspend all operations in the immediate area of such discovery until written authorization to proceed is issued by the Authorized Officer. An evaluation of the discovery will be made by the Authorized Officer to determine appropriate actions to prevent the loss of significant cultural or scientific values. The holder will be responsible for the cost of evaluation and any decision as to proper mitigation measures will be made by the Authorized Officer after consulting with the holder.
- 17. The operator shall be held responsible if noxious weeds become established within the areas of operations. Weed control shall be required on the disturbed land where noxious weeds exist, which includes associated roads, pipeline corridor and adjacent land affected by the establishment of weeds due to this action. The operator shall consult with the Authorized Officer for acceptable weed control methods, which include following EPA and BLM requirements and policies.
- 18. <u>Escape Ramps</u> The operator will construct and maintain pipeline/utility trenches [that are not otherwise fenced, screened, or netted] to prevent livestock, wildlife, and humans from becoming entrapped. At a minimum, the operator will construct and maintain escape ramps, ladders, or other methods of avian and terrestrial wildlife escape in the trenches according to the following criteria:
 - a. Any trench left open for eight (8) hours or less is not required to have escape ramps; however, before the trench is backfilled, the contractor/operator shall inspect the trench for wildlife, remove all trapped wildlife, and release them at least 100 yards from the trench.
 - b. For trenches left open for eight (8) hours or more, earthen escape ramps (built at no more than a 30 degree slope and spaced no more than 500 feet apart) shall be placed in the trench.

BLM Lease Number: Company Reference: Well Name & Number:

STANDARD STIPULATIONS FOR OIL AND GAS RELATED SITES

A copy of the application (Grant/Sundry Notice) and attachments, including stipulations and map, will be on location during construction. BLM personnel may request to view a copy of your permit during construction to ensure compliance with all stipulations.

The holder agrees to comply with the following stipulations to the satisfaction of the Authorized Officer, BLM.

- 1. The holder shall indemnify the United States against any liability for damage to life or property arising from the occupancy or use of public lands under this grant and for all response costs, penalties, damages, claims, and other costs arising from the provisions of the Resource Conservation and Recovery Act (RCRA), 42 U.S.C. Chap. 82, Section 6901 et. seq., from the Comprehensive Environmental Response, Compensation and Liability Act (CERCLA), 42 U.S.C. Chap. 109, Section 9601 et. seq., and from other applicable environmental statues.
- 2. The holder shall comply with all applicable Federal laws and regulations existing or hereafter enacted or promulgated. In any event, the holder shall comply with the Toxic Substances Control Act of 1976, as amended (15 U.S.C. 2601, et. seq.) with regard to any toxic substances that are used, generated by or stored on the right-of-way or on facilities authorized by this grant. (See 40 CFR, Part 702-799 and especially, provisions on polychlorinated biphenyls, 40 CFR 761.1-761.193.) Additionally, any release of toxic substances (leaks, spills, etc.) in excess of the reportable quantity established by 40 CFR, Part 117 shall be reported as required by the Comprehensive Environmental Response, Compensation and Liability Act, Section 102b. A copy of any report required or requested by any Federal agency or State government as a result of a reportable release or spill of any toxic substances shall be furnished to the Authorized Officer concurrent with the filing of the reports to the involved Federal agency or State government.
- 3. The holder agrees to indemnify the United States against any liability arising from the release of any hazardous substance or hazardous waste (as these terms are defined in the Comprehensive Environmental Response, Compensation and Liability Act of 1980, 42 U.S.C. 9601, et. seq. or the Resource Conservation and Recovery Act, 42 U.S.C. 6901, et. seq.) on the right-of-way (unless the release or threatened release is wholly unrelated to the right-of-way holder's activity on the right-of-way). This agreement applies without regard to whether a release is caused by the holder, its agent, or unrelated third parties.
- 4. If, during any phase of the construction, operation, maintenance, or termination of the site or related pipeline(s), any oil or other pollutant should be discharged from site facilities, the pipeline(s) or from containers or vehicles impacting Federal lands, the control and total removal, disposal, and cleanup of such oil of other pollutant, wherever found, shall be the responsibility of the holder, regardless of fault. Upon failure of the holder to control, dispose of, or clean up such

discharge on or affecting Federal lands, or to repair all damages to Federal lands resulting therefrom, the Authorized Officer may take such measures as deemed necessary to control and cleanup the discharge and restore the area, including, where appropriate, the aquatic environment and fish and wildlife habitats, at the full expense of the holder. Such action by the Authorized Officer shall not relieve the holder of any liability or responsibility.

- 5. Sites shall be maintained in an orderly, sanitary condition at all times. Waste materials, both liquid and solid, shall be disposed of promptly at an appropriate, authorized waste disposal facility in accordance with all applicable State and Federal laws. "Waste" means all discarded matter including, but not limited to, human waste, trash, garbage, refuse, petroleum products, brines, chemicals, oil drums, ashes, and equipment.
- 6. The operator will notify the Bureau of Land Management (BLM) authorized officer and nearest Fish and Wildlife Service (FWS) Law Enforcement office within 24 hours, if the operator discovers a dead or injured federally protected species (i.e., migratory bird species, bald or golden eagle, or species listed by the FWS as threatened or endangered) in or adjacent to a pit, trench, tank, exhaust stack, or fence. (If the operator is unable to contact the FWS Law Enforcement office, the operator must contact the nearest FWS Ecological Services office.)
- 7. All above-ground structures not subject to safety requirements shall be painted by the holder to blend with the natural color of the landscape. The paint used shall be a color which simulates "Standard Environmental Colors" designated by the Rocky Mountain Five-State Interagency Committee. The color selected for this project is **Shale Green**, Munsell Soil Color Chart Number 5Y 4/2.
- 8. Any cultural and/or paleontological resource (historic or prehistoric site or object) discovered by the holder, or any person working on the holder's behalf, on public or Federal land shall be immediately reported to the Authorized Officer. The holder shall suspend all operations in the immediate area of such discovery until written authorization to proceed is issued by the Authorized Officer. An evaluation of the discovery will be made by the Authorized Officer to determine appropriate actions to prevent the loss of significant cultural or scientific values. The holder will be responsible for the cost of evaluation and any decision as to the proper mitigation measures will be made by the Authorized Officer after consulting with the holder.
- 9. A sales contract for removal of mineral material (caliche, sand, gravel, fill dirt) from an authorized pit, site, or on location must be obtained from the BLM prior to commencing construction. There are several options available for purchasing mineral material: contact the BLM office (575-234-5972).
- 10. The operator shall be held responsible if noxious weeds become established within the areas of operations. Weed control shall be required on the disturbed land where noxious weeds exist, which includes the roads, pads, associated pipeline corridor, and adjacent land affected by the establishment of weeds due to this action. The operator shall consult with the Authorized Officer for acceptable weed control methods, which include following EPA and BLM requirements and policies.

11. Once the site is no longer in service or use, the site must undergo final abandonment. At final abandonment, the site and access roads must undergo "final" reclamation so that the character and productivity of the land are restored. Earthwork for final reclamation must be completed within six (6) months of the abandonment of the site. All pads and facility locations and roads must be reclaimed to a satisfactory revegetated, safe, and stable condition, unless an agreement is made with the landowner or BLM to keep the road and/or pad intact. After all disturbed areas have been satisfactorily prepared, these areas need to be revegetated with the seed mixture provided. Seeding should be accomplished by drilling on the contour whenever practical or by other approved methods. Seeding may need to be repeated until revegetation is successful, as determined by the BLM.

Operators shall contact a BLM surface protection specialist prior to surface abandonment operations for site specific objectives (Jim Amos: 575-234-5909).

- 12. The holder shall stockpile an adequate amount of topsoil where blading occurs. The topsoil to be stripped is approximately ___6__ inches in depth. The topsoil will be segregated from other spoil piles. The topsoil will be used for final reclamation.
- 13. The holder will reseed all disturbed areas. Seeding will be done according to the attached seeding requirements, using the following seed mix.

() seed mixture 1	() seed mixture 3
() seed mixture 2	(X) seed mixture 4
() seed mixture 2/LPC	() Aplomado Falcon Mixture

- 14. In those areas where erosion control structures are required to stabilize soil conditions, the holder shall install such structures as are suitable for the specific soil conditions being encountered and which are in accordance with sound management practices. Any earth work will require prior approval by the Authorized Officer.
- 15. Open-topped Tanks The operator will take actions necessary to prevent wildlife and livestock access, including avian wildlife, to all open-topped tanks that contain or have the potential to contain salinity sufficient to cause harm to wildlife or livestock, hydrocarbons, or Resource Conservation and Recovery Act of 1976-exempt hazardous substances. At a minimum, the operator will net, screen, or cover open-topped tanks to exclude wildlife and livestock and prevent mortality. If the operator uses netting, the operator will cover and secure the open portion of the tank to prevent wildlife entry. The operator will net, screen, or cover the tanks until the operator removes the tanks from the location or the tanks no longer contain substances that could be harmful to wildlife or livestock. Use a maximum netting mesh size of 1 ½ inches. The netting must not be in contact with fluids and must not have holes or gaps
- 16. The operator will prevent all hazardous, poisonous, flammable, and toxic substances from coming into contact with soil and water. At a minimum, the operator will install and maintain an impervious secondary containment system for any tank or barrel containing hazardous, poisonous, flammable, or toxic substances sufficient to contain the contents of the tank or barrel and any drips, leaks, and anticipated precipitation. The operator will dispose of fluids within the containment system that do not meet applicable state or U. S. Environmental Protection Agency

livestock water standards in accordance with state law; the operator must not drain the fluids to the soil or ground. The operator will design, construct, and maintain all secondary containment systems to prevent wildlife and livestock exposure to harmful substances. At a minimum, the operator will install effective wildlife and livestock exclosure systems such as fencing, netting, expanded metal mesh, lids, and grate covers. Use a maximum netting mesh size of 1 ½ inches.

- 17. Open-Vent Exhaust Stack Exclosures The operator will construct, modify, equip, and maintain all open-vent exhaust stacks on production equipment to prevent birds and bats from entering, and to discourage perching, roosting, and nesting. (Recommended exclosure structures on open-vent exhaust stacks are in the shape of a cone.) Production equipment includes, but may not be limited to, tanks, heater-treaters, separators, dehydrators, flare stacks, in-line units, and compressor mufflers.
- 18. Containment Structures Proposed production facilities such as storage tanks and other vessels will have a secondary containment structure that is constructed to hold the capacity of 1.5 times the largest tank, plus freeboard to account for precipitation, unless more stringent protective requirements are deemed necessary.