# Form 3160-5 (June 2015)

### Rec'd 8/7/2020 - NMOCD

**UNITED STATES** DEPARTMENT OF THE INTERIOR BUREAU OF LAND MANAGEMENT

FORM APPROVED OMB NO. 1004-0137 Expires: January 31, 2018 5. Lease Serial No. NMLC065876A

**SUNDRY NOTICES AND REPORTS ON WELLS** 

Do not use the abandoned we	6. If Indian, Allottee or	Tribe Name			
SUBMIT IN	7. If Unit or CA/Agreer NMNM138440	ment, Name and/or No.			
1. Type of Well				8. Well Name and No.	
☑ Oil Well ☐ Gas Well ☐ Oth	er Contact: LAURA E			SD WE 24 FED P2	4 5H
<ol><li>Name of Operator CHEVRON USA INC</li></ol>		9. API Well No. 30-025-43674-00	)-S1		
3a. Address 1616 W. BENDER BLVD HOBBS, NM 88240		10. Field and Pool or E JENNINGS JENNINGS-UPP	xploratory Area ER BONE SPRING SH		
4. Location of Well (Footage, Sec., T	., R., M., or Survey Description)			11. County or Parish, S	tate
Sec 24 T26S R32E SESE 200 32.021488 N Lat, 103.623810				LEA COUNTY, N	IM
12. CHECK THE AI	PPROPRIATE BOX(ES) TO INDI	CATE NATURE OF	F NOTICE,	REPORT, OR OTH	ER DATA
TYPE OF SUBMISSION		TYPE OF	ACTION		
Matina of Intent	☐ Acidize ☐	Deepen	☐ Producti	on (Start/Resume)	☐ Water Shut-Off
■ Notice of Intent	☐ Alter Casing ☐	Hydraulic Fracturing	☐ Reclama	tion	■ Well Integrity
☐ Subsequent Report	☐ Casing Repair ☐	New Construction	☐ Recomp	lete	<b>⊠</b> Other
☐ Final Abandonment Notice	☐ Change Plans ☐	Plug and Abandon	☐ Tempora	arily Abandon	Surface Disturbance
	☐ Convert to Injection ☐	Plug Back	■ Water D	isposal	
testing has been completed. Final At determined that the site is ready for final Attention of the Chevron respectfully requests Section 24, T26S-R32E of the landing pad and a 30' x 721' refer purposes of safety, we are debris and to be reseeded with The helicopter landing zone prequiring emergency medical	authorization to build a 100' x 100' s Salado Draw Development. This poad extension required to access the proposing an additional 100' pering hative grass mix.  ad will be used for emergency purpattention. Due to the location of the g zone pad will significantly reduce	r all requirements, including zone site.  The licopter landing zone site.	one pad in 0' x 50' asph  of brush and ersonnel ess and response	a, have been completed an	d the operator has
	Electronic Submission #512293 ve	A INC, sent to the Ho	bbs	•	
Name(Printed/Typed) LAURA B	ECERRA	Title REGULA	ATORY SPE	CIALIST	
Signature (Electronic S	Submission)	Date 04/22/20	020		
<u> </u>	THIS SPACE FOR FEDE			 SE	
Approved By CODY LAYTON		TitleASSISTAN	IT FIELD MA	NAGER	Date 08/03/2020
Conditions of approval, if any, are attache	d. Approval of this notice does not warrant uitable title to those rights in the subject lea act operations thereon.				
	U.S.C. Section 1212, make it a crime for an statements or representations as to any matt		willfully to ma	ke to any department or a	gency of the United

### Additional data for EC transaction #512293 that would not fit on the form

### 32. Additional remarks, continued

On-site review was conducted with BLM NRS on 4/21/2020.

Certified plats attached.

### Revisions to Operator-Submitted EC Data for Sundry Notice #512293

**Operator Submitted** 

**BLM Revised (AFMSS)** 

**DISTURB** Sundry Type:

NOI

**DISTURB** NOI

NMLC065876A Lease:

NMLC065876A

Agreement:

NMNM138440 (NMNM138440)

Operator:

CHEVRON USA INC 6301 DEAUVILLE BLVD MIDLAND, TX 79706 Ph: 432-687-7665

CHEVRON USA INC 1616 W. BENDER BLVD HOBBS, NM 88240 Ph: 575-263-0431

LAURA BECERRA REGULATORY SPECIALIST

Admin Contact:

Tech Contact:

LAURA BECERRA REGULATORY SPECIALIST

E-Mail: LBECERRA@CHEVRON.COM

E-Mail: LBECERRA@CHEVRON.COM Ph: 432-687-7655

Ph: 432-687-7655

LAURA BECERRA REGULATORY SPECIALIST E-Mail: LBECERRA@CHEVRON.COM

Ph: 432-687-7655

Ph: 432-687-7655

Location:

State: NMCounty: LEA

Field/Pool: JENNINGS;UPR BS SHALE

NM LEA


JENNINGS JENNINGS-UPPER BONE SPRING SHA

LAURA BECERRA REGULATORY SPECIALIST E-Mail: LBECERRA@CHEVRON.COM

Well/Facility:

SD WE 24 FED P24 5H Sec 24 T26S R32E Mer NMP SESE 200FSL 1235FEL SD WE 24 FED P24 5H

Sec 24 T26S R32E SESE 200FSL 1235FEL 32.021488 N Lat, 103.623810 W Lon

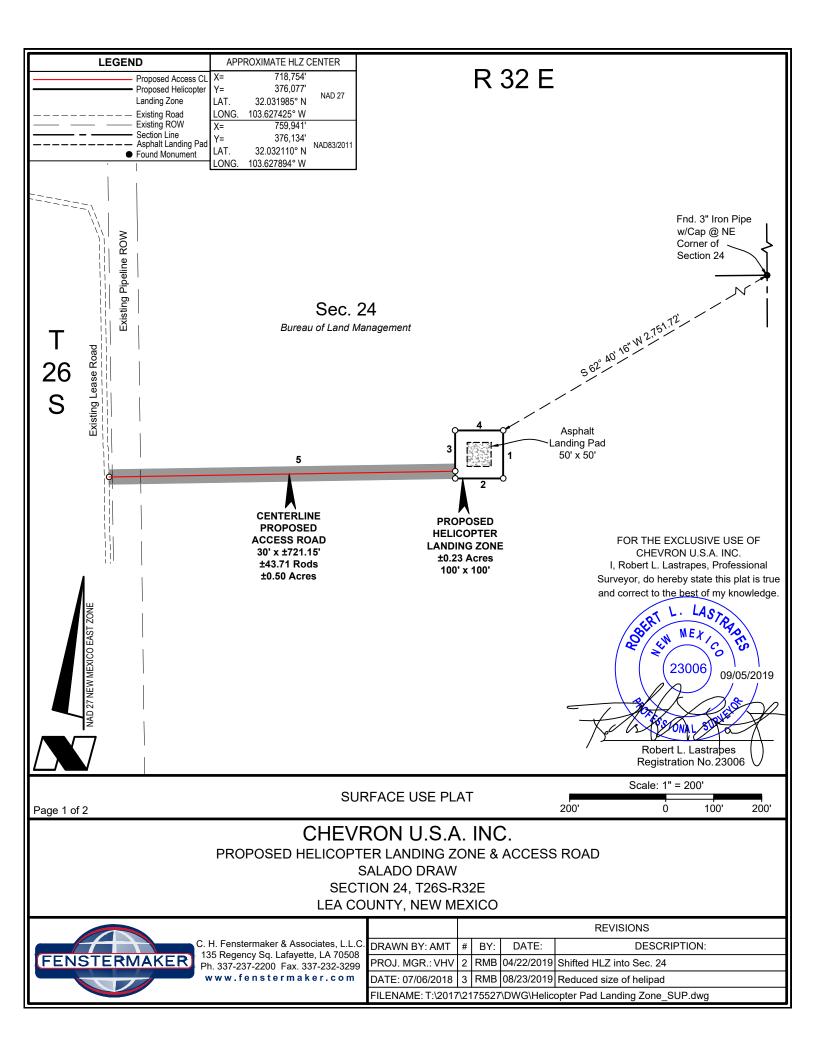

DISCLAIMER: At this time, C. H. Fenstermaker & Associates, L.L.C. has not performed nor was asked to perform any type of engineering, hydrological modeling, flood plain, or "No Rise" certification analyses, including but not limited to determining whether the project will impact flood hazards in connection with federal/FEMA, state, and/or local laws, ordinances and regulations. Accordingly, Fenstermaker makes no warranty or representation of any kind as to the foregoing issues, and persons or entities using this information shall do so at their own risk.

### NOTE:

Please be advised, that while reasonable efforts are made to locate and verify pipelines and anomalies using our standard pipeline locating equipment, it is impossible to be 100 % effective. As such, we advise using caution when performing work as there is a possibility that pipelines and other hazards, such as fiber optic cables, PVC pipelines, etc. may exist undetected on site.

#### <u>NOTE</u>

Many states maintain information centers that establish links between those who dig (excavators) and those who own and operate underground facilities (operators). It is advisable and in most states, law, for the contractor to contact the center for assistance in locating and marking underground utilities. For guidance, New Mexico One Call www.nm811.org

PROPOSED HELICOPTER						
LANDING ZONE						
COURSE BEARING DISTANCE						
1	SOUTH	100.00'				
2	WEST	100.00'				
3	NORTH	100.00'				
4	EAST	100.00'				

NW	HELICOPTER LA	NDING	NE HELICOPTER LANDING		
	ZONE CORNE	₹		ZONE CORNE	₹
X=	718,704'		X=	718,804'	
Y=	376,127'	NAD 27	Y=	376,127'	NAD 27
LAT.	32.032123° N	NAD 21	LAT.	32.032121° N	NAD 21
LONG.	103.627586° W		LONG.	103.627263° W	
X=	759,891'		X=	759,991'	
Y=	376,184'	NAD83/2011	Y=	376,184'	NAD83/2011
LAT.	32.032248° N	NAD03/2011	LAT.	32.032246° N	NAD03/2011
LONG.	103.628054° W		LONG.	103.627732° W	
ELEV.	+3,156'	NAVD88	ELEV.	+3,157'	NAVD88
SW	HELICOPTER LA	NDING	SE	HELICOPTER LA	NDING
	ZONE CORNEI	₹		ZONE CORNEI	₹
X=	718,704'		X=	718,804'	
Y=	376,027'	NAD 27	Y=	376,027'	NAD 27
LAT.	32.031848° N	NAD 21	LAT.	32.031846° N	NAD 21
LONG.	103.627588° W		LONG.	103.627265° W	
X=	759,891'		X=	759,991'	
Y=	376,084'	NA D02/0044	Y=	376,084'	NAD02/0044
LAT.	32.031973° N	NAD83/2011	LAT.	32.031971° N	NAD83/2011
LONG.	103.628056° W		LONG.	103.627734° W	
ELEV.	+3,155'	NAVD88	ELEV.	+3,155'	NAVD88

CENTERLINE PROPOSED ACCESS ROAD						
COURSE	DISTANCE					
5	N 89° 03' 17" E	721.15'				

FOR THE EXCLUSIVE USE OF CHEVRON U.S.A. INC.

I, Robert L. Lastrapes, Professional Surveyor, do hereby state this plat is true and correct to the <u>best</u> of my knowledge.

23006

09/05/2019

Robert L. Lastrapes Registration No. 23006

SURFACE USE PLAT

Page 2 of 2

### CHEVRON U.S.A. INC.

PROPOSED HELICOPTER LANDING ZONE & ACCESS ROAD
SALADO DRAW

SECTION 24, T26S-R32E LEA COUNTY, NEW MEXICO



C. H. Fenstermaker & Associates, L.L.C. 135 Regency Sq. Lafayette, LA 70508 Ph. 337-237-2200 Fax. 337-232-3299 www.fenstermaker.com


 REVISIONS

 DRAWN BY: AMT
 #
 BY:
 DATE:
 DESCRIPTION:


 PROJ. MGR.: VHV
 2
 RMB
 04/22/2019
 Shifted HLZ into Sec. 24

 DATE: 07/06/2018
 3
 RMB
 08/23/2019
 Reduced size of helipad


 FILENAME: T:\2017\2175527\DWG\Helicopter Pad Landing Zone\_SUP.dwg

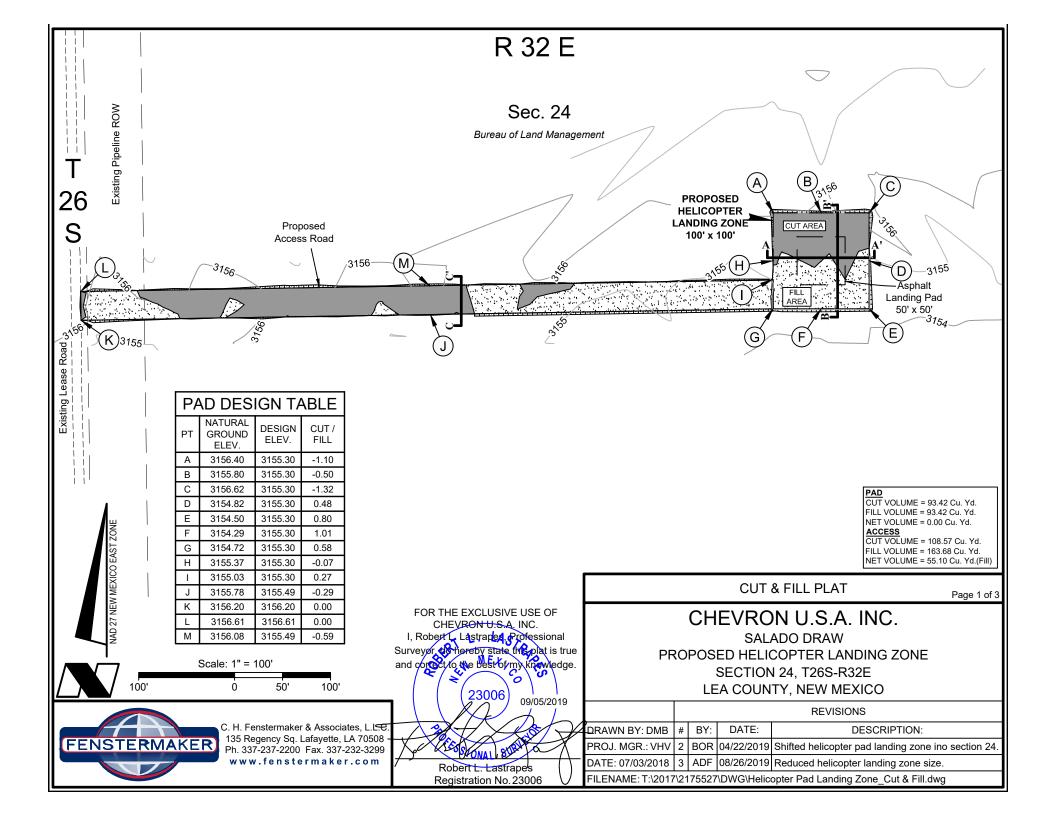


# CROSS SECTION A-A' HORIZONTAL SCALE 1"=60' VERTICAL SCALE 1"=10'

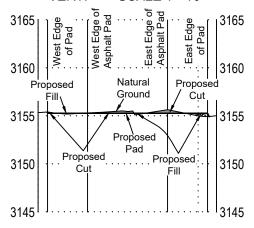

# CROSS SECTION B-B' HORIZONTAL SCALE 1"=60' VERTICAL SCALE 1"=10'

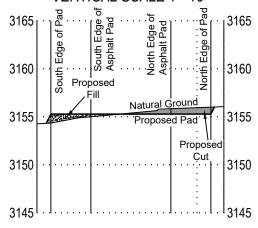

### CROSS SECTION C-C' HORIZONTAL SCALE 1"=60' VERTICAL SCALE 1"=10'

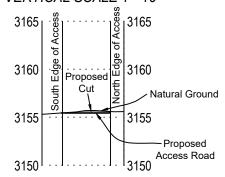

FOR THE EXCLUSIVE USE OF CHEVRON U.S.A. INC.

I, Robert L Lastrapes, Professional Surveyor, the hereby state (his plat is true and correct to the best of my knowledge.

23006) 09/05/2019

**CUT & FILL PLAT** 

Page 2 of 3

# CHEVRON U.S.A. INC.


SALADO DRAW
PROPOSED HELICOPTER LANDING ZONE
SECTION 24, T26S-R32E
LEA COUNTY, NEW MEXICO

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	L
FENSTERMAKER	


C. H. Fenstermaker & Associates, L. .... 135 Regency Sq. Lafayette, LA 70508 Ph. 337-237-2200 Fax. 337-232-3299 www.fenstermaker.com

Robert L. Lastrapes
Registration No. 23006

	REVISIONS			
ÐRAWN BY: DMB	#	BY:	DATE:	DESCRIPTION:
PROJ. MGR.: VHV	2	BOR	04/22/2019	Shifted helicopter pad landing zone ino section 24.
DATE: 07/03/2018	8 3 ADF 08/26/2019 Reduced helicopter landing zone size.			
FILENAME: T:\2017\2175527\DWG\Helicopter Pad Landing Zone_Cut & Fill.dwg				

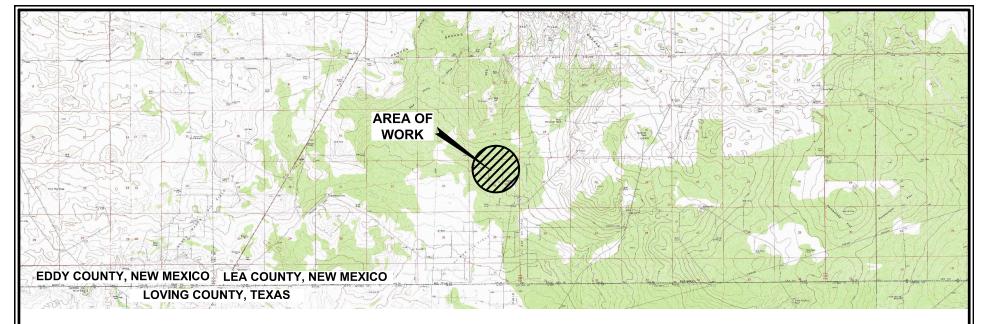

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#### NOTE:

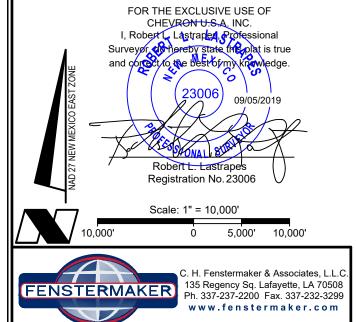- 1. Many states maintain information centers that establish links between those who dig (excavators) and those who own and operate underground facilities (operators). It is advisable and in most states, law, for the contractor to contact the center for assistance in locating and marking underground utilities. For guidance: New Mexico One Call- <a href="www.nm811.org">www.nm811.org</a>.
- 2. The design pad elevation recommendation is based solely on a cut and fill (1:1 ratio) balance of the pad and does not include material required for the access roads. A detailed soil test and slope stability analysis shall be performed prior to construction to ensure proper compaction and working performance of the pad under the anticipated loadings. This material balance sheet does not constitute a foundation design and C. H. Fenstermaker & Associates, L.L.C. makes no warranty to the structural integrity of the site layout as shown. Fenstermaker also makes no recommendation or warranty about the layout relative to flood hazards, erosion control, or soil stability issues. Elevations refer to the North American Vertical Datum of 1988.
- 3.Please be advised, that while reasonable efforts are made to locate and verify pipelines and anomalies using our standard pipeline locating equipment, it is impossible to be 100 % effective. As such, we advise using caution when performing work as there is a possibility that pipelines and other hazards, such as fiber optic cables, PVC pipelines, etc. may exist undetected on site.

### **CUT & FILL PLAT**

Page 3 of 3

# CHEVRON U.S.A. INC.

SALADO DRAW
PROPOSED HELICOPTER LANDING ZONE
SECTION 24, T26S-R32E
LEA COUNTY. NEW MEXICO

		REVISIONS			
DRAWN BY: DMB	#	BY:	DATE:	DESCRIPTION:	
PROJ. MGR.: VHV	2	BOR	04/22/2019	Shifted helicopter pad landing zone ino section 24.	
DATE: 07/03/2018	3	ADF	08/26/2019	Reduced helicopter landing zone size.	
FILENAME: T:\2017\2175527\DWG\Helicopter Pad Landing Zone_Cut & Fill.dwg					