Appendix 4 – Recycling Containment Engineering Drawings

RECEIVED By OCD Dr Oberding at 10:13 am, Dec 16, 2016

CHEVRON N.A. E&P, MCBU SALADO DRAW WATER RECYCLING POND 1 AND POND 2 CONSTRUCTION LEA COUNTY, NEW MEXICO

INDEX OF DRAWINGS

SHEET	C-1	COVER SHEET
SHEET	C-2	EXISTING SITE
SHEET	C-3	POND 1 AND PO
SHEET	C-4	POND 1 AND PO
SHEET	C-5	POND 1 CROSS-
SHEET	C-6	POND 2 CROSS-
SHEET	C-7	POND 1 AND PO
SHEET	C-8	POND 1 SUMP S
SHEET	C-9	POND 2 SUMP S
SHEET	C-10	POND 1 AND PO
SHEET	C-11	POND 1 AND PO
SHEET	C-12	SAFETY AND SE
SHEET	C-13	SAFETY AND SE
SHEET	C-14	MISCELLANEOU
SHEET	C-15	POND 1 AND PO
SHEET	C-16	POND 1 AND PO

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or outside of the organization other than whom this document was prepared for.	10/18/16	DATE			

CONDITIONS OND 2 EXCAVATION PLAN OND 2 COMPLETION PLAN **S-SECTIONS** S-SECTIONS OND 2 LINER DETAILS SECTIONS AND RISER DETAILS SECTIONS AND RISER DETAILS OND 2 SUMP PIPING PLAN OND 2 PIPE STAND DETAILS ECURITY PLAN AND DETAILS ECURITY PLAN AND DETAILS US DETAILS OND 2 BELOW GRADE STAKING PLAN OND 2 ABOVE GRADE STAKING PLAN

- 3. CONTROL POINT LOCATION IS AT NORTHING 377560.49 EASTING 757326.03 ELEVATION 3171.46

TICE property of d herein is d be treated d not be ndividuals in




Tetra Tech Inc. Texas Registered Engineering Firm F-3924 4000 N. BIG SPRING, Suite 401 MIDLAND, TEXAS 79705

(432) 682-4559

CHEVRON N.A. E&P, MCBU LEA COUNTY, NEW MEXICO GPS (WGS84): 32.034518°N, -103.638474°W

VERIFY SCALE BAR IS ONE (1) INCH ON	SCALES:	
ORIGINAL DRAWING.	HORIZONTAL SCALE: 1" = 100'	
IF NOT ONE (1) INCH ON THIS SHEET, ADJUST SCALES ACCORDINGLY.	VERTICAL SCALE: NA	

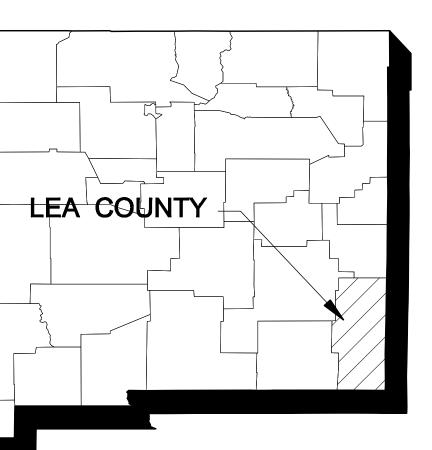

GENERAL NOTES

1. ALL TOPOGRAPHIC, UTILITY AND CONTROL POINT LOCATION INFORMATION IS BASED ON SURVEY INFORMATION FURNISHED BY THE OWNER, THE CONTRACTOR HAS THE SOLE **RESPONSIBILITY FOR FIELD VERIFICATION.**


2. COORDINATE INFORMATION IS BASED ON AND ARE BASED ON STATE PLANES COORDINATE NEW MEXICO EAST ZONE (4726) NAD83, THE CONTRACTOR SHALL IDENTIFY ANY DISCREPANCIES PRIOR TO PROCEEDING WITH CONSTRUCTION.

4. THE CONTRACTOR SHALL IDENTIFY AND LOCATE UTILITY LINES, MONITOR WELLS, SURVEY MONUMENTS, AND OTHER NEARBY STRUCTURES PRIOR TO PERFORMING WORK. UTILITIES, MONITOR WELLS, SURVEY MONUMENTS AND OTHER NEARBY STRUCTURES SHALL BE PROTECTED FROM DAMAGE DURING THIS WORK. ANY DAMAGE TO UTILITY LINES, MONITOR WELLS, SURVEY MONUMENTS, AND OTHER NEARBY STRUCTURES DURING THE WORK SHALL BE REPAIRED BY THE CONTRACTOR AT NO ADDITIONAL COST TO THE OWNER. COSTS ASSOCIATED WITH THESE REPAIRS SHALL INCLUDE THE ACTUAL REPAIR COSTS AND ALL ENGINEERING COSTS REQUIRED BY THE ENGINEER TO COORDINATE AND OBTAIN REGULATORY APPROVAL OF THE REPAIRS IF REQUIRED.

5. THE CONTRACTOR SHALL REFER TO THE SALADO DRAW WATER RECYCLING POND TECHNICAL SPECIFICATIONS IN ADDIITON TO THE DRAWINGS FOR THE CONSTRUCTION.

TITLE SHEET
SALADO DRAW
LEA COUNTY, NEW MEXICO

PROJECT NO.
212C-MD-00546
DRAWING NO.
C-1
SHEET NO.
1 OF 16

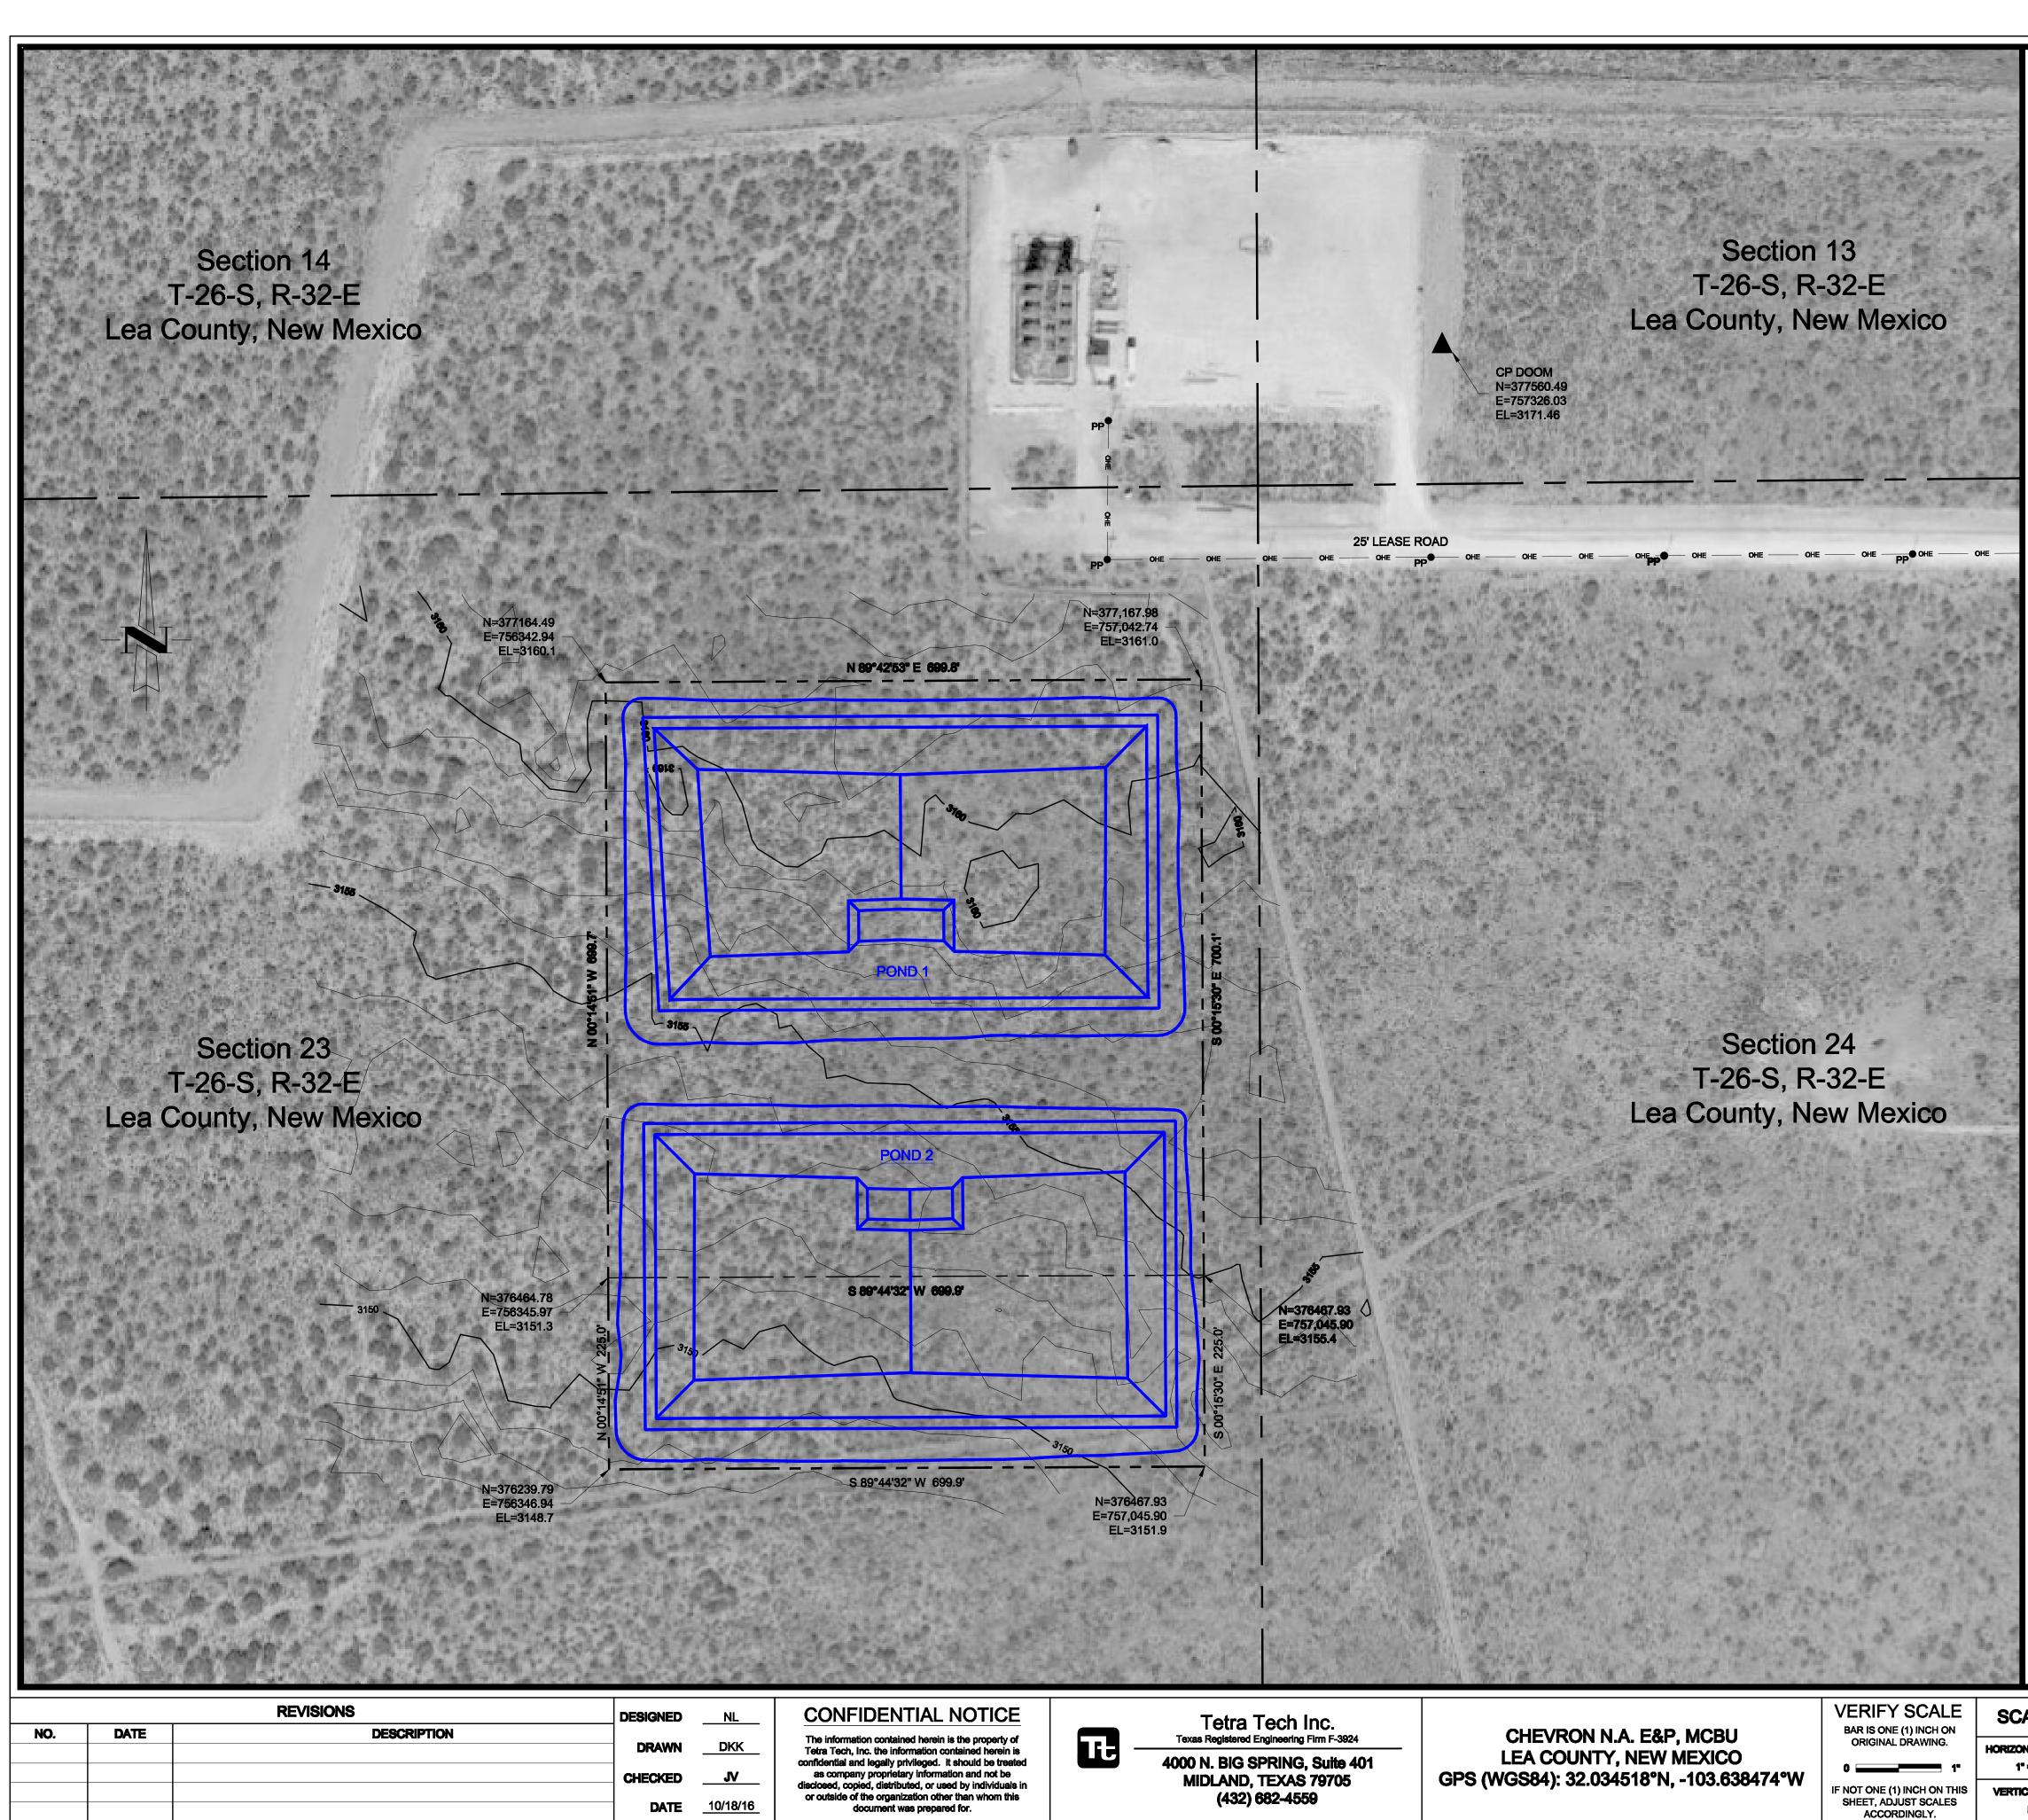

DATE 10/18/16

CHECKED

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IF NOT ONE (1) INCH ON THIS SHEET, ADJUST SCALES ACCORDINGLY.

SCALES: HORIZONTAL SCALE: 1° = 100'

VERTICAL SCALE: NA


LEGEND

	WATER RECYCLING POND OUTLINE
	EXISTING 5' CONTOUR INTERVAL (FEET, MSL)
	EXISTING 1' CONTOUR INTERVAL
	PERMIT BOUNDARY
	SECTION BOUNDARY
	OVERHEAD ELECTRICAL
₽₽●	POWER POLE



EXISTING SITE CONDITIONS SALADO DRAW LEA COUNTY, NEW MEXICO

PROJECT NO. 212C-MD-00546 DRAWING NO. C-2 SHEET NO. 2 OF 16

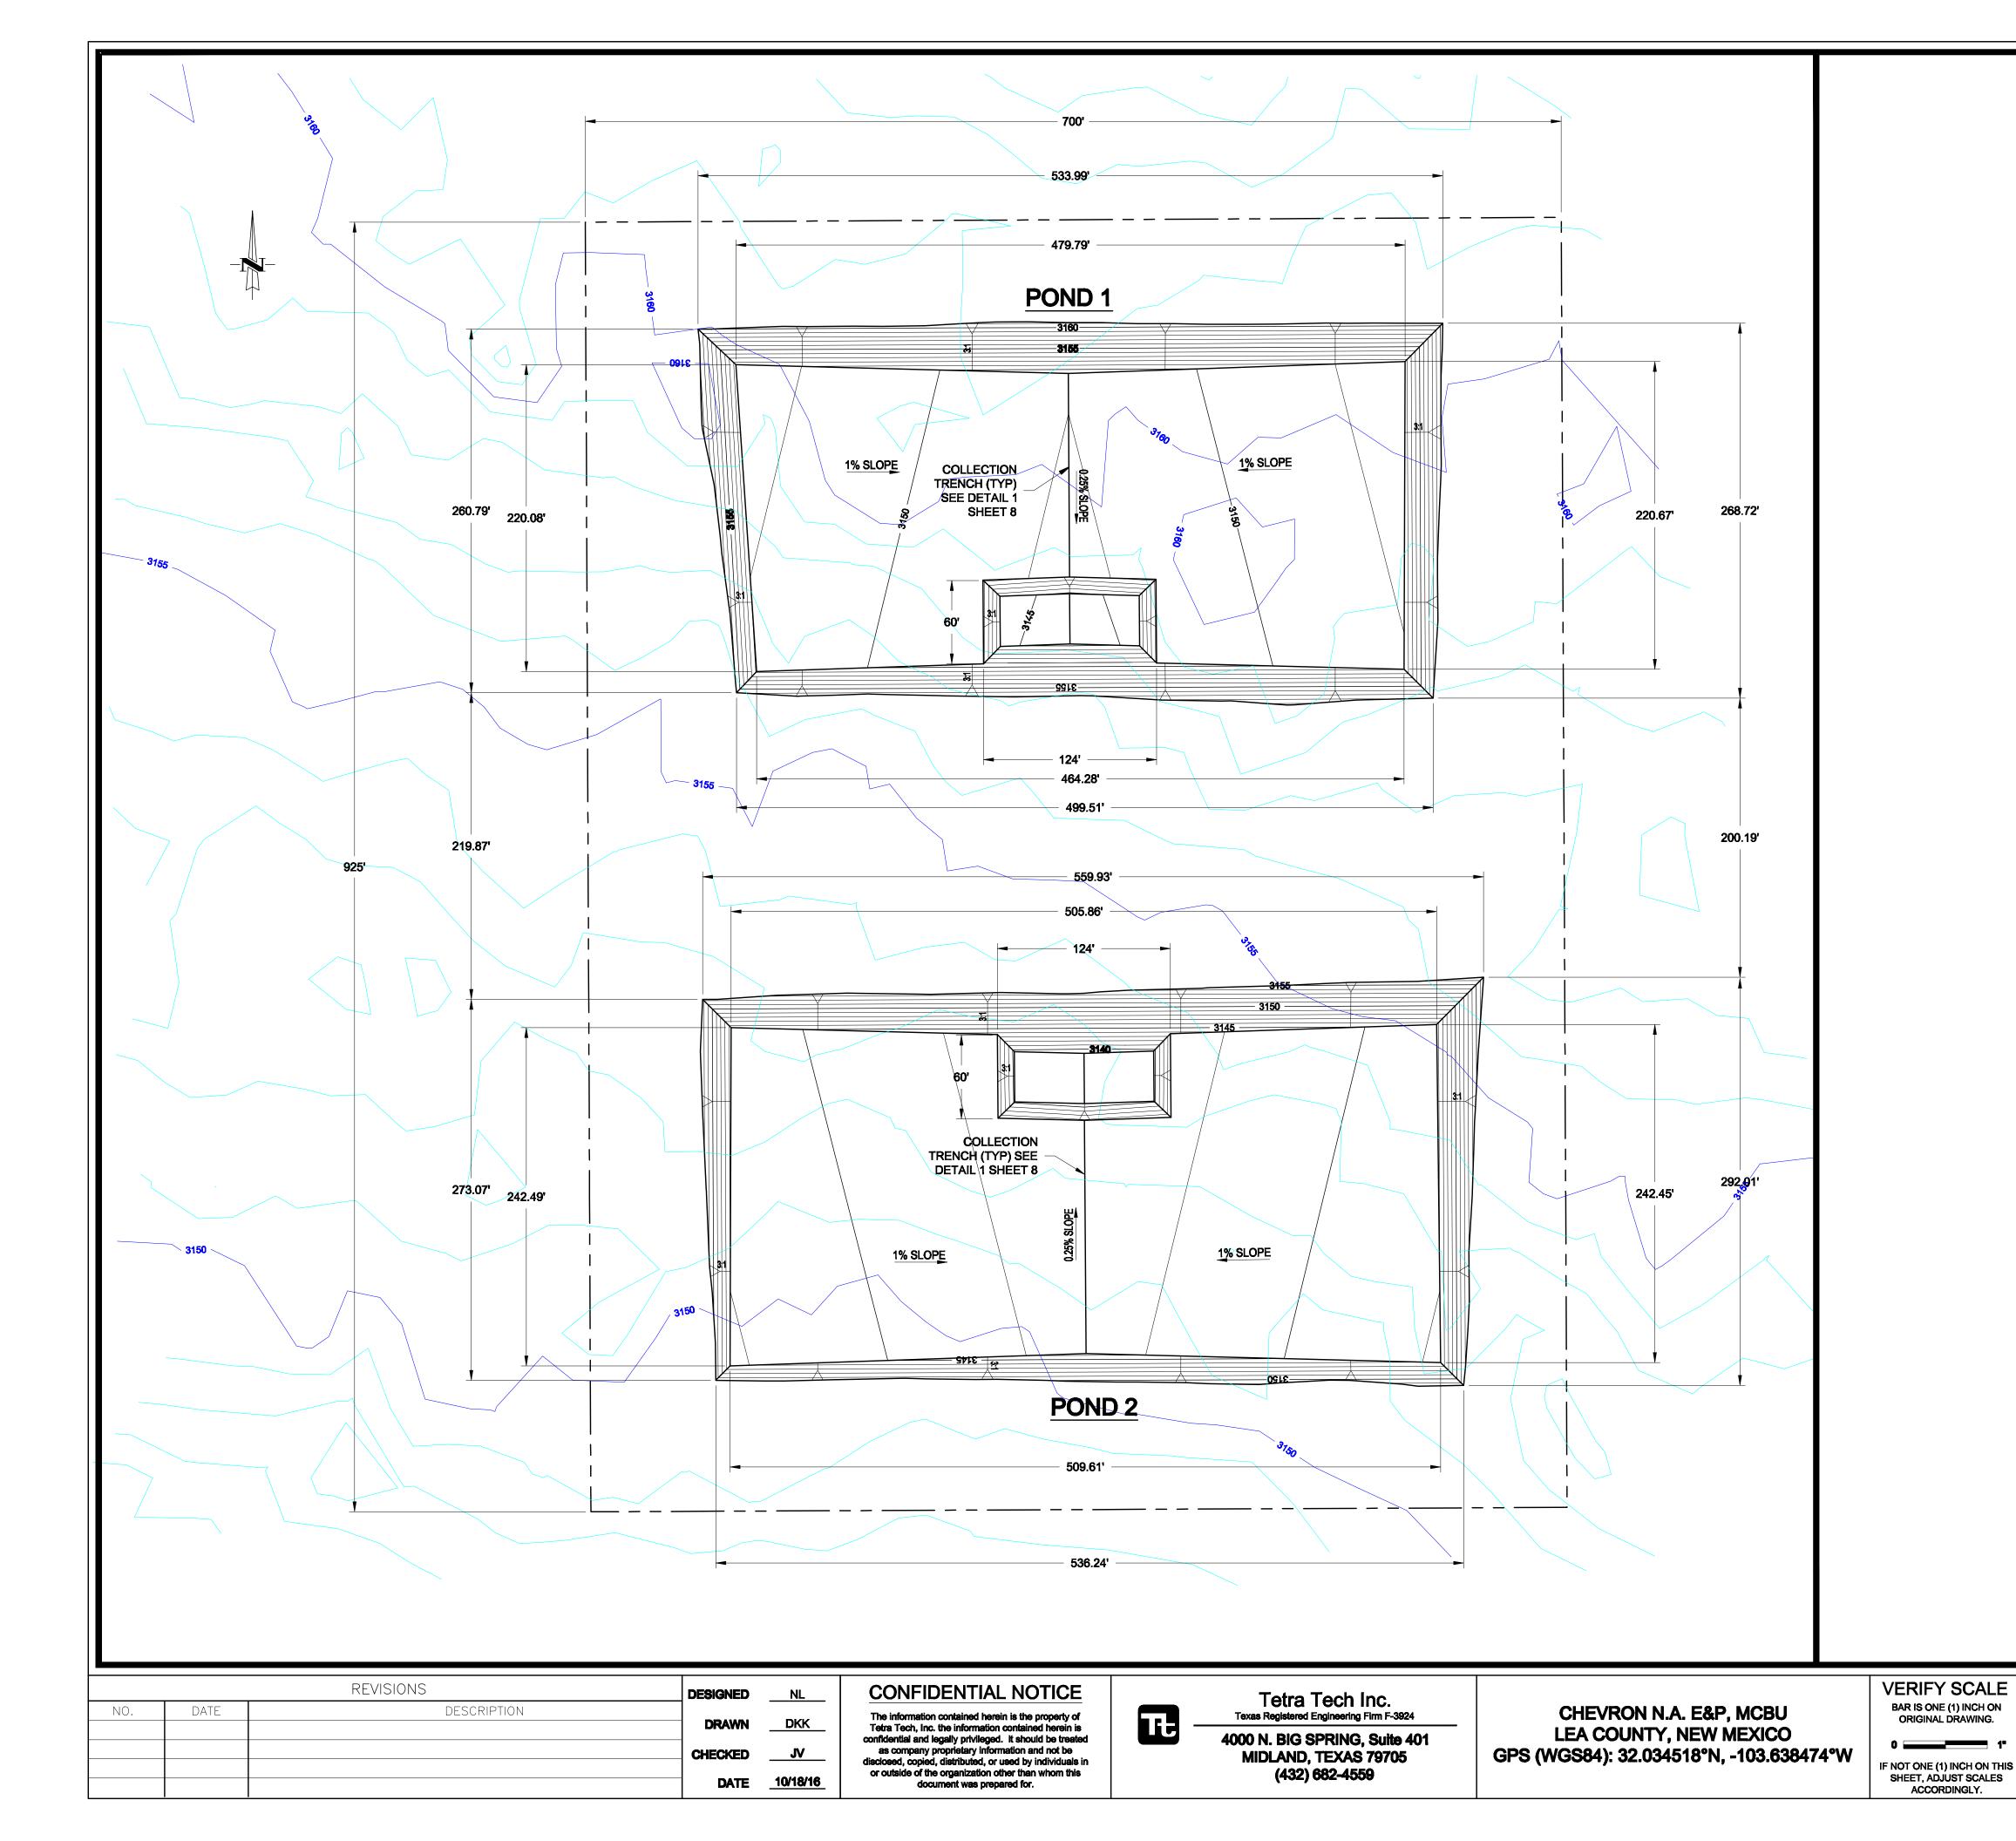



SCALES: HORIZONTAL SCALE: 1" **= 60**" VERTICAL SCALE: NA

POND 1 EXCAVATION CALCULATIONS TOTAL AREA = 5.98 ACRES FILL VOLUME (1.55x) = 38,247 CU.YDS EXCAVATION VOLUME = 41,443 CU.YDS NET DIFFERENCE = 3,196 CU.YDS.

POND 2 EXCAVATION CALCULATIONS TOTAL AREA = 6.40 ACRES FILL VOLUME (1.55x) = 39,109 CU.YDS EXCAVATION VOLUME = 37,448 CU.YDS NET DIFFERENCE = 1,661 CU.YDS.

NOTES

1. THE CONTRACTOR SHALL REFER TO THE TECHNICAL SPECIFICATIONS FOR THE SALADO DRAW WATER RECYCLING PROJECT IN ADDITION TO THE DRAWINGS FOR EARTHWORK CONSTRUCTION.

2. SEE SHEET 15 FOR POND 1 AND POND 2 BELOW GRADE STAKING PLAN

LEGEND

 —3150——	

EXISTING 5' CONTOUR INTERVAL (FEET, MSL) EXISTING 1' CONTOUR INTERVAL PROPOSED 2' CONTOUR INTERVAL (FEET, MSL) PROPOSED 1' CONTOUR INTERVAL PERMIT BOUNDARY



POND 1 AND POND 2 **EXCAVATION PLAN** SALADO DRAW LEA COUNTY, NEW MEXICO

PROJECT NO. 212C-MD-00546 DRAWING NO. **C-3** SHEET NO. 3 OF 16