
B	UNITED STATES EPARTMENT OF THE IN UREAU OF LAND MANAG NOTICES AND REPOR is form for proposals to fill. Use form 3160-3 (APL	TERIOR GEMENT	OCD   LLS enter an OB		OMB NO	APPROVED 0. 1004-0137 nuary 31, 2018
	TRIPLICATE - Other inst			0 8 2018	7. If Unit or CA/Agree	
1. Type of Well □ Oil Well 🛛 Gas Well □ Ot	her			EIVED	8. Well Name and No. MADERA 19 FED	ERAL 1
2. Name of Operator MARATHON OIL PERMIAN I	Contact:	JENNIFER V	AN CUREN		<ol> <li>API Well No. 30-025-36645</li> </ol>	1
3a. Address 5555 SAN FELIPE ST HOUSTON, TX 77056		3b. Phone No. Ph: 713-26	(include area code) 2-2500		10. Field and Pool or E JABALINA, STR	
4. Location of Well (Footage, Sec., 1	T., R., M., or Survey Description)	,			11. County or Parish, S	State
Sec 19 T26S R35E Mer NMP NWSW 1980FSL 1000FWL			LEA COUNTY, NM		MM	
12. CHECK THE A	PPROPRIATE BOX(ES)	TO INDICA	TE NATURE O	F NOTICE,	REPORT, OR OTH	ER DATA
TYPE OF SUBMISSION			TYPE OF	ACTION		
<ul> <li>Notice of Intent</li> <li>Subsequent Report</li> <li>Final Abandonment Notice</li> <li>13. Describe Proposed or Completed Op</li> </ul>	<ul> <li>Acidize</li> <li>Alter Casing</li> <li>Casing Repair</li> <li>Change Plans</li> <li>Convert to Injection</li> </ul>	<ul><li>New</li><li>Plug</li><li>Plug</li></ul>	raulic Fracturing Construction and Abandon Back	<ul> <li>Reclam</li> <li>Recomp</li> <li>Tempor</li> <li>Water I</li> </ul>	blete rarily Abandon Disposal	<ul> <li>Water Shut-Off</li> <li>Well Integrity</li> <li>Other</li> <li>Site Facility Diagra m/Security Plan</li> </ul>
following completion of the involve testing has been completed. Final A determined that the site is ready for Marathon Oil Permian is subr Please see attached sheet fo	bandonment Notices must be file final inspection. nitting the site facility diagr r all required information.	ed only after all 1	equirements, includ	ang reclamation 23.	APR 2 5 20 APR 2 5 20 Amelinnu IREAU OF LAND MAN CARLSBAD FIELD 0	RECORD 118 AGEMENT
<ol> <li>I hereby certify that the foregoing in Name (Printed/Typed) JENNIFE</li> </ol>	Electronic Submission #4	N OIL PERM	AN LLC, sent to DEBORAH MCKI	the Hobbs NNEY on 04		D
Name(Trutew Typed) JENNIFE	R VAN COREN		The SR. RE	GULATOR	COMPLIANCE RE	F
Signature (Electronic	Submission)		Date 04/24/2			
	THIS SPACE FO	R FEDERA	L OR STATE	OFFICE U	SE	
Approved By Conditions of approval, if any, are attache certify that the applicant holds legal or eq which would entitle the applicant to cond	uitable title to those rights in the		Title Office			Date
Title 18 U.S.C. Section 1001 and Title 43 States any false, fictitious or fraudulent				willfully to m	ake to any department or	agency of the United
(Instructions on page 2) <b>** OPERA</b>	TOR-SUBMITTED ** OI	PERATOR-	SUBMITTED *	* OPERAT		*

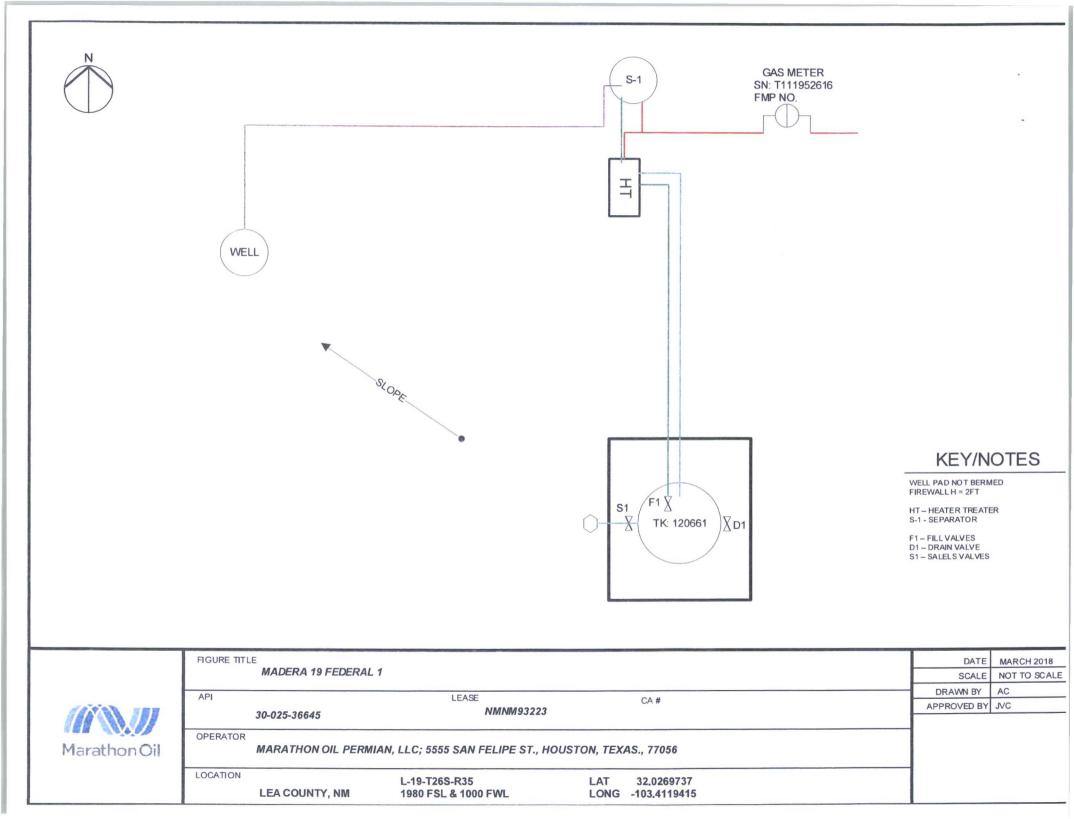

## Valve Positioning in the Production Phase

Producing to 120661 Valve S1 & D1 are sealed closed Valve F1 is open


Valve Positioning in the Sales Phase

Sales from 120661 Valve F1& D1 are closed Valve S1 is open

Valve Positioning in the Drain Phase

Drain from 120661 Valve S1 & F1 is sealed closed D1 is open

	FIGURE TITL					DATE	MARCH 2018
		MADERA 19 FEDERAL 1				SCALE	NOT TO SCALE
1	API		LEASE			DRAWN BY	AC
		20.025.20045	NMNM93223		CA #	APPROVED BY	JVC
	30-025-36645 NWNW93223						
Marathon Oil	OPERATOR	OPERATOR MARATHON OIL PERMIAN, LLC					
	LOCATION	LEA COUNTY, NM	L-19-T26S-R35 1980 FSL & 1000 FWL	LAT LONG	32.0269737 -103.4119415		

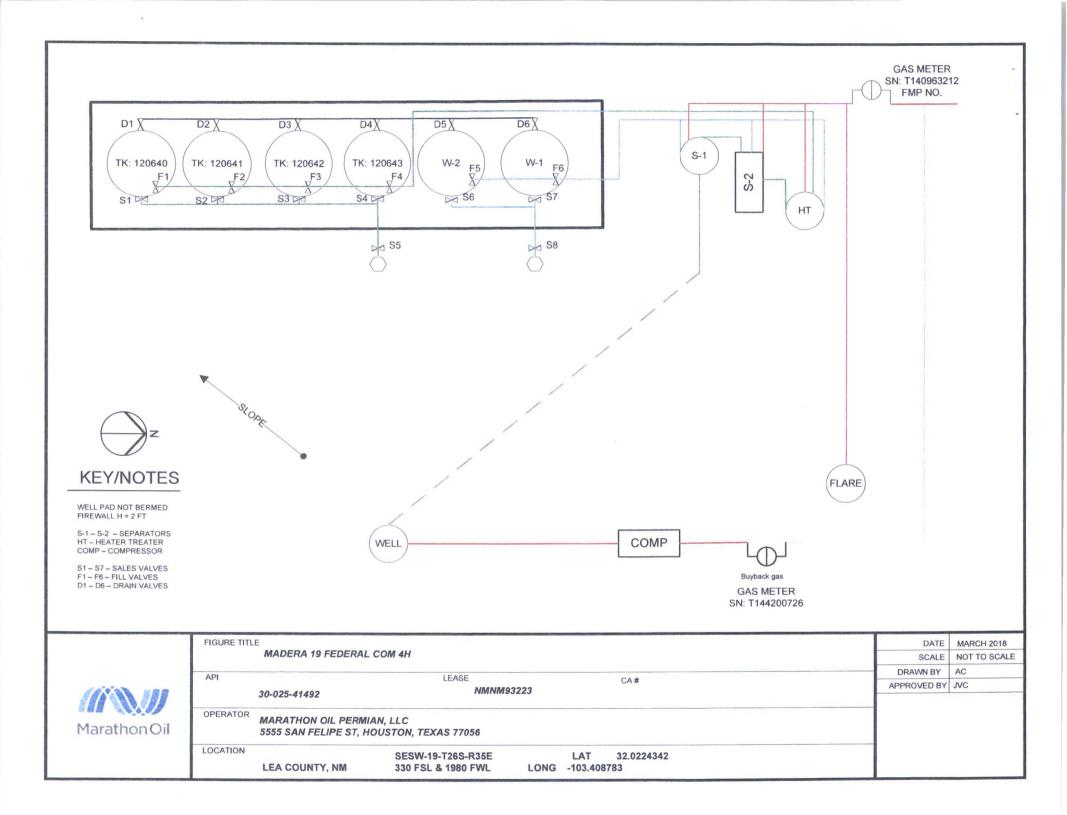

## Valve Positioning in the Production Phase

Producing to 120640 Valve F1 is open Valve S1, D1 are sealed closed Valve S2, D1 are sealed closed Valve S3, D1 are sealed closed Valve S4, D1 are sealed closed Valve F2, F3, F4 are closed

Producing to 120641 Valve F2 is open Valve F1, F3, F4 are closed

Producing to 120642 Valve F3 is open Valve F1, F2, F4 are closed

Producing to 120643 Valve F4 is open Valve F1, F2, F3 are closed

## Valve Positioning in the Sales Phase

Sales from 120640	Sales from 120641	Sales from 120642	Sales from 120643
Valve F1, D1 are sealed closed	Valve F2, D2 are sealed closed	Valve F3, D3 are sealed closed	Valve F4, D4 are sealed closed
Valve S1, S5 are open	Valve S2, S5 are open	Valve S3, S5 are open	Valve S4, S5 are open
Valve F2, F3, F4 are open/closed	Valve F1, F3, F4 are open/closed	Valve F1, F2, F4 are open/closed	Valve F1, F2, F3 are open/closed
Valve S2, S3, S4 are sealed closed	Valve S1, S3, S4 are sealed closed	Valve S1, S2, S4 are sealed closed	Valve S1, S2, S3 are sealed closed
Valve D2, D3, D4 are sealed closed	Valve D1, D3, D4 are sealed closed	Valve D1, D2, D4 are sealed closed	Valve D1, D2, D3 are sealed closed

## Valve Positioning in the Drain Phase

	Drain from 120640 /alve F1 are closed /alve D1, D6 are open /alve F2, F3, F4 are open/closed /alve S1, S2, S3, S4 are sealed closed /alve D2, D3, D4 are closed	Valve F1, F3, F4 are open/closed Valve S1, S2, S3, S4 are sealed closed	Valve F3 are closed Valve D3, D6 are open Valve F1 F2 F4 are open/closed	Drain from 120643 Valve F4 are closed Valve D4, D6 are open Valve F1, F2, F3 are open/closed Valve S1, S2, S3, S4 are sealed closed Valve D1, D2, D3 are closed
--	--	--	--	--

FIGURE TITLE DATE MARCH 2018 MADERA 19 FEDERAL COM 4H SCALE NOT TO SCALE DRAWN BY AC API LEASE CA# APPROVED BY JVC NMNM93223 30-025-41492 OPERATOR MARATHON OIL PERMIAN, LLC Marathon Oil 5555 SAN FELIPE ST, HOUSTON, TEXAS 77056 LOCATION SESW-19-T26S-R35E LAT 32.0224342 LEA COUNTY, NM LONG -103.408783 330 FSL & 1980 FWL