Form 3160-5 (June 2015)

# HOBBS OCD **UNITED STATES**

DEPARTMENT OF THE INTERIOR
BUREAU OF LAND MANAGEMENT NOTICES AND REPORTS ON WELLS 2019

FORM APPROVED
OMB NO. 1004-0137
Expires: January 31, 2018

5. Lease Serial No. NMNM0557686

Do not use this form for proposals to drill or to re-enter an abandoned well. Use form 3160-3 (APD) for some proposals.				6. If Indian, Allottee or Tribe Name		
SUBMIT IN	TRIPLICATE - Other ins	tructions on	page 2		7. If Unit or CA/Agree	ement, Name and/or No.
Type of Well     Gas Well    Otl	her				8. Well Name and No. SEMU 95	-
2. Name of Operator CONOCOPHILLIPS COMPAR	Contact: NY E-Mail: Susan.B.M	SUSAN B M launder@cono			9. API Well No. 30-025-24918-0	00-S1
3a. Address 925 N ELDRIDGE PARKWAY HOUSTON, TX 77079	•	3b. Phone No Ph: 281-20	o. (include area code) 16-5281	)	10. Field and Pool or Exploratory Area WEIR	
4. Location of Well (Footage, Sec., 7	., R., M., or Survey Description	)			11. County or Parish,	State
Sec 23 T20S R37E NWSE 21	30FSL 1980FEL				LEA COUNTY,	NM
12. CHECK THE AI	PPROPRIATE BOX(ES)	TO INDICA	TE NATURE O	F NOTICE,	REPORT, OR OTH	IER DATA
TYPE OF SUBMISSION			TYPE OI	FACTION		
Notice of Intent     ■	☐ Acidize	☐ Dec	pen	☐ Production	on (Start/Resume)	☐ Water Shut-Off
_	☐ Alter Casing	☐ Hyd	raulic Fracturing	Reclama Reclama	tion	■ Well Integrity
☐ Subsequent Report	Casing Repair	□ New	Construction	☐ Recompl	ete	Other Surface Disturbance
☐ Final Abandonment Notice	□ Change Plans	Plug	and Abandon	☐ Tempora	rily Abandon	Surface Disturbance
	☐ Convert to Injection	Plug	Back Back	☐ Water D	isposal	
If the proposal is to deepen directions Attach the Bond under which the wor following completion of the involved testing has been completed. Final Abdetermined that the site is ready for fit ConocoPhillips Company resp Grayburg Battery in Sec. 25, T ConocoPhillips Company resp 36 Battery in Sec. 36, T20S, R Up to two 4" lines will be instal surface lines replace buried flo abandon the buried flowlines in Attached are plat packages for acres and use the existing righ minimize risk of spills.	k will be performed or provide operations. If the operation resandonment Notices must be file and inspection.  ectfully requests approva 20S, R37E to the SEMU ectfully requests approva 37E, to the SEMU #095 step 1987, to the S	the Bond No. or utts in a multipled only after all to install sur #095 SWD w It to also instal SWD well.  1 125 psi, and ame right of vapping, to mithings which sells.	n file with BLM/BIA e completion or recorrequirements, includ face flow lines from the fill surface flow lines are carry produced way. We request nimize surface details out of the form of the file of the fill surface details out of the file of the fill surface details out of the fill surface of the fill s	Required subsimpletion in a neing reclamation.  com the SEMic. 23, T20S, nes from Hard  water. The approval to isturbance.  ace use ~3.9	sequent reports must be the interval, a Form 3166, have been completed a U R37E. dy	filed within 30 days 0-4 must be filed once
Com	Electronic Submission #4 For CONOCOI mitted to AFMSS for proce	PHILLIPS CO	MPÅNY, sent to ti NA MEDRANO or	he Hobbs 1 07/17/2019 (*	19JM0078SE)	
Name (Printed/Typed) SUSAN B	MAUNDER		Title SENIOR	REGULATO	DRY COORDINATO	DR
Signature (Electronic S	ubmission)		Date 07/17/20	019		
	THIS SPACE FO	R FEDERA	L OR STATE	OFFICE US	E	1
Approved By	1. 19th		Title Title	1-6	4M	Hate 14/19
Conditions of approval, it any, are attached tertify that the applicant holds legal or equi which would entitle the applicant to conduc	itable title to those rights in the	not warrant or subject lease	Office (f	CO		

Title 18 U.S.C. Section 1001 and Title 43 U.S.C. Section 1212, make it a crime for any person knowingly and willfully to make to any department or agency of the United States any false, fictitious or fraudulent statements or representations as to any matter within its jurisdiction. States any false, fictitious or traudulent salections on page 2)
\*\*\* BLM REVISED \*\* BLM REVISED \*\* BLM REVISED \*\* BLM REVISED \*\*



#### Additional data for EC transaction #473843 that would not fit on the form

## 32. Additional remarks, continued

Cultural protection surveys have already been submitted to BLM; please see NMCRIS Activity Report No.: 143550.

Thank you for your consideration of this request.

#### Revisions to Operator-Submitted EC Data for Sundry Notice #473843

**Operator Submitted** 

DISTURB

NMNM0557686 Lease:

Agreement:

Sundry Type:

Operator:

CONOCOPHILLIPS COMPANY P.O. BOX 2197 OFFICE SP2-12-W156 HOUSTON, TX 77252 Ph: 281-206-5281

Admin Contact:

SUSAN B MAUNDER SENIOR REGULATORY COORDINATOR E-Mall: Susan.B.Maunder@conocophillips.com

Ph: 281-206-5281

Tech Contact:

SUSAN B MAUNDER
SENIOR REGULATORY COORDINATOR
E-Mail: Susan.B.Maunder@conocophilips.com

Ph: 281-206-5281

Location:

State: County: NM LEA COUNTY

Field/Pool:

**SKAGGS** 

Well/Facility:

**SEMU 95** 

Sec 23 T20S R37E Mer NMP NWSE 2130FSL 1980FEL

**BLM Revised (AFMSS)** 

DISTURB NOI

NMNM0557686

CONOCOPHILLIPS COMPANY 925 N ELDRIDGE PARKWAY HOUSTON, TX 77079 Ph: 281 206 5281

SUSAN B MAUNDER SENIOR REGULATORY COORDINATOR E-Mail: Susan.B.Maunder@conocophilips.com

Ph: 281-206-5281

SUSAN B MAUNDER SENIOR REGULATORY COORDINATOR E-Mail: Susan.B.Maunder@conocophilips.com

Ph: 281-206-5281

NM LEA


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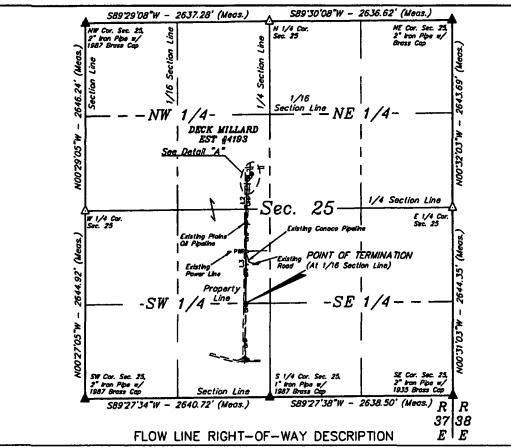
SEMU 95 Sec 23 T20S R37E NWSE 2130FSL 1980FEL

### CONOCOPHILLIPS COMPANY SEMU GRAYBERG TO SEMU 95 SEC. 25, T205, R37E, N.M.P.M., LEA COUNTY, NEW MEXICO

DATE:	DESCRIPTION:
4/22/2019	FINAL FLOW LINE PLATS
	<b>]</b>





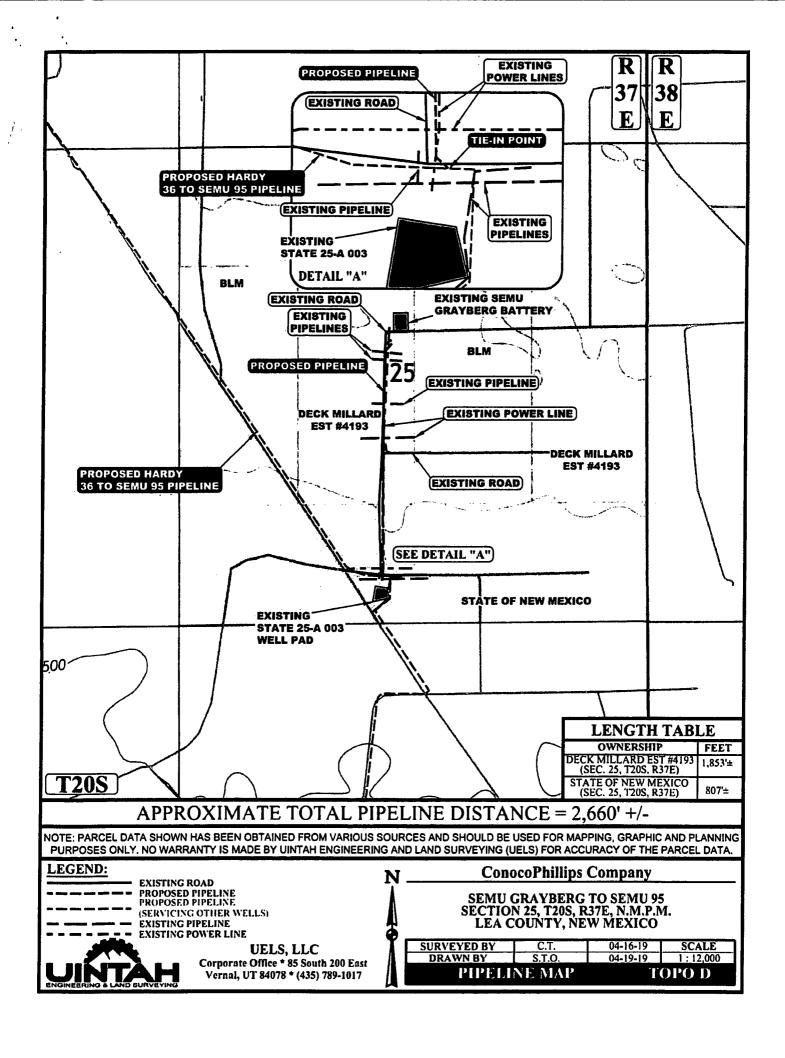


A 10' WIDE RIGHT-OF-WAY 5' ON EACH SIDE OF THE FOLLOWING DESCRIBED CENTERLINE.

BEGINNING AT A POINT IN THE SE 1/4 NW 1/4 OF SECTION 25, T20S, R37E, N.M.P.M., WHICH BEARS S48"24'38"E 3204.73' BEGINNING AT A POINT IN THE \$2.1/4 NW 1/4 OF SECTION 25, 1205, NS.7E, N.M.P.M., WRICH BEARS \$48.24.38 E 3204.75
FROM THE NORTHWEST CORNER OF SAID SECTION 25, THENCE S02'9'04"W 83.55'; THENCE S00'52'05"W 642.02'; THENCE S00'07'54"W 1127.05' TO A POINT ON THE SOUTH LINE OF THE NE 1/4 SW 1/4 OF SAID SECTION 25, WHICH BEARS N15'29'26"W 1368.65' FROM THE SOUTH 1/4 CORNER OF SAID SECTION 25. THE SIDE LINES OF SAID DESCRIBED RIGHT-OF-WAY BEING SHORTENED OR ELONGATED TO MEET THE GRANTOR'S PROPERTY LINES. BASIS OF BEARINGS IS A TRANSVERSE MERCATOR PROJECTION WITH A CENTRAL MERIDIAN OF W103"53"00". CONTAINS 0.425 ACRES MORE OR LESS.

LINE TABLE					
LINE	DIRECTION	LENGTH			
LI .	\$52"29"04"W	83.55'			
L2	S00"52"05"W	642.02			
L3	S00'07'54"W	1127.05			


POINT OF BEGINNING BEARS S48'24'38"E 3204.73' FROM THE NORTHWEST CORNER OF SECTION 25, T20S, R37E, N.M.P.M.

POINT OF TERMINATION BEARS N15'29'26"W 1368.65' FROM THE SOUTH 1/4 CORNER OF SECTION 25, T20S, R37E, N.M.P.M.

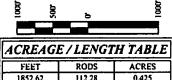

= SECTION CORNERS LOCATED.

△ = SECTION CORNERS RE-ESTABLISHED. (Not Set on Ground.)

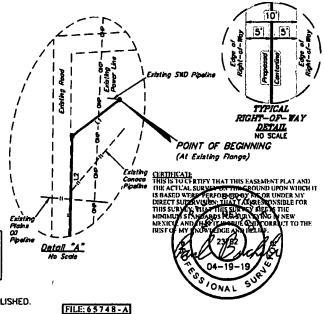


NOTES:
Basis of Bearings is a Transverse Mercator Projection with a Central Menthian of W103\*55'00'




UELS, LLC Corporate Office \* 85 South 200 East Vernal, UT 84078 \* (435) 789-1017

ConocoPhillips Company SEMU GRAYBERG TO SEMU 95 ON DECK MILLARD EST #4193 LANDS IN SECTION 25, T20S, R37E, N.M.P.M. LEA COUNTY, NEW MEXICO

SURVEYED BY SCALE 1" = 1000 04-16-19 04-19-19 DRAWN BY FLOW LINE R-O-W

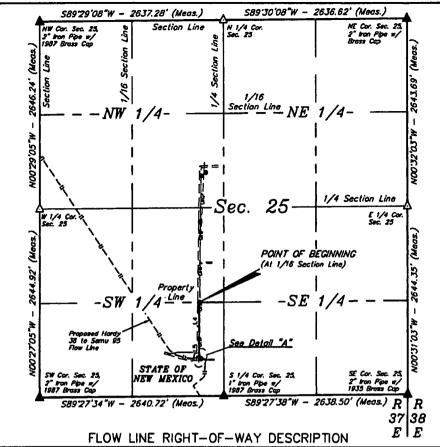

BEGINNING AT A POINT ON THE NORTH LINE OF THE SE 1/4 SW 1/4 OF SECTION 25, T205, R37E, N.M.P.M., WHICH BEARS N15"29'26"W 1368.65' FROM THE SOUTH 1/4 CORNER OF SAID SECTION 25, THENCE S00"07"54"W 516.46'; THENCE S01"05'06"E 252.78'; THENCE S49"06"54"E 38.15' TO A POINT IN THE SE 1/4 SW 1/4 OF SAID SECTION 25, WHICH BEARS N32"24'19"W 621.56' FROM THE SOUTH 1/4 CORNER OF SAID SECTION 25. THE SIDE LINES OF SAID DESCRIBED RIGHT-OF-WAY BEING SHORTENED OR ELONGATED TO MEET THE GRANTOR'S PROPERTY LINES. BASIS OF BEARINGS IS A TRANSVERSE MERCATOR PROJECTION WITH A CENTRAL MERIDIAN OF W103"53"00". CONTAINS 0.185 ACRES MORE OR LESS.

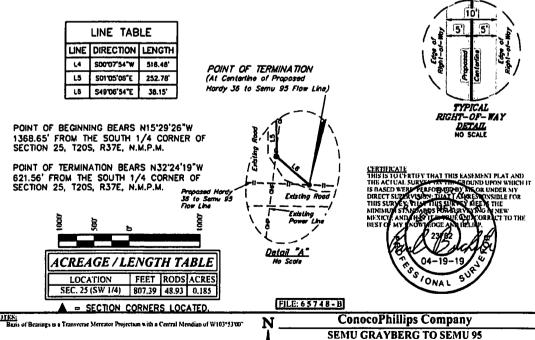

UINTAH

UELS, LLC Corporate OMce \* 85 South 200 East Vernal, UT 84078 \* (435) 789-1017 ConocoPhillips Company

SEMU GRAYBERG TO SEMU 95
ON STATE OF NEW MEXICO LANDS IN
SECTION 25, T20S, R37E, N.M.P.M.
LEA COUNTY, NEW MEXICO


SURVEYED BY C.T. 04-16-19 SCALE
DRAWN BY J.P.P. 04-19-19 1" = 1000"


FLOW LINE R-O-W

# CONOCOPHILLIPS COMPANY HARDY 36 TO SEMU 95 SEC. 23, 25, 26 & 36, T20S, R37E, N.M.P.M., LEA COUNTY, NEW MEXICO

DATE:	DESCRIPTION:
4/23/201	DESCRIPTION: 9 FINAL FLOW LINE PLATS



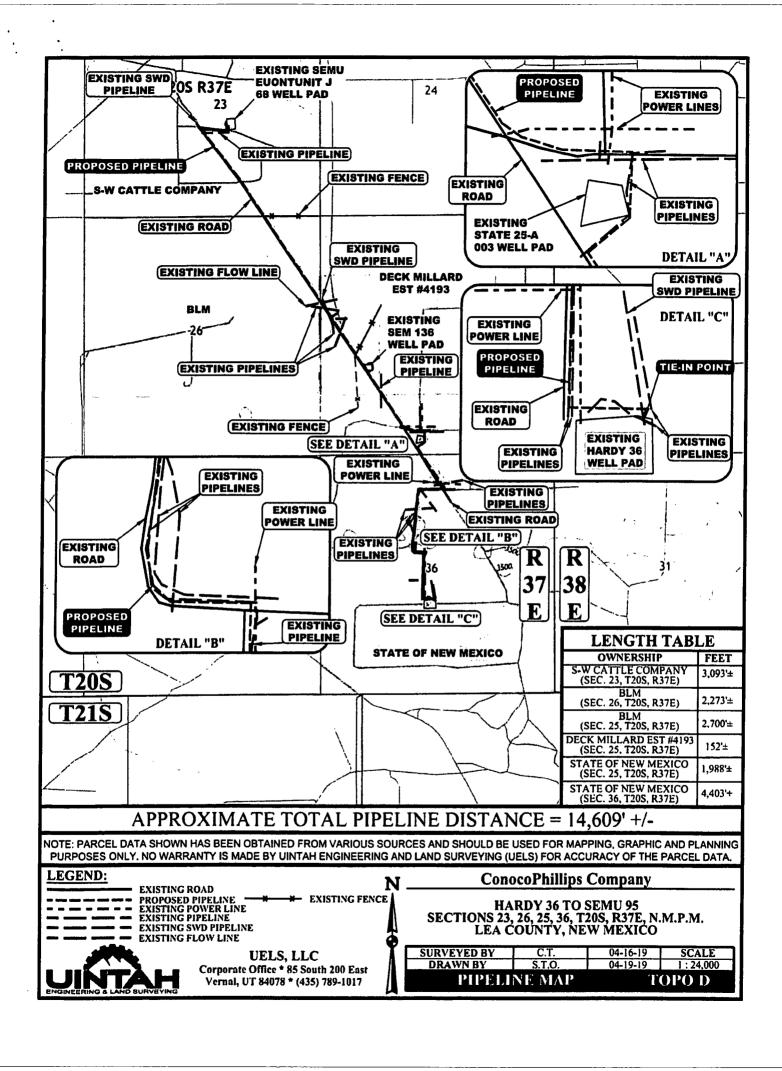


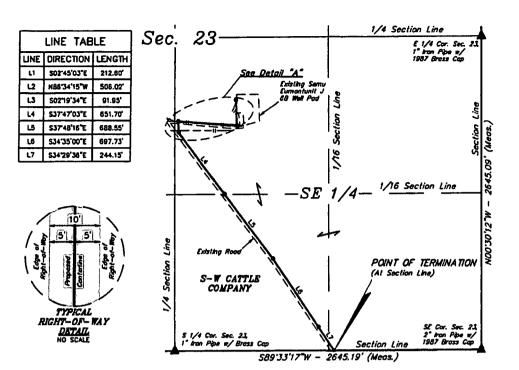


#### FLOW LINE RIGHT-OF-WAY DESCRIPTION

A 10' WIDE RIGHT-OF-WAY 5' ON EACH SIDE OF THE FOLLOWING DESCRIBED CENTERLINE.

BEGINNING AT A POINT IN THE NW 1/4 SE 1/4 OF SECTION 23, T20S, R37E, N.M.P.M., WHICH BEARS S75'31'09"W 2184.20'
FROM THE EAST 1/4 CORNER OF SAID SECTION 23, THENCE S02'45'03"E 212.60'; THENCE N86'34'15"W 506.02'; THENCE
S02'19'34"E 91.95'; THENCE S37'47'03"E 651.70'; THENCE S37'48'16"E 688.55'; THENCE S34'35'00"E 697.73'; THENCE
S34'29'36"E 244.15' TO A POINT ON THE SOUTH LINE OF THE SE 1/4 SE 1/4 OF SAID SECTION 23, WHICH BEARS
S89'33'17"W 1273.61' FROM THE SOUTHEAST CORNER OF SAID SECTION 23. THE SIDE LINES OF SAID DESCRIBED RIGHT-OF-WAY BEING SHORTENED OR ELONGATED TO MEET THE GRANTOR'S PROPERTY LINES. BASIS OF BEARINGS IS A TRANSVERSE MERCATOR PROJECTION WITH A CENTRAL MERIDIAN OF WIO3'53'00". CONTAINS 0.710 ACRES MORE OR LESS.

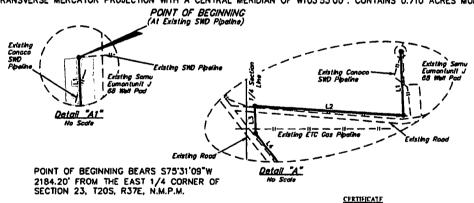

POINT OF TERMINATION BEARS SB9'33'17"W 1273.61' FROM THE SOUTHEAST CORNER OF SECTION 23, T20S, R37E, N.M.P.M.

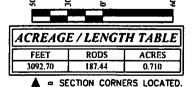

TO THE

FILE: 65751-A

to a Transporter Metecatus Projectado with a Control Mendian of W10315 VMF


ConocoPhillips Company HARDY 36 TO SEMU 95 ON S-W CATTLE COMPANY LANDS IN SECTION 23, T20S, R37E, N.M.P.M. LEA COUNTY, NEW MEXICO

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SURVEYED BY SCALE 1" = 600' 04-16-19 **UELS, LLC** DRAWN BY 04-19-19 FLOW LINE R-O-W




Corporate Office \* 85 South 200 East Vernal, UT 84078 \* (435) 789-1017

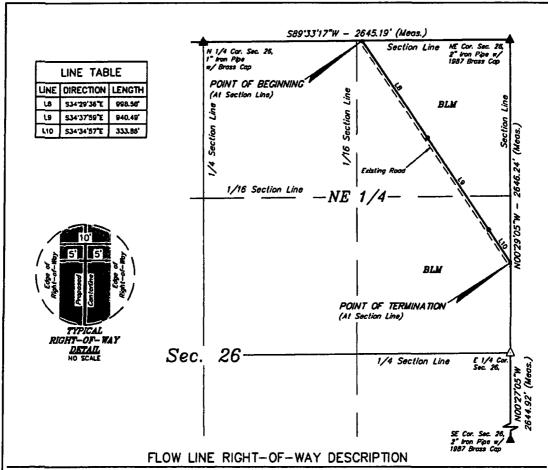

BEGINNING AT A POINT ON THE NORTH LINE OF THE NE 1/4 NE 1/4 OF SECTION 26, T20S, R37E, N.M.P.M., WHICH BEARS S89'33'17"W 1273.61' FROM THE NORTHEAST CORNER OF SAID SECTION 26, THENCE S34'29'36"E 998.58'; THENCE S34'37'59"E 940.49'; THENCE S34'34'57"E 333.86' TO A POINT ON THE EAST LINE OF THE SE 1/4 NE 1/4 OF SAID SECTION 26, WHICH BEARS S00'29'05"E 1881.70' FROM THE NORTHEAST CORNER OF SAID SECTION 26. THE SIDE LINES OF SAID DESCRIBED RIGHT-OF-WAY BEING SHORTENED OR ELONGATED TO MEET THE GRANTOR'S PROPERTY LINES. BASIS OF BEARINGS IS A TRANSVERSE MERCATOR PROJECTION WITH A CENTRAL MERIDIAN OF WIO3'53'00". CONTAINS 0.522 ACRES MORE OR LESS.

POINT OF BEGINNING BEARS S89'33'17"W 1273.61' FROM THE NORTHEAST CORNER OF SECTION 26, T20S, R37E, N.M.P.M.

POINT OF TERMINATION BEARS S00'29'05"E 1881.70' FROM THE NORTHEAST CORNER OF SECTION 26, T20S, R37E, N.M.P.M.

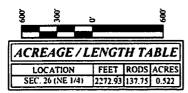

- SECTION CORNERS LOCATED. △ = SECTION CORNERS RE-ESTABLISHED.

(Not Set on Ground.)

CERTIFICATE
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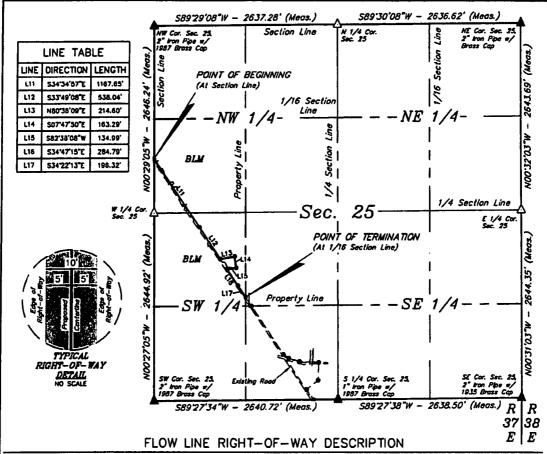
FILE: 65751-B

NOTES:
Basis of Bearings is a Transverse Mercatur Projection with a Central Meridian of W103/5300



UELS, LLC
Corporate Office \* 85 South 200 East Vernal, UT 84078 \* (435) 789-1017


	11000				
N	Co	nocoPhillips	Company		
I		HARDY 36 TO ON BLM LA ION 26, T20S, I COUNTY, NI	NDS IN	1.	
Y	SURVEYED BY C.T. 04-16-19 SCALE				
Λ	DRAWN BY J.P.P. 04-19-19 1" = 600'				
4	E R-O-W				



BEGINNING AT A POINT ON THE WEST LINE OF THE SW 1/4 NW 1/4 OF SECTION 25, T20S, R37E, N.M.P.M., WHICH BEARS S00'29'05"E 1881.70' FROM THE NORTHWEST CORNER OF SAID SECTION 25, THENCE S34'34'57"E 1167.65'; THENCE S33'49'08"E 538.04'; THENCE N80'36'09"E 214.60'; THENCE S07'47'50"E 163.29'; THENCE S82'38'08"W 134.99'; THENCE S34'47'15"E 284.79'; THENCE S34'22'13"E 196.32' TO A POINT ON THE EAST LINE OF THE NW 1/4 SW 1/4 OF SAID SECTION 25, WHICH BEARS N42'51'15"W 1959.02' FROM THE SOUTH 1/4 CORNER OF SAID SECTION 25. THE SIDE LINES OF SAID DESCRIBED RIGHT-OF-WAY BEING SHORTENED OR ELONGATED TO MEET THE GRANTOR'S PROPERTY LINES. BASIS OF BEARINGS IS A TRANSVERSE MERCATOR PROJECTION WITH A CENTRAL MERIDIAN OF W103'53'00". CONTAINS 0.620 ACRES MORE OR LESS.

POINT OF BEGINNING BEARS S00'29'05"E 1881.70' FROM THE NORTHWEST CORNER OF SECTION 25, T20S, R37E, N.M.P.M.

POINT OF TERMINATION BEARS N42'51'15"W 1959.02' FROM THE SOUTH 1/4 CORNER OF SECTION 25, T20S, R37E, N.M.P.M.

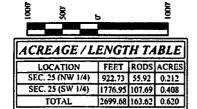

= SECTION CORNERS LOCATED.


△ = SECTION CORNERS RE-ESTABLISHED.
(Not Set on Ground.)

FILE: 65751-C

Basis of Bearings is a Transverse Mercator Projection with a Central Mendian of W103 '53'00'

LINTAH


UELS, LLC Corporate Office \* 85 South 200 East Vernal, UT 84078 \* (435) 789-1017

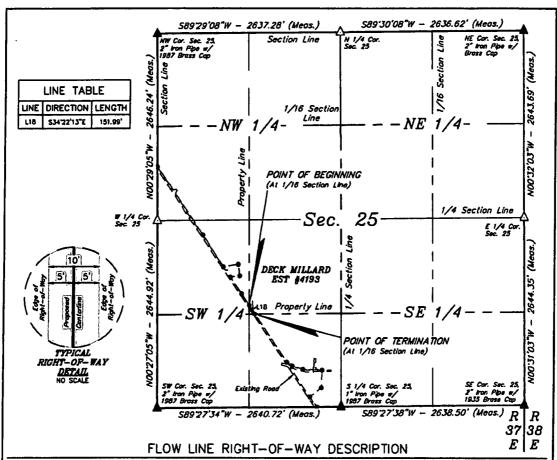

BEGINNING AT A POINT ON THE WEST LINE OF THE NE 1/4 SW 1/4 OF SECTION 25, T20S, R37E, N.M.P.M., WHICH BEARS N42'51'15"W 1959.02' FROM THE SOUTH 1/4 CORNER OF SAID SECTION 25, THENCE S34'22'13"E 151.99' TO A POINT ON THE SOUTH LINE OF THE NE 1/4 SW 1/4 OF SAID SECTION 25, WHICH BEARS N43'33'52"W 1808.83' FROM THE SOUTH 1/4 CORNER OF SAID SECTION 25. THE SIDE LINES OF SAID DESCRIBED RIGHT-OF-WAY BEING SHORTENED OR ELONGATED TO MEET THE GRANTOR'S PROPERTY LINES. BASIS OF BEARINGS IS A TRANSVERSE MERCATOR PROJECTION WITH A CENTRAL MERIDIAN OF W103'53'00". CONTAINS 0.035 ACRES MORE OR LESS.

POINT OF BEGINNING BEARS N42'51'15"W 1959.02' FROM THE SOUTH 1/4 CORNER OF SECTION 25, T20S, R37E, N.M.P.M.

POINT OF TERMINATION BEARS N43'33'52"W 1808.83' FROM THE SOUTH 1/4 CORNER OF SECTION 25, T20S, R37E, N.M.P.M.

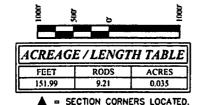

CERTIFICATE
THIS IS TO CERTIFY THAT THIS EASEMENT PLAT AND
THE ACTUAL SUBVEYOR THE GROUND UPON WHICH IT
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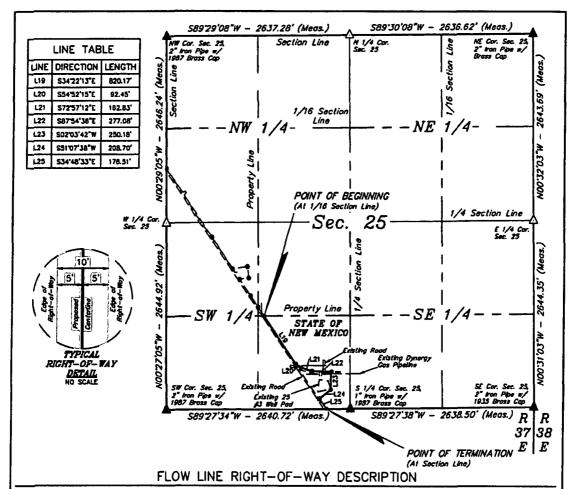
NOTES:

Basis of Bearings is a Transverse Mercutor Projection with a Central Mendian of W103\*53'00'

UELS, LLC Corporate Office \* 85 South 200 East Vergal, UT 84078 \* (435) 789-1017

ConocoPhillips Company N HARDY 36 TO SEMU 95 ON DECK MILLARD EST #4193 LANDS IN SECTION 25, T20S, R37E, N.M.P.M. LEA COUNTY, NEW MEXICO SURVEYED BY 04-16-19 SCALE 1" = 1000' DRAWN BY


FLOW LINE R-O-W



BEGINNING AT A POINT ON THE NORTH LINE OF THE SE 1/4 SW 1/4 OF SECTION 25, T20S, R37E, N.M.P.M., WHICH BEARS N43'33'52"W 1808.83' FROM THE SOUTH 1/4 CORNER OF SAID SECTION 25, THENCE S34'22'13"E 820.17'; THENCE S54'52'15"E 92.45'; THENCE S72'57'12"E 162.83'; THENCE S87'54'36"E 277.08'; THENCE S02'03'42"W 250.18'; THENCE S51'07'38"W 208.70'; THENCE S34'48'33"E 176.51' TO A POINT ON THE SOUTH LINE OF THE SE 1/4 SW 1/4 OF SAID SECTION 25, WHICH BEARS S89'27'34"W 346.13' FROM THE SOUTH 1/4 CORNER OF SAID SECTION 25. THE SIDE LINES OF SAID DESCRIBED RIGHT-OF-WAY BEING SHORTENED OR ELONGATED TO MEET THE GRANTOR'S PROPERTY LINES. BASIS OF BEARINGCS IS A TRANSVERSE MERCATOR PROJECTION WITH A CENTRAL MERIDIAN OF W103'53'00". CONTAINS 0.456 ACRES MORE OR LESS.

POINT OF BEGINNING BEARS N43'33'52"W 1808.83' FROM THE SOUTH 1/4 CORNER OF SECTION 25, T20S, R37E, N.M.P.M.

POINT OF TERMINATION BEARS S89'27'34"W 346.13' FROM THE SOUTH 1/4 CORNER OF SECTION 25, T20S, R37E, N.M.P.M.

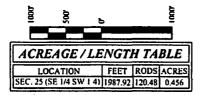

▲ = SECTION CORNERS LOCATED.

△ = SECTION CORNERS RE-ESTABLISHED.

(Not Set on Ground.)

CERTIFICATE
THIS TO CERTIFY THAT THIS EASEMENT PLAT AND
THE ACTUAL SURVING ON THE GROUND UPON WHICH IT
IS BASED WERD PERFORMUP BY THE OR UNDER MY
DIRECT SUPRIVISION. THAT I ARRESONS HE FOR
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(EFFES): Blasts of Beautings is a Transverse Mercator Projection with a Central Mendian of W103\*53'00'


ConocoPhillips Company


FILE: 65751-E

HARDY 36 TO SEMU 95
ON STATE OF NEW MEXICO LANDS IN
SECTION 25, T20S, R37E, N.M.P.M.
LEA COUNTY, NEW MEXICO



UELS, LLC Corporate Office \* 85 South 200 East Vernal, UT 84078 \* (435) 789-1017

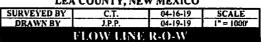

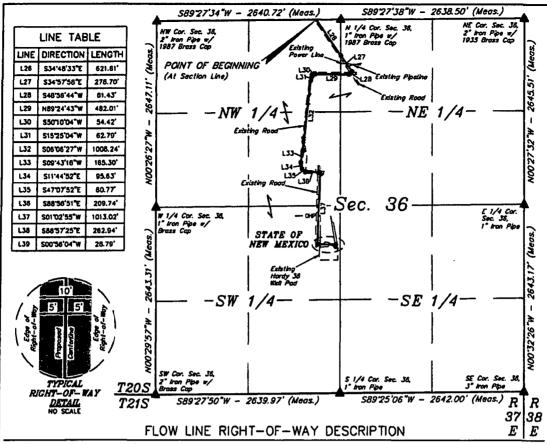

BEGINNING AT A POINT ON THE NORTH LINE OF THE NE 1/4 NW 1/4 OF SECTION 36, T20S, R37E, N.M.P.M., WHICH BEARS SB9'27'34"W 346.13' FROM THE NORTH 1/4 CORNER OF SAID SECTION 36, THENCE S34'48'33"E 621.61'; THENCE S34'57'58"E 278.70'; THENCE S48'56'44"W 61.43'; THENCE N89"24'43"W 482.01'; THENCE S50'10'04"W 54.42'; THENCE S15'25'04"W 62.79'; THENCE S06'06'27"W 1006.24'; THENCE S09'43'16"W 165.30'; THENCE S11'44'52"E 95.63'; THENCE S47'07'52"E 60.77'; THENCE S88'56'51"E 209.74'; THENCE S01'02'55"W 1013.02'; THENCE S88'57'25"E 262.94'; THENCE S00'56'04"W 28.79' TO A POINT IN THE NE 1/4 SW 1/4 OF SAID SECTION 36, WHICH BEARS NO2"10"10"W 2070.41' FROM THE SOUTH 1/4 CORNER OF SAID SECTION 36. THE SIDE LINES OF SAID DESCRIBED RIGHT-OF-WAY BEING SHORTENED OR ELONGATED TO MEET THE GRANTOR'S PROPERTY LINES. BASIS OF BEARINGS IS A TRANSVERSE MERCATOR PROJECTION WITH A CENTRAL MERIDIAN OF WIO3'53'00". CONTAINS 1.011 ACRES MORE OR LESS.


POINT OF BEGINNING BEARS S89'27'34"W 346.13' FROM THE NORTH 1/4 CORNER OF SECTION 36, T20S, R37E, N.M.P.M.

POINT OF TERMINATION BEARS NO2"10"10"W 2070.41' FROM THE SOUTH 1/4 CORNER OF SECTION 36, T20S. R37E, N.M.P.M.



ACREAGE / LENGTH TABLE				
	FEET			
SEC. 36 (NE 1/4 NW 1/4)	1554.34	94.20	0,357	
SEC. 36 (NW 1/4 NE 1/4)	464.10	28.13	0.107	
SEC. 36 (SE 1/4 NW 1/4)	1554.33	94.20	0.357	
SEC. 36 (NE 1/4 SW 1/4)	830.62	50.34	0.191	
	4403.39			

= SECTION CORNERS LOCATED.

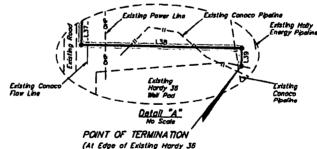

(At Edge of Existing Hardy 36 Well Pad)

CFRYIFICATE
THIS IS TO CERTIFY THAT THIS EASEMENT PLAT AND CREOD (ID-BY AT ON UNDER MY
VEN. THAT TAMKES UNSIBLE FOR THIS SU THE

FILE: 65751-F

NOTES:

Basis of Bearings is a Transverse Meterstor Projection with a Central Menchan of W103\*53'00'



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ConocoPhillips Company HARDY 36 TO SEMU 95 ON STATE OF NEW MEXICO LANDS IN SECTION 36, T20S, R37E, N.M.P.M. LEA COUNTY, NEW MEXICO

SURVEYED BY 04-16-19 SCALE DRAWN BY 1" = 1000" FLOW LINE R-O-W

BLM LEASE NUMBER: NMNM0557686 COMPANY NAME: ConocoPhillips Company ASSOCIATED WELL NAME: Semu 95

#### STANDARD STIPULATIONS FOR SURFACE INSTALLED PIPELINES

A copy of the application (Grant, Sundry Notice, APD) and attachments, including stipulations, survey plat and/or map, will be on location during construction. BLM personnel may request to you a copy of your permit during construction to ensure compliance with all stipulations.

Holder agrees to comply with the following stipulations to the satisfaction of the Authorized Officer:

- 1. The holder shall indemnify the United States against any liability for damage to life or property arising from the occupancy or use of public lands under this grant.
- 2. The holder shall comply with all applicable Federal laws and regulations existing or hereafter enacted or promulgated. In any event, the holder shall comply with the Toxic Substances Control Act of 1976 as amended, 15 USC 2601 et seq. (1982) with regards to any toxic substances that are used, generated by or stored on the right-of-way or on facilities authorized under this right-of-way grant. (See 40 CFR, Part 702-799 and especially, provisions on polychlorinated biphenyls, 40 CFR 761.1-761.193.) Additionally, any release of toxic substances (leaks, spills, etc.) in excess of the reportable quantity established by 40 CFR, Part 117 shall be reported as required by the Comprehensive Environmental Response, Compensation, and Liability Act, section 102b. A copy of any report required or requested by any Federal agency or State government as a result of a reportable release or spill of any toxic substances shall be furnished to the authorized officer concurrent with the filing of the reports to the involved Federal agency or State government.
- 3. The holder agrees to indemnify the United States against any liability arising from the release of any hazardous substance or hazardous waste (as these terms are defined in the Comprehensive Environmental Response, Compensation and Liability Act of 1980, 42 U.S.C. 9601, et seq. or the Resource Conservation and Recovery Act, 42 U.S.C. 6901, et seq.) on the Right-of-Way (unless the release or threatened release is wholly unrelated to activity of the Right-of-Way holder's activity on the Right-of-Way), or resulting from the activity of the Right-of-Way holder on the Right-of-Way. This agreement applies without regard to whether a release is caused by the holder, its agent, or unrelated third parties.
- 4. The holder shall be liable for damage or injury to the United States to the extent provided by 43 CFR Sec. 2883.1-4. The holder shall be held to a standard of strict liability for damage or injury to the United States resulting from pipe rupture, fire, or spills caused or substantially aggravated by any of the following within the right-of-way or permit area:
  - a. Activities of the holder including, but not limited to construction, operation, maintenance,

and termination of the facility.

- b. Activities of other parties including, but not limited to:
  - (1) Land clearing.
  - (2) Earth-disturbing and earth-moving work.
  - (3) Blasting.
  - (4) Vandalism and sabotage.
- c. Acts of God.

The maximum limitation for such strict liability damages shall not exceed one million dollars (\$1,000,000) for any one event, and any liability in excess of such amount shall be determined by the ordinary rules of negligence of the jurisdiction in which the damage or injury occurred.

This section shall not impose strict liability for damage or injury resulting primarily from an act of war or from the negligent acts or omissions of the United States.

- 5. If, during any phase of the construction, operation, maintenance, or termination of the pipeline, any oil, salt water, or other pollutant should be discharged from the pipeline system, impacting Federal lands, the control and total removal, disposal, and cleaning up of such oil, salt water, or other pollutant, wherever found, shall be the responsibility of the holder, regardless of fault. Upon failure of the holder to control, dispose of, or clean up such discharge on or affecting Federal lands, or to repair all damages resulting therefrom, on the Federal lands, the Authorized Officer may take such measures as he deems necessary to control and clean up the discharge and restore the area, including, where appropriate, the aquatic environment and fish and wildlife habitats, at the full expense of the holder. Such action by the Authorized Officer shall not relieve the holder of any responsibility as provided herein.
- 6. All construction and maintenance activity will be confined to the authorized right-of-way width of 10 feet. If the pipeline route follows an existing road or buried pipeline right-of-way, the surface pipeline must be installed no farther than 10 feet from the edge of the road or buried pipeline right-of-way. If existing surface pipelines prevent this distance, the proposed surface pipeline must be installed immediately adjacent to the outer surface pipeline. All construction and maintenance activity will be confined to existing roads or right-of-ways.
- 7. No blading or clearing of any vegetation will be allowed unless approved in writing by the Authorized Officer.
- 8. The holder shall install the pipeline on the surface in such a manner that will minimize suspension of the pipeline across low areas in the terrain. In hummocky of duney areas, the pipeline will be "snaked" around hummocks and dunes rather then suspended across these features.
- 9. The pipeline shall be buried with a minimum of 24 inches under all roads, "two-tracks," and trails. Burial of the pipe will continue for 20 feet on each side of each crossing. The condition of the road, upon completion of construction, shall be returned to at least its former state with no bumps or dips remaining in the road surface.

- 10. The holder shall minimize disturbance to existing fences and other improvements on public lands. The holder is required to promptly repair improvements to at least their former state. Functional use of these improvements will be maintained at all times. The holder will contact the owner of any improvements prior to disturbing them. When necessary to pass through a fence line, the fence shall be braced on both sides of the passageway prior to cutting of the fence. No permanent gates will be allowed unless approved by the Authorized Officer.
- 11. In those areas where erosion control structures are required to stabilize soil conditions, the holder will install such structures as are suitable for the specific soil conditions being encountered and which are in accordance with sound resource management practices.
- 12. Excluding the pipe, all above-ground structures not subject to safety requirement shall be painted by the holder to blend with the natural color of the landscape. The paint used shall be a color which simulates "Standard Environmental Colors" Shale Green, Munsell Soil Color No. 5Y 4/2; designated by the Rocky Mountain Five State Interagency Committee.
- 13. The pipeline will be identified by signs at the point of origin and completion of the right-of-way and at all road crossings. At a minimum, signs will state the holder's name, BLM serial number, and the product being transported. Signs will be maintained in a legible condition for the life of the pipeline.
- 14. The holder shall not use the pipeline route as a road for purposes other than routine maintenance as determined necessary by the Authorized Officer in consultation with the holder. The holder will take whatever steps are necessary to ensure that the pipeline route is not used as a roadway.
- 15. Any cultural and/or paleontological resource (historic or prehistoric site or object) discovered by the holder, or any person working on his behalf, on public or Federal land shall be immediately reported to the authorized officer. Holder shall suspend all operations in the immediate area of such discovery until written authorization to proceed is issued by the authorized officer. An evaluation of the discovery will be made by the authorized officer to determine appropriate cultural or scientific values. The holder will be responsible for the cost of evaluation and any decision as to proper mitigation measures will be made by the authorized officer after consulting with the holder.
- 16. The operator shall be held responsible if noxious weeds become established within the areas of operations. Weed control shall be required on the disturbed land where noxious weeds exist, which includes the roads, powerline corridor, and adjacent land affected by the establishment of weeds due to this action. The operator shall consult with the Authorized Officer for acceptable weed control methods, which include following EPA and BLM requirements and policies.
- 17. Surface pipelines must be less than or equal to 4 inches and a working pressure below 125 psi.

#### 18. Special Stipulations:

#### Wildlife:

a. <u>Lesser Prairie-Chicken:</u> Oil and gas activities will not be allowed in lesser prairie-chicken habitat during the period from March 1st through June 15th annually. During that period, other activities that produce noise or involve human activity, such as the maintenance of oil and gas facilities and pipeline, road, and well pad construction, will be allowed except between 3:00 am and 9:00 am. The 3:00 am to 9:00 am restriction will not apply to normal, around-the-clock operations, such as venting, flaring, or pumping, which do not require a human presence during this period. Normal vehicle use on existing roads will not be restricted.

#### **Hydrology:**

a. When crossing ephemeral drainages, the pipeline(s) will be buried to a minimum depth of 48 inches from the top of pipe to ground level. Erosion control methods such as gabions and/or rock aprons should be placed on both up and downstream sides of the pipeline crossing. In addition, curled (weed free) wood/straw fiber wattles/logs and/or silt fences should be placed on the downstream side for sediment control during construction and maintained until soils and vegetation have stabilized. Water bars should be placed within the ROW to divert and dissipate surface runoff. A pipeline access road is not permitted to cross these ephemeral drainages. Traffic should be diverted to a preexisting route. Additional seeding may be required in floodplains and drainages to restore energy dissipating vegetation.

#### Range:

#### a. Cattleguards

Where a permanent cattlegaurd is approved, an appropriately sized cattlegaurd(s) sufficient to carry out the project shall be installed and maintained at fence crossing(s). Any existing cattlegaurd(s) on the access road shall be repaired or replaced if they are damaged or have deteriorated beyond practical use. The operator shall be responsible for the condition of the existing cattlegaurd(s) that are in place and are utilized during lease operations. A gate shall be constructed on one side of the cattlegaurd and fastened securely to H-braces.

#### Fence Requirement

Where entry granted across a fence line, the fence must be braced and tied off on both sides of the passageway prior to cutting. Once the work is completed, the fence will be restored to its prior condition, or better. The operator shall notify the private surface landowner or the grazing allotment holder prior to crossing any fence(s).

#### **Livestock Watering Requirement**

Any damage to structures that provide water to livestock throughout the life of the well, caused by operations from the well site, must be immediately corrected by the operator. The operator must notify the BLM office (575-234-5972) and the private surface landowner or the grazing allotment holder if any damage occurs to structures that provide water to livestock.