Form 3160-5 (June 2015)

Rec'd 8/7/2020 - NMOCD

UNITED STATES DEPARTMENT OF THE INTERIOR BUREAU OF LAND MANAGEMENT

FORM APPROVED OMB NO. 1004-0137 Expires: January 31, 2018

5. Lease Serial No. NMLC062300

SUNDRY NOTICES AND REPORTS ON WELLS

| Do not use thi abandoned we | 6. If Indian, Allottee or Tribe Name | | | | | | |
|---|---|---|--|--|--|---|--|
| SUBMIT IN | TRIPLICATE - Other inst | page 2 | | 7. If Unit or CA/Agree | ment, Nar | me and/or No. | |
| Type of Well Gas Well □ Oth | ner | | | 8. Well Name and No. CO YETI 15 22 FE | D COM | 0051H | |
| 2. Name of Operator CHEVRON USA INCORPORA | Contact: | LAURA BEC A@CHEVRON | ERRA I.COM | | 9. API Well No. 30-025-45531-00 | 0-X1 | |
| 3a. Address 6301 DEAUVILLE BLVD MIDLAND, TX 79706 | | 3b. Phone No Ph: 432-68 | . (include area code) 37-7655 | | 10. Field and Pool or Exploratory Area WC025G06S253206M-BONE SPRING | | |
| 4. Location of Well (Footage, Sec., T | ., R., M., or Survey Description | <u> </u> :) | | | 11. County or Parish, S | State | |
| Sec 15 T25S R32E NWNE 10 32.137733 N Lat, 103.658531 | | | | | LEA COUNTY, N | ΜM | |
| 12. CHECK THE AF | PPROPRIATE BOX(ES) | TO INDICA | TE NATURE O | F NOTICE, | REPORT, OR OTH | ER DA | TA |
| TYPE OF SUBMISSION | | | TYPE OF | ACTION | | | |
| Notice of Intent ■ Notice of Intent Notice of Inten | ☐ Acidize | ☐ Dee | pen | ☐ Product | ion (Start/Resume) | □ Wat | ter Shut-Off |
| _ | ☐ Alter Casing | ☐ Hyd | Hydraulic Fracturing | | ation | ☐ Wel | ll Integrity |
| ☐ Subsequent Report | □ Casing Repair | ☐ Nev | v Construction | ☐ Recomp | olete | | ☑ Other Surface Disturbance |
| ☐ Final Abandonment Notice | ☐ Change Plans | ☐ Plug | g and Abandon | □ Tempor | arily Abandon | Surrac | |
| | ☐ Convert to Injection | □ Plug | g Back | ☐ Water I | Disposal | | |
| 13. Describe Proposed or Completed Ope If the proposal is to deepen directions Attach the Bond under which the wor following completion of the involved testing has been completed. Final Ab determined that the site is ready for final | ally or recomplete horizontally, it will be performed or provide operations. If the operation re- bandonment Notices must be fil | give subsurface the Bond No. or sults in a multip | locations and measu in file with BLM/BIA le completion or reco | red and true ve Required sul mpletion in a | ertical depths of all pertine osequent reports must be the new interval, a Form 3160 | ent marker filed withi)-4 must b | rs and zones. in 30 days be filed once |
| This request replaces sundry | EC # 511200 submitted 4 | /16/2020. | | | | | |
| Chevron respectfully requests Section 10, T25S-R32E of the landing pad and a road, 30' in Yeti Access Road. | Cotton Draw Developme | ent. This prop | osal includes a 5 | 0' x 50' aspl | nalt | | |
| For purposes of safety, we are debris and to be reseeded with | | 100' perimete | er to be cleared o | of brush and | | | |
| The helicopter landing zone parequiring emergency medical and | ad will be used for emergattention. Due to the locat | ency purpose tion of the fiel | es only to airlift pe d (restricted acce | ersonnel ess and | Accepted - NI | MOCL |) |
| 14. I hereby certify that the foregoing is | Electronic Submission # | USA INCORP | ORATED, sent to | the Hobbs | • | | |
| Name(Printed/Typed) LAURA BI | | | ATORY SP | | | | |
| Signature (Electronic S | Submission) | | Date 04/22/20 | 020 | | | |
| | THIS SPACE FO | OR FEDERA | L OR STATE | OFFICE U | SE | | |
| Approved By CODY LAYTON | | | TitleASSISTAN | IT FIELD M | ANAGER | Da | ate 08/03/2020 |
| Conditions of approval, if any, are attache certify that the applicant holds legal or equivalent which would entitle the applicant to condition. | iitable title to those rights in the | | Office Hobbs | | | | |

Additional data for EC transaction #512230 that would not fit on the form

32. Additional remarks, continued

isolated), the helicopter landing zone pad will significantly reduce critical emergency response time.

On-site review was conducted with BLM NRS on 4/21/2020.

Certified plats attached.

Revisions to Operator-Submitted EC Data for Sundry Notice #512230

Operator Submitted

BLM Revised (AFMSS)

DISTURB Sundry Type:

NOI

DISTURB NOI

NMLC062300 Lease:

NMLC062300

Agreement:

Operator:

CHEVRON USA INC 6301 DEAUVILLE BLVD MIDLAND, TX 79706

Ph: 432-687-7665

Admin Contact:

LAURA BECERRA REGULATORY SPECIALIST E-Mail: LBECERRA@CHEVRON.COM

Ph: 432-687-7655

Tech Contact:

LAURA BECERRA REGULATORY SPECIALIST E-Mail: LBECERRA@CHEVRON.COM

Ph: 432-687-7655

Location:

State: County:

NM LEA

Field/Pool: WILDCAT

Well/Facility:

CO YETI 15 22 FED COM 51H

Sec 15 T25S R32E Mer NMP NWNE 10FNL 1335FEL

CHEVRON USA INCORPORATED

6301 DEAUVILLE BLVD MIDLAND, TX 79706 Ph: 432.687.7100 Fx: 432-687-7221

LAURA BECERRA REGULATORY SPECIALIST E-Mail: LBECERRA@CHEVRON.COM

Ph: 432-687-7655

LAURA BECERRA REGULATORY SPECIALIST

E-Mail: LBECERRA@CHEVRON.COM


Ph: 432-687-7655

NM LEA

WC025G06S253206M-BONE SPRING

CO YETI 15 22 FED COM 0051H Sec 15 T25S R32E NWNE 10FNL 1335FEL

32.137733 N Lat, 103.658531 W Lon

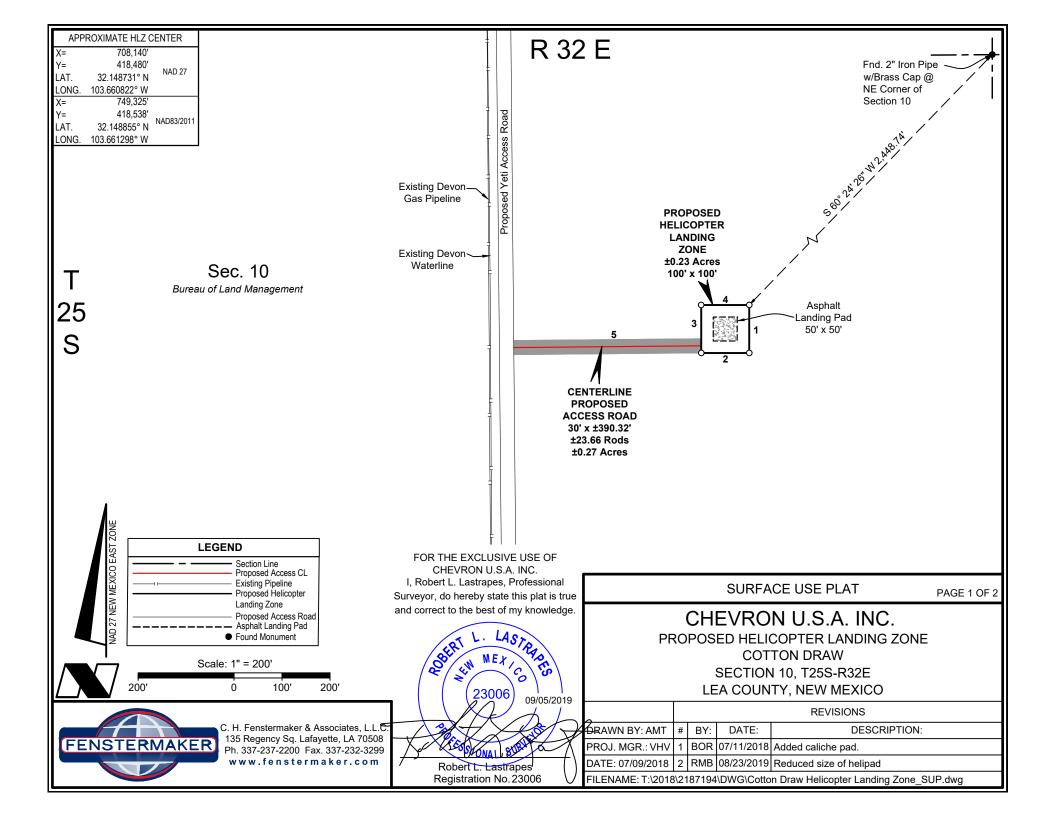

DISCLAIMER: At this time, C. H. Fenstermaker & Associates, L.L.C. has not performed nor was asked to perform any type of engineering, hydrological modeling, flood plain, or "No Rise" certification analyses, including but not limited to determining whether the project will impact flood hazards in connection with federal/FEMA, state, and/or local laws, ordinances and regulations. Accordingly, Fenstermaker makes no warranty or representation of any kind as to the foregoing issues, and persons or entities using this information shall do so at their own risk.

NOTE:

Please be advised, that while reasonable efforts are made to locate and verify pipelines and anomalies using our standard pipeline locating equipment, it is impossible to be 100 % effective. As such, we advise using caution when performing work as there is a possibility that pipelines and other hazards, such as fiber optic cables, PVC pipelines, etc. may exist undetected on site.

NOTE:

Many states maintain information centers that establish links between those who dig (excavators) and those who own and operate underground facilities (operators). It is advisable and in most states, law, for the contractor to contact the center for assistance in locating and marking underground utilities. For guidance, New Mexico One Call www.nm811.org.

| X= | 708,090' | | X= | 708,190' | |
|---------------------|---------------|------------|-----------------------|---------------|------------|
| Y= | 418,530' | NAD 27 | Y= | 418,530' | NAD 27 |
| LAT. | 32.148869° N | NAD 21 | LAT. | 32.148867° N | NAD 21 |
| LONG. | 103.660982° W | | LONG. | 103.660659° W | |
| X= | 749,275' | | X= | 749,375' | |
| Y= | 418,588' | NAD83/2011 | Y= | 418,588' | NAD00/0044 |
| LAT. | 32.148993° N | NAD83/2011 | LAT. | 32.148991° N | NAD83/2011 |
| LONG. | 103.661459° W | | LONG. | 103.661136° W | |
| ELEV. | +3,460' | NAVD88 | ELEV. | +3,461' | NAVD88 |
| SW | HELICOPTER LA | NDING | SE HELICOPTER LANDING | | |
| | ZONE CORNER | ₹ | | ZONE CORNE | R |
| X= | 708,090' | | X= | 708,190' | |
| Y= | 418,430' | NAD 27 | Y= | 418,430' | NAD 27 |
| LAT. | 32.148594° N | INAU ZI | LAT. | 32.148592° N | INAU 21 |
| LONG. | 103.660984° W | | LONG. | 103.660661° W | |
| X= | 749,275' | | X= | 749,375' | |
| Y= | 418,488' | NAD83/2011 | Y= | 418,488' | NAD83/2011 |
| LAT. | 32.148718° N | NAD03/2011 | LAT. | 32.148716° N | NAD03/2011 |
| LONG. | 103.661461° W | | LONG. | 103.661138° W | |
| ELEV. | +3,459' | NAVD88 | ELEV. | +3,460' | NAVD88 |
| PROPOSED HELICOPTER | | | | | |

NE HELICOPTER LANDING

ZONE CORNER

NW HELICOPTER LANDING

ZONE CORNER

| PROPOSED HELICOPTER LANDING ZONE | | | | | | |
|-------------------------------------|-------------------------|---------|--|--|--|--|
| COURSE | COURSE BEARING DISTANCE | | | | | |
| 1 | SOUTH | 100.00' | | | | |
| 2 | WEST | 100.00' | | | | |
| 3 | NORTH | 100.00' | | | | |
| 4 | EAST | 100.00' | | | | |

| CENTERLINE | | | | | | | |
|----------------------|-----------------|----------|--|--|--|--|--|
| PROPOSED ACCESS ROAD | | | | | | | |
| COURSE | BEARING | DISTANCE | | | | | |
| 5 | S 89° 27' 43" W | 390.32' | | | | | |

FOR THE EXCLUSIVE USE OF CHEVRON U.S.A. INC.
I, Robert L. Lastrapes, Professional Surveyor, do hereby state this plat is true and correct to the best of my knowledge.

23006) 09/05/2019

Robert L. Lastrapes
Registration No. 23006

SURFACE USE PLAT

PAGE 2 OF 2


CHEVRON U.S.A. INC.

PROPOSED HELICOPTER LANDING ZONE
COTTON DRAW
SECTION 10, T25S-R32E
LEA COUNTY, NEW MEXICO


| | | REVISIONS | | |
|---|---|--|------------|--------------------|
| DRAWN BY: AMT | # | BY: | DATE: | DESCRIPTION: |
| PROJ. MGR.: VHV | 1 | BOR | 07/11/2018 | Added caliche pad. |
| DATE: 07/09/2018 | 2 | 2 RMB 08/23/2019 Reduced size of helipad | | |
| FILENAME: T:\2018\2187194\DWG\Cotton Draw Helicopter Landing Zone_SUP.dwg | | | | |




C. H. Fenstermaker & Associates, L.L. C. 135 Regency Sq. Lafayette, LA 70508
Ph. 337-237-2200 Fax. 337-232-3299
www.fenstermaker.com

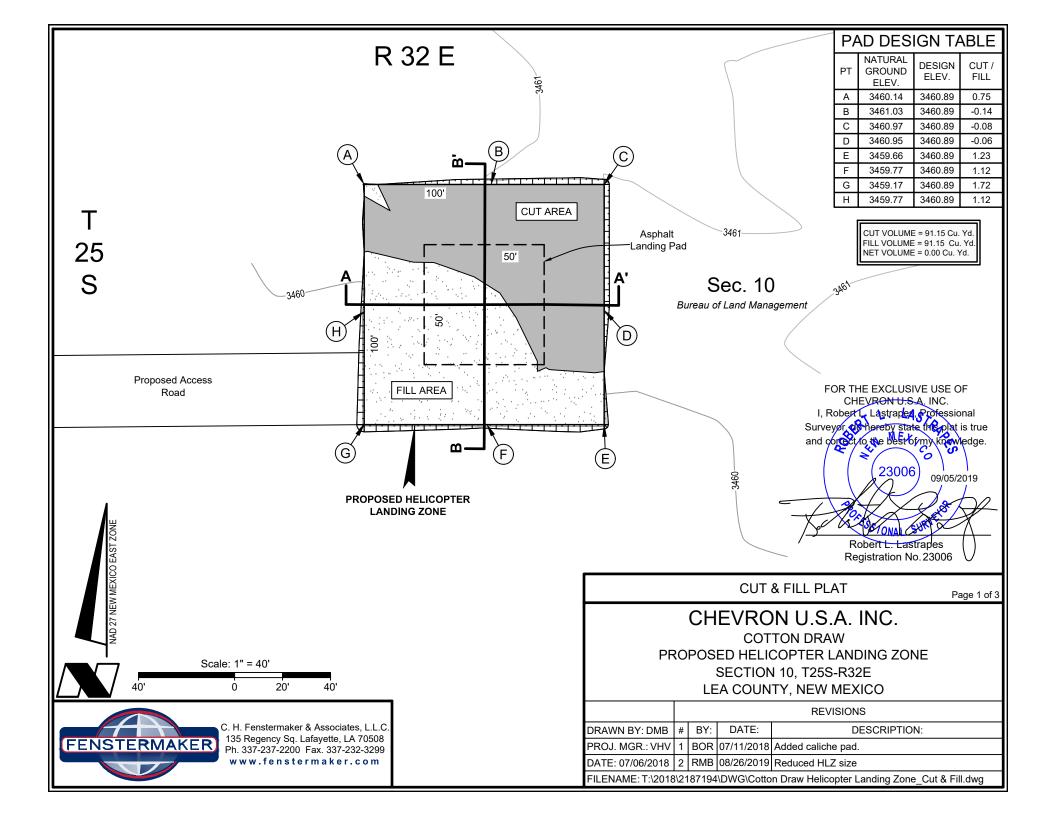

CROSS SECTION A-A' HORIZONTAL SCALE 1"=60' VERTICAL SCALE 1"=10'

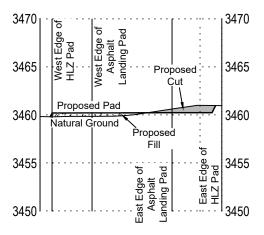

CROSS SECTION B-B' HORIZONTAL SCALE 1"=60' VERTICAL SCALE 1"=10'

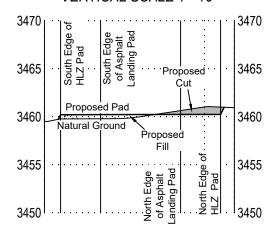

FOR THE EXCLUSIVE USE OF CHEVRON U.S.A. INC.

I, Robert Lastrapes Professional Surveyor of hereby state (he plat is true and correct to the best of my knowledge.

23006) 09/05/2019

Robert L. Lastrapes Registration No. 23006

CUT & FILL PLAT


Page 2 of 3

CHEVRON U.S.A. INC.

COTTON DRAW
PROPOSED HELICOPTER LANDING ZONE
SECTION 10, T25S-R32E
LEA COUNTY, NEW MEXICO

| | REVISIONS | | | |
|--|-----------|-----|------------|--------------------|
| DRAWN BY: DMB | # | BY: | DATE: | DESCRIPTION: |
| PROJ. MGR.: VHV | 1 | BOR | 07/11/2018 | Added caliche pad. |
| DATE: 07/06/2018 2 RMB 08/26/2019 Reduced HLZ size | | | | |
| FILENAME: T:\2018\2187194\DWG\Cotton Draw Helicopter Landing Zone_Cut & Fill.dwg | | | | |



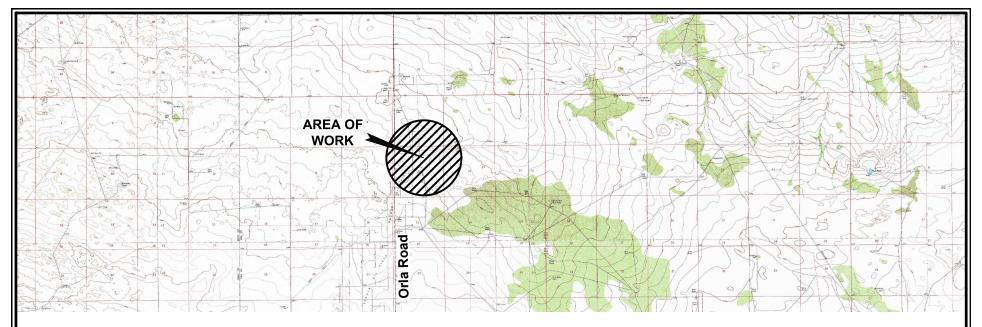

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Scale: 1" = 10,000' 10,000' 0 5,000' 10,000'

> C. H. Fenstermaker & Associates, L.L.C. 135 Regency Sq. Lafayette, LA 70508 Ph. 337-237-2200 Fax. 337-232-3299 www.fenstermaker.com

FOR THE EXCLUSIVE USE OF CHEVRON U.S.A. INC.
I, Robert L. Lastrapea, professional
Surveyor, to hereby state (his plat is true and core of to the best of my kingwledge.

23006) 09/05/2019

Robert L. Lastrapes
Registration No. 23006

NOTE:

- 1. Many states maintain information centers that establish links between those who dig (excavators) and those who own and operate underground facilities (operators). It is advisable and in most states, law, for the contractor to contact the center for assistance in locating and marking underground utilities. For guidance: New Mexico One Call www.nm811.org.
- 2. The design pad elevation recommendation is based solely on a cut and fill (1:1 ratio) balance of the pad and does not include material required for the access roads. A detailed soil test and slope stability analysis shall be performed prior to construction to ensure proper compaction and working performance of the pad under the anticipated loadings. This material balance sheet does not constitute a foundation design and C. H. Fenstermaker & Associates, L.L.C. makes no warranty to the structural integrity of the site layout as shown. Fenstermaker also makes no recommendation or warranty about the layout relative to flood hazards, erosion control, or soil stability issues. Elevations refer to the North American Vertical Datum of 1988.
- 3.Please be advised, that while reasonable efforts are made to locate and verify pipelines and anomalies using our standard pipeline locating equipment, it is impossible to be 100 % effective. As such, we advise using caution when performing work as there is a possibility that pipelines and other hazards, such as fiber optic cables, PVC pipelines, etc. may exist undetected on site.

CUT & FILL PLAT

Page 3 of 3

CHEVRON U.S.A. INC.

COTTON DRAW
PROPOSED HELICOPTER LANDING ZONE
SECTION 10, T25S-R32E
LEA COUNTY, NEW MEXICO

| | REVISIONS | | | |
|--|-----------|-----|------------|--------------------|
| DRAWN BY: DMB | # | BY: | DATE: | DESCRIPTION: |
| PROJ. MGR.: VHV | 1 | BOR | 07/11/2018 | Added caliche pad. |
| DATE: 07/06/2018 | 2 | RMB | 08/26/2019 | Reduced HLZ size |
| FILENAME: T:\2018\2187194\DWG\Cotton Draw Helicopter Landing Zone_Cut & Fill.dwg | | | | |