Form 3160-5 (March 2012)

#### **UNITED STATES** DEPARTMENT OF THE INTERIOR **BUREAU OF LAND MANAGEMENT**

FORM APPROVED OMB No. 1004-0137 Expires: October 31, 2014

SUNDRY	NOTICES	AND	REPORT	'S ON	WELLS	

Do not use this form for proposals to drill or to re-enter any con-

C 707 11 111	CO 14 3 7	
6. If Indian, Allottee	or Tribe Name	
10. II Indian, Anotice	or rince rautic	
*		
1		

	Use Form 3160-3 (APD	) for such proposals	S	
SUBMIT	IN TRIPLICATE - Other inst	ructions on page 2.	7. If Unit of CA/Agre	ement, Name and/or No.
1. Type of Well				
☑ Oil Well ☐ Gas W	Vell Other		8. Well Name and No BARNES FEDER	RAL #2
2. Name of Operator LEGACY RESE	RVES OPERATING LP		9. API Well No. 30-025-02664	
3a. Address	3b.	Phone No. (include area coa	le) 10. Field and Pool or	Exploratory Area
PO BOX 10848 MIDLAND, TX 7970	2	432-689-5200	BOUGH; ABO	
4. Location of Well (Footage, Sec., T., 660' FNL & 660' FWL, UNIT LETTER D, SE	· / · · ·		11. County or Parish, LEA COUNTY,	
12. CHEC	K THE APPROPRIATE BOX(E	S) TO INDICATE NATURE	OF NOTICE, REPORT OR OTH	IER DATA
TYPE OF SUBMISSION		TYI	PE OF ACTION	
Notice of Intent	Acidize	Deepen	Production (Start/Resume)	Water Shut-Off
	Alter Casing	Fracture Treat	Reclamation	Well Integrity
Subsequent Report	Casing Repair	New Construction	Recomplete	Other
	Change Plans	Plug and Abandon	Temporarily Abandon	
Final Abandonment Notice	Convert to Injection	Plug Back	Water Disposal	
14. I hereby certify that the foregoing is t	rue and correct. Name (Printed/Ty	ped)		
KEVIN BRACEY		Title OPERAT	IONS SUPERINTENDENT	
Signature Signature		Date 02/21/20	13	
	THIS SPACE FO	R FEDERAL OR ST	ATE OFFICE USE	
Approved by		Petro	eum Engineer	Date MAR 2 1 2013
Conditions of approval, if any, are attached that the applicant holds legal or equitable the entitle the applicant to conduct operations	title to those rights in the subject lea		KI	
Title 18 II S.C. Section 1001 and Title 43	IISC Section 1212 make it a prin	na for any pargon knowing also	nd willfully to make to ony denorting	ant or agancy of the United States and Salas

fictitious or fraudulent statements or representations as to any matter within its jurisdiction.

#### BUREAU OF LAND MANAGEMENT Carlsbad Field Office 620 East Greene Street Carlsbad, New Mexico 88220 575-234-5972

#### **Conditions of Approval**

#### Legacy Reserves Operating LP Barnes Federal #2 Lease NM96248 3002502664

60 FALT 660 FWU

- 1. Tank battery must be bermed/diked (must be able to contain 1 1/2 times the volume of the largest tank).
- 2. Submit for approval of water disposal method.
- 3. Submit updated facility diagrams as per Onshore Order #3
- 4. This agency shall be notified of any spill or discharge as required by NTL-3A.
- 5. All outstanding environmental issue must be addressed within 90 days. Contact Jim Amos for inspection and to resolve environmental issues. 575-234-5909
- Install legible well sign on location with operator name, well name and number, lease number, unit number, 1/4 1/4, section, township, and range. NMOCD requires the API number on well signs.
- 7. Subject to like approval by NMOCD.

BARNES FodoDA MM # 96248 API 30-025 - 21759 33. 525906 W- 103.309868 W 5.2 24 - T95 - R35E BARNES Fed 12 Nm # 9 6248 ADE " 30-025 - 02664 Sec 24 - T95 - R35F 5/I 33.525 OVO N - 103.319600 W

Proportion Phase

PUS - 01050>

PUL - SPEN

5U 1

SU 2

5u 3

BARNES FILLIN HI -ALLUMIUES Sould DU 1 - OPEN. Fill line for oil TANK when closed PUZ - Closes fil lin for al TANK PUB- Closed Poll Batton walve At End at line to Dall Botton line to Poll Botton line Fill line for water Tank Joles Phase IGAO line valu as a) TANK ISadi) load line walve on oil TANLLS. Il IGAD line WALDE On WATER TANK

to Gas Meter TO WILL HZ つ  $\supset$ J 0



# WATER ANALYSIS REPORT

**SAMPLE** 

Oil Co: LEGACY Date Sampled: 01/11/13 Date Analyzed: 01/14/13 Lease: BARNES

Lab ID Number: 01/14/13LEGACYBARNES FED-1 Well No.: FED-1

Location: TANK Account Manager: **B STRUBE** LAB


Attention: ACCT. MANAGER Requested By: File Name: 01/14/13LEGACYBARNES FED-1


**ANALYSIS** 

7.0 Note: 0 рН 1.073 2 Specific Gravity **BECCA** 

@80 F 3 CaCO<sub>3</sub> Saturation Index 0.61

,	©140 F	1 46		
	@140 F	1.46		
DISSOLVED GASES		MG/L	EQ. WT	MEQ/L
4 Hydrogen Sulfide		0		
5 Carbon Dioxide		53		
6 Dissolved Oxygen		NOT DETERMINI	ED	
CATIONS				
7 Calcium	(Ca <sup>++</sup> )	6,720	20.1	334.33
8 Magnesium	$(Mg^{++})$	1,714	12.2	140.48
9 Sodium	(Na <sup>++</sup> ) (Calculated)	31,509	23.0	1369.97
10 Barium	(Ba**)	0	68.7	0.00
ANIONS				
11 Hydroxyl	(OH <sup>+</sup> )		17.0	0.00
12 Carbonate	(CO <sub>3</sub> -)		30.0	0.00
13 Bicarbonate	$(HCO_3)$	305	61.1	4.99
14 Sulfate	(SO <sub>4</sub> )	156	48.8	3.20
15 Chloride	(Cl <sup>-</sup> )	65,000	35.5	1830.99
16 Total Dissolved Solids		105,559		
17 Total Iron	(Fe)	102	18.2	5.61
18 Total Hardness as CaCO <sub>3</sub>		23,850		
19 Resistivity-NaCl equivalent@	69 °F	0.0596	OHM~METERS	

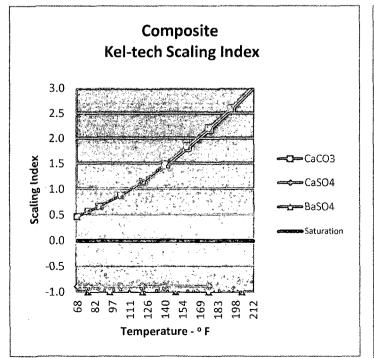

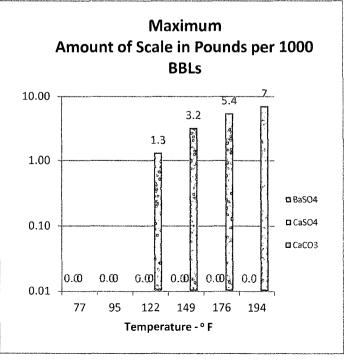

## **WATER DISPOSAL ONSHORE ORDER #7**

The following information is needed before your method of water disposal can be considered for approval.

Name	(s) of formation (s) producing water on the lease.  ARO
Amour	nt of water produced from each formation in barrels per day. / /ፋ ሬ ን ይ
How w	rater is stored on the lease. 300 651 Tank
How w	rater is moved to disposal facility.  Truck in Disposal
•	cor's of disposal facility  Lease name or well name and number <u>Redanson</u> らいり
b.	Location by ¼ ¼ Section, Township, and Range of the disposal system
C.	The appropriate NMOCD permit number
	Pipert # 212

#### Environmental Protection Agency Spill Prevention Control & Countermeasures Plan

#### Legacy Reserves

#### Barnes Federal #1, #2

#### Lea County, New Mexico

FACILITY INFORMATION	

1.0 Facility Type and Location					
Facility: Type of Facility: State Identification: Facility Location:	Barnes Federal #1, #2 Onshore Oil and Gas Production 30-025-21759 1.8 miles northeast of Crossroads				
County: Latitude: Direction to Facility:	Lea 33.525906 N Refer to Facility Location	State: Longitude: Map, Attachment 1	New Mexico 103.309868	W	
1.1 Facility Owner and Oper	ator				
Name and address of owner:					
Name: Address:	Legacy Reserves 303 W. Wall, Suite 1400 Midland, Texas 79701				
Telephone:	(432) 689-5200				
Name and address of operato	r:				
Name:	Legacy Reserves				
Address:	303 W. Wall, Suite 1400 Midland, Texas 79701				
Telephone:	(432) 689-5200				
2.0 Determination of Non-A	pplicability				
This Facility does not me	et the general applicability	requirements of 40	CFR, Part 112.1 (b)	)	
	an	d/or			
This Facility meets the non-ap	plicability requirements of	f 40 CFR, Part 112.1	(d) for the following	reasons:	
This Facility, due to its location, could not reasonably be expected to create a discharge of oil in harmful quantities into or upon navigable waters or adjoining shorelines. The nearest waters are 1.2 miles northeast and 2.3 miles east of site.					

This Facility is a natural gas production facility which does not produce merchantable quantities of oil.

This Facility has a storage capacity of less than 1,320 gallons of oil.

Operator: Legacy Reserves Facility: Barnes Federal #1, 2 Date: 05/23/12

# Location Map




#### **Directions:**

From the intersection of Highway 206 north and CR 182 near Crossroads, New Mexico; follow CR 182 east for 0.7 miles. Turn south following the road for 0.5 miles. Turn south following the road for 0.7 miles into Tank Battery.

Legacy Reserves Barnes Federal 1,2 Lea, NM

Figure 1 – Location Map

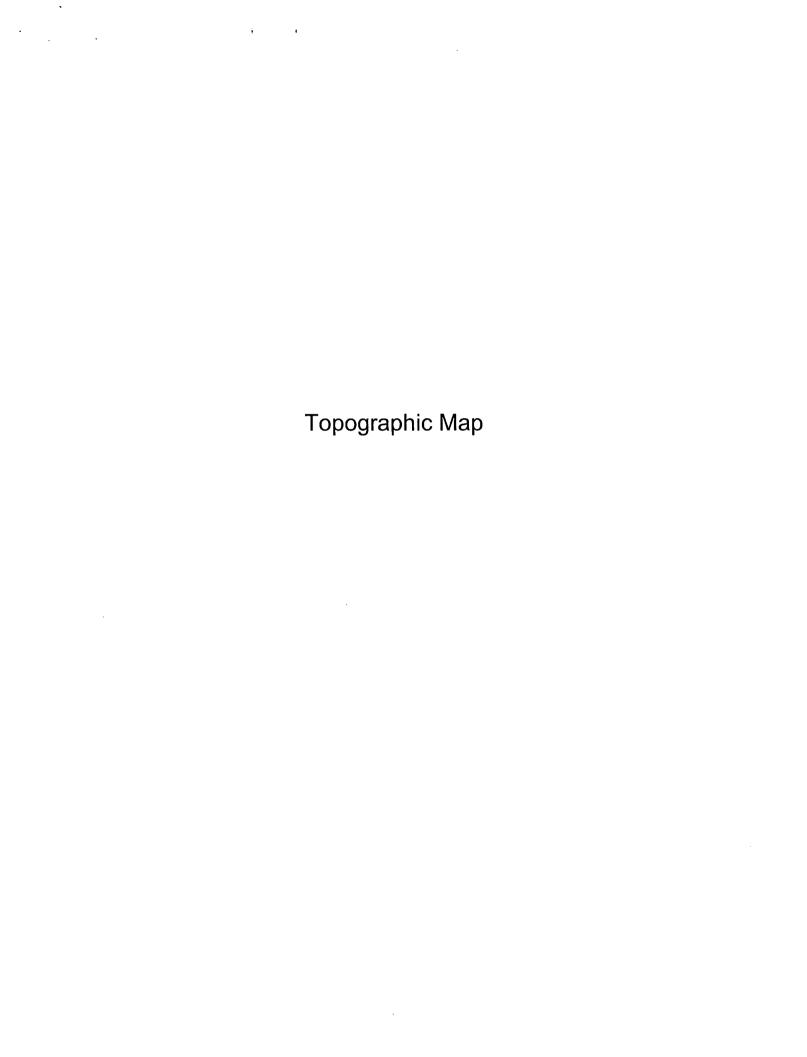


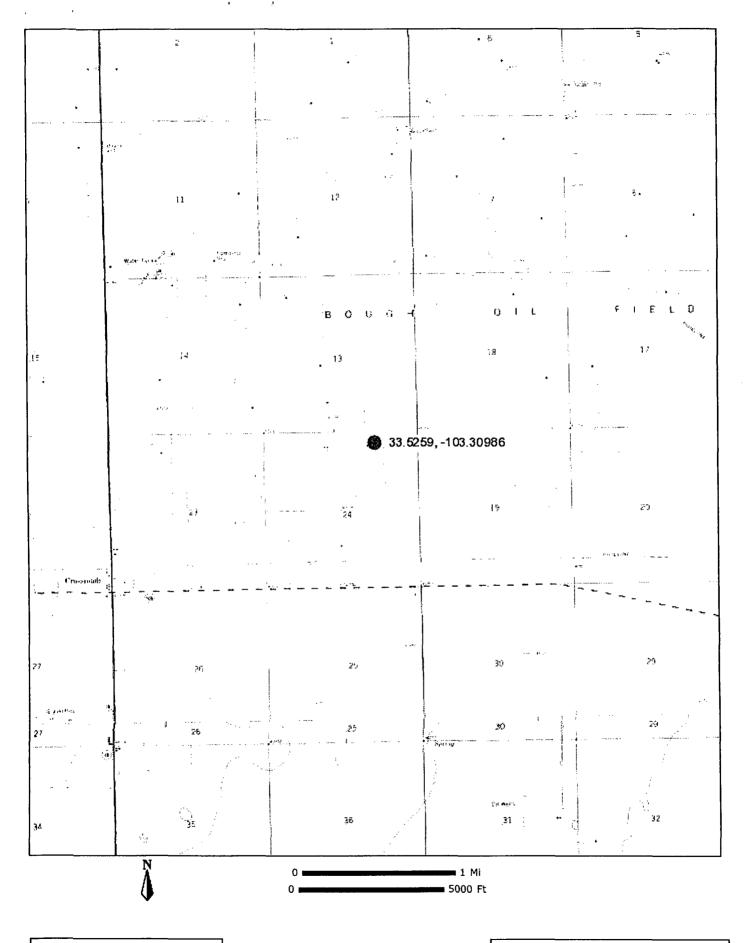


Figure 2-Topographic Map

Legacy Reserves / Barnes Federal 1,2 Lea County, New Mexico Site Plan

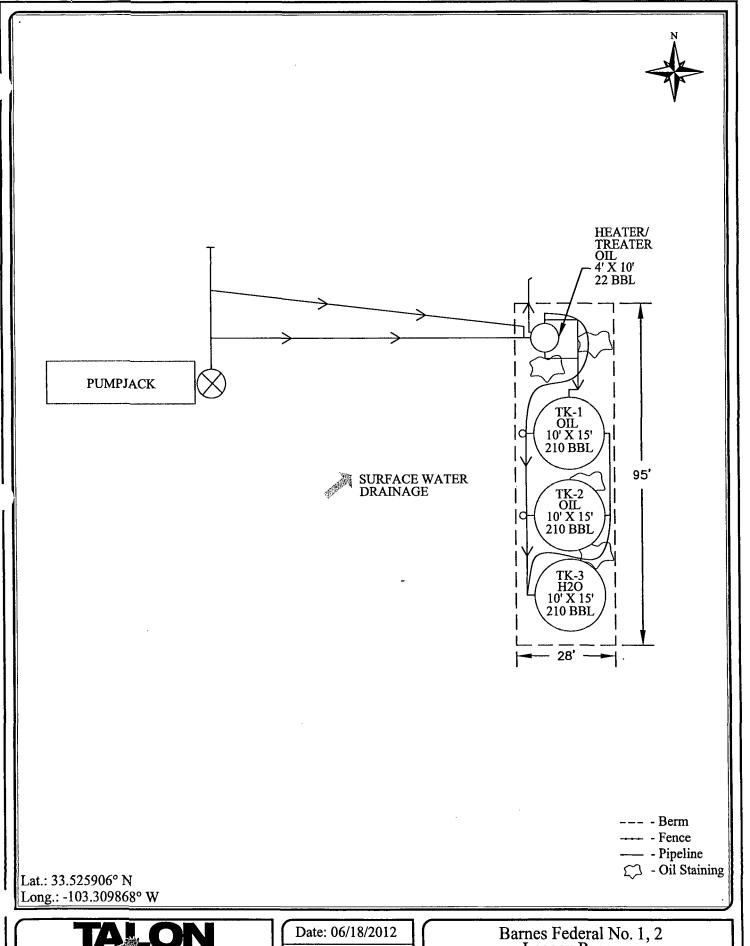


TALON

Scale: NTS

Drawn By: EMF

Barnes Federal No. 1, 2 Legacy Reserves Lea County, New Mexico SPCC Site Plan Site Detail Map

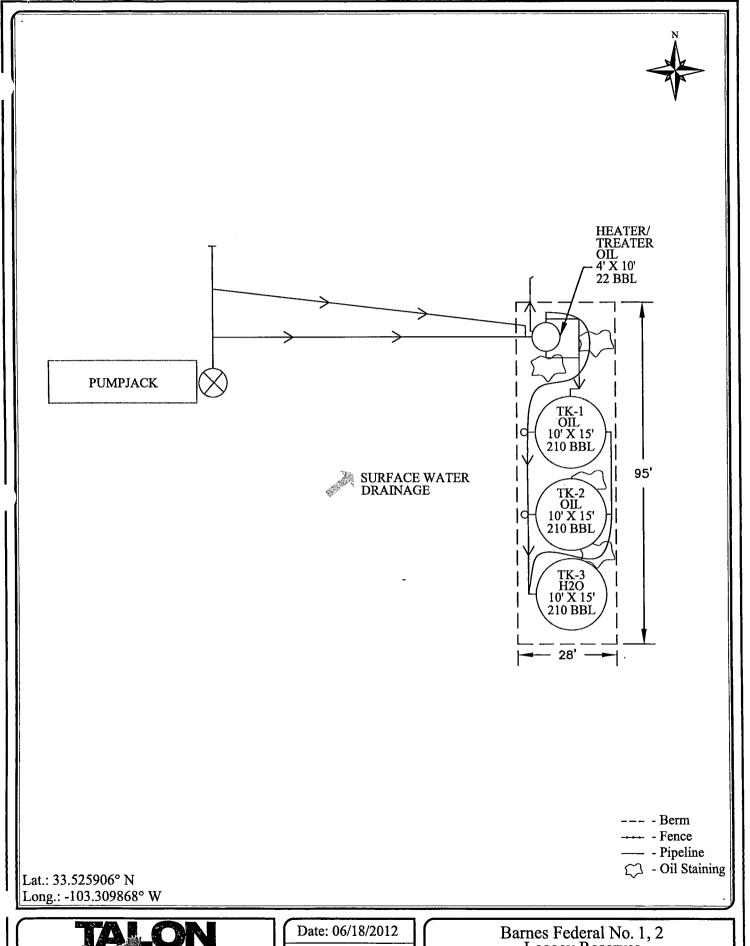



Scale: NTS

Drawn By: EMF

Barnes Federal No. 1, 2 Legacy Reserves Lea County, New Mexico SPCC Site Plan

# BUREAU OF LAND MANAGEMENT Carlsbad Field Office 620 East Greene Street Carlsbad, New Mexico 88220 575-234-5972

## Disposal of Produced Water From Federal Wells Conditions of Approval

Approval of the produced water disposal methodology is subject to the following conditions of approval:

- 1. This agency shall be notified of any change in your method or location of disposal.
- Compliance with all provisions of Onshore Order No. 7.
- 3. This agency shall be notified of any spill or discharge as required by NTL-3A.
- 4. This agency reserves the right to modify or rescind approval whenever it determines continued use of the approved method may adversely affect the surface or subsurface environments.
- 5. All above ground structures on the lease shall be painted Shale Green (5Y 4/2), or as per approved APD stipulations. This is to be done within 90 days, if you have not already done so.
- 6. Any on-lease open top storage tanks shall be covered with a protective cover to prevent entry by birds and other wildlife.
- 7. This approval should not constitute the granting of any right-of-way or construction rights not granted by the lease instrument.
- 8. If water is transported via a pipeline that extends beyond the lease boundary, then you need to submit within 30 days an application for right-of-way approval to the Realty Section in this office if you have not already done so.

9/22/09