

HOBBS OCD

JAN 28 2019

FORM APPROVED
OMB No. 1004-0137
Expires: January 31, 2018

UNITED STATES
DEPARTMENT OF THE INTERIOR
BUREAU OF LAND MANAGEMENT

RECEIVED

APPLICATION FOR PERMIT TO DRILL OR REENTER

1a. Type of work: <input checked="" type="checkbox"/> DRILL <input type="checkbox"/> REENTER		7. If Unit or CA Agreement, Name and No.
1b. Type of Well: <input checked="" type="checkbox"/> Oil Well <input type="checkbox"/> Gas Well <input type="checkbox"/> Other		8. Lease Name and Well No. CO YETI 15 22 FED COM 0055H (324932)
1c. Type of Completion: <input type="checkbox"/> Hydraulic Fracturing <input checked="" type="checkbox"/> Single Zone <input type="checkbox"/> Multiple Zone		9. API Well No. 30-024-45535
2. Name of Operator CHEVRON USA INCORPORATED [4323]	3a. Address 6301 Deauville Blvd. Midland TX 79706	3b. Phone No. (include area code) (432)687-7866
4. Location of Well (Report location clearly and in accordance with any State requirements. *) At surface NENE / 10 FNL / 1235 FEL / LAT 32.137734 / LONG -103.658211 At proposed prod. zone SESE / 100 FSL / 330 FEL / LAT 32.108958 / LONG -103.655336		10. Field and Pool, or Exploratory Wildcat BS (96715)
11. Sec., T. R. M. or Blk. and Survey or Area SEC 15 / T25S / R32E / NMP		12. County or Parish LEA
13. State NM		14. Distance in miles and direction from nearest town or post office* 29 miles
15. Distance from proposed* location to nearest property or lease line, ft. (Also to nearest drig. unit line, if any) 330 feet	16. No of acres in lease 2479.82	17. Spacing Unit dedicated to this well 640
18. Distance from proposed location* to nearest well, drilling, completed, applied for, on this lease, ft. 1015 feet	19. Proposed Depth 10623 feet / 21194 feet	20. BLM/BIA Bond No. in file FED: CA0329
21. Elevations (Show whether DF, KDB, RT, GL, etc.) 3452 feet	22. Approximate date work will start* 07/31/2019	23. Estimated duration 150 days
24. Attachments		

The following, completed in accordance with the requirements of Onshore Oil and Gas Order No. 1, and the Hydraulic Fracturing rule per 43 CFR 3162.3-3 (as applicable)

- | | |
|--|---|
| 1. Well plat certified by a registered surveyor. | 4. Bond to cover the operations unless covered by an existing bond on file (see Item 20 above). |
| 2. A Drilling Plan. | 5. Operator certification. |
| 3. A Surface Use Plan (if the location is on National Forest System Lands, the SUPO must be filed with the appropriate Forest Service Office). | 6. Such other site specific information and/or plans as may be requested by the BLM. |

25. Signature (Electronic Submission)	Name (Printed/Typed) Laura Becerra / Ph: (432)687-7665	Date 07/17/2018
Title Permitting Specialist		
Approved by (Signature) (Electronic Submission)	Name (Printed/Typed) Cody Layton / Ph: (575)234-5959	Date 01/24/2019
Title Assistant Field Manager Lands & Minerals		
Office CARLSBAD		

Application approval does not warrant or certify that the applicant holds legal or equitable title to those rights in the subject lease which would entitle the applicant to conduct operations thereon.

Conditions of approval, if any, are attached.

Title 18 U.S.C. Section 1001 and Title 43 U.S.C. Section 1212, make it a crime for any person knowingly and willfully to make to any department or agency of the United States any false, fictitious or fraudulent statements or representations as to any matter within its jurisdiction.

GCP Rec 1/25/19

K 2/04/19

APPROVED WITH CONDITIONS

INSTRUCTIONS

GENERAL: This form is designed for submitting proposals to perform certain well operations, as indicated on Federal and Indian lands and leases for action by appropriate Federal agencies, pursuant to applicable Federal laws and regulations. Any necessary special instructions concerning the use of this form and the number of copies to be submitted, particularly with regard to local, area, or regional procedures and practices, either are shown below or will be issued by, or may be obtained from local Federal offices.

ITEM I: If the proposal is to redrill to the same reservoir at a different subsurface location or to a new reservoir, use this form with appropriate notations. Consult applicable Federal regulations concerning subsequent work proposals or reports on the well.

ITEM 4: Locations on Federal or Indian land should be described in accordance with Federal requirements. Consult local Federal offices for specific instructions.

ITEM 14: Needed only when location of well cannot readily be found by road from the land or lease description. A plat, or plats, separate or on the reverse side, showing the roads to, and the surveyed location of, the well, and any other required information, should be furnished when required by Federal agency offices.

ITEMS 15 AND 18: If well is to be, or has been directionally drilled, give distances for subsurface location of hole in any present or objective productive zone.

ITEM 22: Consult applicable Federal regulations, or appropriate officials, concerning approval of the proposal before operations are started.

ITEM 24: If the proposal will involve hydraulic fracturing operations, you must comply with 43 CFR 3162.3-3, including providing information about the protection of usable water. Operators should provide the best available information about all formations containing water and their depths. This information could include data and interpretation of resistivity logs run on nearby wells. Information may also be obtained from state or tribal regulatory agencies and from local BLM offices.

NOTICES

The Privacy Act of 1974 and regulation in 43 CFR 2.48(d) provide that you be furnished the following information in connection with information required by this application.

AUTHORITY: 30 U.S.C. 181 et seq., 25 U.S.C. 396; 43 CFR 3160

PRINCIPAL PURPOSES: The information will be used to: (1) process and evaluate your application for a permit to drill a new oil, gas, or service well or to reenter a plugged and abandoned well; and (2) document, for administrative use, information for the management, disposal and use of National Resource Lands and resources including (a) analyzing your proposal to discover and extract the Federal or Indian resources encountered; (b) reviewing procedures and equipment and the projected impact on the land involved; and (c) evaluating the effects of the proposed operation on the surface and subsurface water and other environmental impacts.

ROUTINE USE: Information from the record and/or the record will be transferred to appropriate Federal, State, and local or foreign agencies, when relevant to civil, criminal or regulatory investigations or prosecution, in connection with congressional inquiries and for regulatory responsibilities.

EFFECT OF NOT PROVIDING INFORMATION: Filing of this application and disclosure of the information is mandatory only if you elect to initiate a drilling or reentry operation on an oil and gas lease.

The Paperwork Reduction Act of 1995 requires us to inform you that:

The BLM connects this information to an evaluation of the technical, safety, and environmental factors involved with drilling for oil and/or gas on Federal and Indian oil and gas leases. This information will be used to analyze and approve applications. Response to this request is mandatory only if the operator elects to initiate drilling or reentry operations on an oil and gas lease. The BLM would like you to know that you do not have to respond to this or any other Federal agency-sponsored information collection unless it displays a currently valid OMB control number.

BURDEN HOURS STATEMENT: Public reporting burden for this form is estimated to average 8 hours per response, including the time for reviewing instructions, gathering and maintaining data, and completing and reviewing the form. Direct comments regarding the burden estimate or any other aspect of this form to U.S. Department of the Interior, Bureau of Land Management (1004-0137), Bureau Information Connection Clearance Officer (WO-630), 1849 C Street, N.W., Mail Stop 401 LS, Washington, D.C. 20240.

Additional Operator Remarks

Location of Well

1. SHL: NENE / 10 FNL / 1235 FEL / TWSP: 25S / RANGE: 32E / SECTION: 15 / LAT: 32.137734 / LONG: -103.658211 (TVD: 0 feet, MD: 0 feet)
PPP: NENE / 330 FNL / 330 FEL / TWSP: 25S / RANGE: 32E / SECTION: 15 / LAT: 32.136862 / LONG: -103.655293 (TVD: 10623 feet, MD: 10623 feet)
BHL: SESE / 100 FSL / 330 FEL / TWSP: 25S / RANGE: 32E / SECTION: 22 / LAT: 32.108958 / LONG: -103.655336 (TVD: 10623 feet, MD: 21194 feet)

BLM Point of Contact

Name: Tenille Ortiz

Title: Legal Instruments Examiner

Phone: 5752342224

Email: tortiz@blm.gov

Review and Appeal Rights

A person contesting a decision shall request a State Director review. This request must be filed within 20 working days of receipt of the Notice with the appropriate State Director (see 43 CFR 3165.3). The State Director review decision may be appealed to the Interior Board of Land Appeals, 801 North Quincy Street, Suite 300, Arlington, VA 22203 (see 43 CFR 3165.4). Contact the above listed Bureau of Land Management office for further information.

PECOS DISTRICT DRILLING CONDITIONS OF APPROVAL

OPERATOR'S NAME:	CHEVRON USA INCORPORATED
LEASE NO.:	NMLC0062300
WELL NAME & NO.:	CO YETI 15 22 FED COM 0055H
SURFACE HOLE FOOTAGE:	10'/N & 1235'/E
BOTTOM HOLE FOOTAGE:	100'/S & 330'/E
LOCATION:	SECTION 15, T25S, R32E, NMPM
COUNTY:	LEA, NEW MEXICO



H2S	<input checked="" type="radio"/> Yes	<input type="radio"/> No	
Potash	<input checked="" type="radio"/> None	<input type="radio"/> Secretary	<input type="radio"/> R-111-P
Cave/Karst Potential	<input checked="" type="radio"/> Low	<input type="radio"/> Medium	<input type="radio"/> High
Variance	<input type="radio"/> None	<input checked="" type="radio"/> Flex Hose	<input type="radio"/> Other
Wellhead	<input type="radio"/> Conventional	<input checked="" type="radio"/> Multibowl	<input type="radio"/> Both
Other	<input type="checkbox"/> 4 String Area	<input type="checkbox"/> Capitan Reef	<input type="checkbox"/> WIPP

A. Hydrogen Sulfide

A Hydrogen Sulfide (H2S) Drilling Plan shall be activated 500 feet prior to drilling into the **Delaware** formation. As a result, the Hydrogen Sulfide area must meet Onshore Order 6 requirements, which includes equipment and personnel/public protection items. If Hydrogen Sulfide is encountered, please provide measured values and formations to the BLM.

B. CASING

1. The **13-3/8** inch surface casing shall be set at approximately **875** feet (a minimum of 25 feet into the Rustler Anhydrite and above the salt) and cemented to the surface.
 - a. If cement does not circulate to the surface, the appropriate BLM office shall be notified and a temperature survey utilizing an electronic type temperature survey with surface log readout will be used or a cement bond log shall be run to verify the top of the cement. Temperature survey will be run a minimum of six hours after pumping cement and ideally between 8-10 hours after completing the cement job.
 - b. Wait on cement (WOC) time for a primary cement job will be a minimum of **8 hours** or 500 pounds compressive strength, whichever is greater. (This is to include the lead cement)
 - c. Wait on cement (WOC) time for a remedial job will be a minimum of 4 hours after bringing cement to surface or 500 pounds compressive strength, whichever is greater.

- d. If cement falls back, remedial cementing will be done prior to drilling out that string.
2. The minimum required fill of cement behind the **9-5/8** inch intermediate casing is: Wait on cement (WOC) time for a primary cement job is to include the lead cement slurry due to cave/karst or potash.

Operator has proposed a DV tool, the depth may be adjusted as long as the cement is changed proportionally. The DV tool may be cancelled if cement circulates to surface on the first stage.

- a. First stage to DV tool: Cement to circulate. If cement does not circulate off the DV tool, contact the appropriate BLM office before proceeding with second stage cement job.
 - b. Second stage above DV tool: Cement to surface. If cement does not circulate, contact the appropriate BLM office.
3. The minimum required fill of cement behind the **5-1/2** inch production casing is:
 - Cement should tie-back at least 200 feet into previous casing string. Operator shall provide method of verification. **Additional cement maybe required. Excess calculates to 7%.**

C. PRESSURE CONTROL

1. Variance approved to use flex line from BOP to choke manifold. Manufacturer's specification to be readily available. No external damage to flex line. Flex line to be installed as straight as possible (no hard bends).
2. Minimum working pressure of the blowout preventer (BOP) and related equipment (BOPE) required for drilling below the surface casing shoe shall be **5000 (5M)** psi.

GENERAL REQUIREMENTS

The BLM is to be notified in advance for a representative to witness:

- a. Spudding well (minimum of 24 hours)
- b. Setting and/or Cementing of all casing strings (minimum of 4 hours)
- c. BOPE tests (minimum of 4 hours)

☒ Chaves and Roosevelt Counties
Call the Roswell Field Office, 2909 West Second St., Roswell NM 88201.
During office hours call (575) 627-0272.
After office hours call (575)

☒ Eddy County
Call the Carlsbad Field Office, 620 East Greene St., Carlsbad, NM 88220,
(575) 361-2822

☒ Lea County
Call the Hobbs Field Station, 414 West Taylor, Hobbs NM 88240, (575)
393-3612

1. Unless the production casing has been run and cemented or the well has been properly plugged, the drilling rig shall not be removed from over the hole without prior approval.
 - a. **Operator has proposed to drill multiple wells utilizing a skid/walking rig. Operator shall secure the wellbore on the current well, after installing and testing the wellhead, by installing a blind flange of like pressure rating to the wellhead and a pressure gauge that can be monitored while drilling is performed on the other well(s).**
 - b. **Operator proposes to set surface casing with Spudder Rig**
 - **Notify the BLM when moving in and removing the Spudder Rig.**
 - **Notify the BLM when moving in the 2nd Rig. Rig to be moved in within 90 days of notification that Spudder Rig has left the location.**
 - **BOP/BOPE test to be conducted per Onshore Oil and Gas Order No. 2 as soon as 2nd Rig is rigged up on well.**
2. Floor controls are required for 3M or Greater systems. These controls will be on the rig floor, unobstructed, readily accessible to the driller and will be operational at all times during drilling and/or completion activities. Rig floor is defined as the area immediately around the rotary table; the area immediately above the substructure on which the draw works are located, this does not include the dog house or stairway area.
3. The record of the drilling rate along with the GR/N well log (one log per well pad is acceptable) run from TD to surface (horizontal well – vertical portion of hole) shall

be submitted to the BLM office as well as all other logs run on the borehole 30 days from completion. If available, a digital copy of the logs is to be submitted in addition to the paper copies. The Rustler top and top and bottom of Salt are to be recorded on the Completion Report.

A. CASING

1. Changes to the approved APD casing program need prior approval if the items substituted are of lesser grade or different casing size or are Non-API. The Operator can exchange the components of the proposal with that of superior strength (i.e. changing from J-55 to N-80, or from 36# to 40#). Changes to the approved cement program need prior approval if the altered cement plan has less volume or strength or if the changes are substantial (i.e. Multistage tool, ECP, etc.). The initial wellhead installed on the well will remain on the well with spools used as needed.
2. Wait on cement (WOC) for Potash Areas: After cementing but before commencing any tests, the casing string shall stand cemented under pressure until both of the following conditions have been met: 1) cement reaches a minimum compressive strength of 500 psi for all cement blends, 2) until cement has been in place at least 24 hours. WOC time will be recorded in the driller's log. The casing integrity test can be done (prior to the cement setting up) immediately after bumping the plug.
3. Wait on cement (WOC) for Water Basin: After cementing but before commencing any tests, the casing string shall stand cemented under pressure until both of the following conditions have been met: 1) cement reaches a minimum compressive strength of 500 psi at the shoe, 2) until cement has been in place at least 8 hours. WOC time will be recorded in the driller's log. See individual casing strings for details regarding lead cement slurry requirements. The casing integrity test can be done (prior to the cement setting up) immediately after bumping the plug.
4. Provide compressive strengths including hours to reach required 500 pounds compressive strength prior to cementing each casing string. Have well specific cement details onsite prior to pumping the cement for each casing string.
5. No pea gravel permitted for remedial or fall back remedial without prior authorization from the BLM engineer.
6. On that portion of any well approved for a 5M BOPE system or greater, a pressure integrity test of each casing shoe shall be performed. Formation at the shoe shall be tested to a minimum of the mud weight equivalent anticipated to control the formation pressure to the next casing depth or at total depth of the well. This test shall be performed before drilling more than 20 feet of new hole.
7. If hardband drill pipe is rotated inside casing, returns will be monitored for metal. If metal is found in samples, drill pipe will be pulled and rubber protectors which have a

larger diameter than the tool joints of the drill pipe will be installed prior to continuing drilling operations.

8. Whenever a casing string is cemented in the R-111-P potash area, the NMOCD requirements shall be followed.

B. PRESSURE CONTROL

1. All blowout preventer (BOP) and related equipment (BOPE) shall comply with well control requirements as described in Onshore Oil and Gas Order No. 2 and API RP 53 Sec. 17.
2. If a variance is approved for a flexible hose to be installed from the BOP to the choke manifold, the following requirements apply: The flex line must meet the requirements of API 16C. Check condition of flexible line from BOP to choke manifold, replace if exterior is damaged or if line fails test. Line to be as straight as possible with no hard bends and is to be anchored according to Manufacturer's requirements. The flexible hose can be exchanged with a hose of equal size and equal or greater pressure rating. Anchor requirements, specification sheet and hydrostatic pressure test certification matching the hose in service, to be onsite for review. These documents shall be posted in the company man's trailer and on the rig floor.
3. 5M or higher system requires an HCR valve, remote kill line and annular to match. The remote kill line is to be installed prior to testing the system and tested to stack pressure.
4. If the operator has proposed a multi-bowl wellhead assembly in the APD. The following requirements must be met:
 - a. Wellhead shall be installed by manufacturer's representatives, submit documentation with subsequent sundry.
 - b. If the welding is performed by a third party, the manufacturer's representative shall monitor the temperature to verify that it does not exceed the maximum temperature of the seal.
 - c. Manufacturer representative shall install the test plug for the initial BOP test.
 - d. If the cement does not circulate and one inch operations would have been possible with a standard wellhead, the well head shall be cut off, cementing operations performed and another wellhead installed.
 - e. Whenever any seal subject to test pressure is broken, all the tests in OOGO2.III.A.2.i must be followed.

5. The appropriate BLM office shall be notified a minimum of 4 hours in advance for a representative to witness the tests.
- a. In a water basin, for all casing strings utilizing slips, these are to be set as soon as the crew and rig are ready and any fallback cement remediation has been done. The casing cut-off and BOP installation can be initiated four hours after installing the slips, which will be approximately six hours after bumping the plug. For those casing strings not using slips, the minimum wait time before cut-off is eight hours after bumping the plug. BOP/BOPE testing can begin after cut-off or once cement reaches 500 psi compressive strength (including lead when specified), whichever is greater. However, if the float does not hold, cut-off cannot be initiated until cement reaches 500 psi compressive strength (including lead when specified).
 - b. In potash areas, for all casing strings utilizing slips, these are to be set as soon as the crew and rig are ready and any fallback cement remediation has been done. For all casing strings, casing cut-off and BOP installation can be initiated at twelve hours after bumping the plug. However, **no tests** shall commence until the cement has had a minimum of 24 hours setup time, except the casing pressure test can be initiated immediately after bumping the plug (only applies to single stage cement jobs).
 - c. The tests shall be done by an independent service company utilizing a test plug. The results of the test shall be reported to the appropriate BLM office.
 - d. The test shall be run on a 5000 psi chart for a 2-3M BOP/BOP, on a 10000 psi chart for a 5M BOP/BOPE and on a 15000 psi chart for a 10M BOP/BOPE. If a linear chart is used, it shall be a one hour chart. A circular chart shall have a maximum 2 hour clock. If a twelve hour or twenty-four hour chart is used, tester shall make a notation that it is run with a two hour clock.
 - e. All tests are required to be recorded on a calibrated test chart. A copy of the BOP/BOPE test chart and a copy of independent service company test will be submitted to the appropriate BLM office.
 - f. The BOP/BOPE test shall include a low pressure test from 250 to 300 psi. The test will be held for a minimum of 10 minutes. This test shall be performed prior to the test at full stack pressure.
 - g. BOP/BOPE must be tested by an independent service company within 500 feet of the top of the Wolfcamp formation if the time between the setting of the intermediate casing and reaching this depth exceeds 20 days. This test does not exclude the test prior to drilling out the casing shoe as per Onshore Order No. 2.

C. DRILLING MUD

Mud system monitoring equipment, with derrick floor indicators and visual and audio alarms, shall be operating before drilling into the Wolfcamp formation, and shall be used until production casing is run and cemented.

D. WASTE MATERIAL AND FLUIDS

All waste (i.e. drilling fluids, trash, salts, chemicals, sewage, gray water, etc.) created as a result of drilling operations and completion operations shall be safely contained and disposed of properly at a waste disposal facility. No waste material or fluid shall be disposed of on the well location or surrounding area.

Porto-johns and trash containers will be on-location during fracturing operations or any other crew-intensive operations.

Waste Minimization Plan (WMP)

In the interest of resource development, submission of additional well gas capture development plan information is deferred but may be required by the BLM Authorized Officer at a later date.

ZS 010919

**PECOS DISTRICT
SURFACE USE
CONDITIONS OF APPROVAL**

OPERATOR'S NAME:	CHEVRON USA INCORPORATED
LEASE NO.:	NMLC0062300
WELL NAME & NO.:	CO YETI 15 22 FED COM 0055H
SURFACE HOLE FOOTAGE:	10'/N & 1235'/E
BOTTOM HOLE FOOTAGE:	100'/S & 330'/E
LOCATION:	SECTION 15, T25S, R32E, NMPM
COUNTY:	LEA

TABLE OF CONTENTS

Standard Conditions of Approval (COA) apply to this APD. If any deviations to these standards exist or special COAs are required, the section with the deviation or requirement will be checked below.

- ☐ **General Provisions**
- ☐ **Permit Expiration**
- ☐ **Archaeology, Paleontology, and Historical Sites**
- ☐ **Noxious Weeds**
- ☒ **Special Requirements**
 - Lesser Prairie-Chicken Timing Stipulations
 - Ground-level Abandoned Well Marker
 - Hydrology
 - Cultural
- ☐ **Construction**
 - Notification
 - Topsoil
 - Closed Loop System
 - Federal Mineral Material Pits
 - Well Pads
 - Roads
- ☐ **Road Section Diagram**
- ☒ **Production (Post Drilling)**
 - Well Structures & Facilities
 - Pipelines
 - Electric Lines
- ☐ **Interim Reclamation**
- ☐ **Final Abandonment & Reclamation**

I. GENERAL PROVISIONS

The approval of the Application For Permit To Drill (APD) is in compliance with all applicable laws and regulations: 43 Code of Federal Regulations 3160, the lease terms, Onshore Oil and Gas Orders, Notices To Lessees, New Mexico Oil Conservation Division (NMOCD) Rules, National Historical Preservation Act As Amended, and instructions and orders of the Authorized Officer. Any request for a variance shall be submitted to the Authorized Officer on Form 3160-5, Sundry Notices and Report on Wells.

II. PERMIT EXPIRATION

If the permit terminates prior to drilling and drilling cannot be commenced within 60 days after expiration, an operator is required to submit Form 3160-5, Sundry Notices and Reports on Wells, requesting surface reclamation requirements for any surface disturbance. However, if the operator will be able to initiate drilling within 60 days after the expiration of the permit, the operator must have set the conductor pipe in order to allow for an extension of 60 days beyond the expiration date of the APD. (Filing of a Sundry Notice is required for this 60 day extension.)

III. ARCHAEOLOGICAL, PALEONTOLOGY & HISTORICAL SITES

Any cultural and/or paleontological resource discovered by the operator or by any person working on the operator's behalf shall immediately report such findings to the Authorized Officer. The operator is fully accountable for the actions of their contractors and subcontractors. The operator shall suspend all operations in the immediate area of such discovery until written authorization to proceed is issued by the Authorized Officer. An evaluation of the discovery shall be made by the Authorized Officer to determine the appropriate actions that shall be required to prevent the loss of significant cultural or scientific values of the discovery. The operator shall be held responsible for the cost of the proper mitigation measures that the Authorized Officer assesses after consultation with the operator on the evaluation and decisions of the discovery. Any unauthorized collection or disturbance of cultural or paleontological resources may result in a shutdown order by the Authorized Officer.

IV. NOXIOUS WEEDS

The operator shall be held responsible if noxious weeds become established within the areas of operations. Weed control shall be required on the disturbed land where noxious weeds exist, which includes the roads, pads, associated pipeline corridor, and adjacent land affected by the establishment of weeds due to this action. The operator shall consult with the Authorized Officer for

acceptable weed control methods, which include following EPA and BLM requirements and policies.

V. SPECIAL REQUIREMENT(S)

Hydrology:

The entire well pad will be bermed to prevent oil, salt, and other chemical contaminants from leaving the well pad. The compacted berm shall be constructed at a minimum of 12 inches with impermeable mineral material (e.g. caliche). Topsoil shall not be used to construct the berm. No water flow from the uphill side(s) of the pad shall be allowed to enter the well pad. The integrity of the berm shall be maintained around the surfaced pad throughout the life of the well and around the downsized pad after interim reclamation has been completed. Any water erosion that may occur due to the construction of the well pad during the life of the well will be quickly corrected and proper measures will be taken to prevent future erosion. Stockpiling of topsoil is required. The top soil shall be stockpiled in an appropriate location to prevent loss of soil due to water or wind erosion and not used for berming or erosion control. If fluid collects within the bermed area, the fluid must be vacuumed into a safe container and disposed of properly at a state approved facility.

Tank battery locations will be lined and bermed. A 20 mil permanent liner will be installed with a 4 oz. felt backing to prevent tears or punctures. Tank battery berms must be large enough to contain 1 ½ times the content of the largest tank or 24 hour production, whichever is greater. Automatic shut off, check valves, or similar systems will be installed for tanks to minimize the effects of catastrophic line failures used in production or drilling.

A leak detection plan will be submitted to the BLM Carlsbad Field Office for approval prior to pipeline installation. The method could incorporate gauges to detect pressure drops, situating valves and lines so they can be visually inspected periodically or installing electronic sensors to alarm when a leak is present. The leak detection plan will incorporate an automatic shut off system that will be installed for proposed pipelines to minimize the effects of an undesirable event.

Electric Lines: Any water erosion that may occur due to the construction of overhead electric line and during the life of the power line will be quickly corrected and proper measures will be taken to prevent future erosion.

Timing Limitation Stipulation / Condition of Approval for lesser prairie-chicken:

Oil and gas activities including 3-D geophysical exploration, and drilling will not be allowed in lesser prairie-chicken habitat during the period from March 1st through June 15th annually. During that period, other activities that produce noise or involve human activity, such as the maintenance of oil and gas facilities,

pipeline, road, and well pad construction, will be allowed except between 3:00 am and 9:00 am. The 3:00 am to 9:00 am restriction will not apply to normal, around-the-clock operations, such as venting, flaring, or pumping, which do not require a human presence during this period. Additionally, no new drilling will be allowed within up to 200 meters of leks known at the time of permitting. Normal vehicle use on existing roads will not be restricted. Exhaust noise from pump jack engines must be muffled or otherwise controlled so as not to exceed 75 db measured at 30 feet from the source of the noise.

Ground-level Abandoned Well Marker to avoid raptor perching: Upon the plugging and subsequent abandonment of the well, the well marker will be installed at ground level on a plate containing the pertinent information for the plugged well. For more installation details, contact the Carlsbad Field Office at 575-234-5972.

This authorization is subject to your Certificate of Participation and/or Certificate of Inclusion under the New Mexico Candidate Conservation Agreement. Because it involves surface disturbing activities covered under your Certificate, your Habitat Conservation Fund Account with the Center of Excellence for Hazardous Materials Management (CEHMM) will be debited according to Exhibit B Part 2 of the Certificate of Participation.

VI. CONSTRUCTION

A. NOTIFICATION

The BLM shall administer compliance and monitor construction of the access road and well pad. Notify the Carlsbad Field Office at (575) 234-5909 at least 3 working days prior to commencing construction of the access road and/or well pad.

When construction operations are being conducted on this well, the operator shall have the approved APD and Conditions of Approval (COA) on the well site and they shall be made available upon request by the Authorized Officer.

B. TOPSOIL

The operator shall strip the top portion of the soil (root zone) from the entire well pad area and stockpile the topsoil along the edge of the well pad as depicted in the APD. The root zone is typically six (6) inches in depth. All the stockpiled topsoil will be redistributed over the interim reclamation areas. Topsoil shall not be used for berming the pad or facilities. For final reclamation, the topsoil shall be spread over the entire pad area for seeding preparation.

Other subsoil (below six inches) stockpiles must be completely segregated from the topsoil stockpile. Large rocks or subsoil clods (not evident in the surrounding terrain) must be buried within the approved area for interim and final reclamation.

C. CLOSED LOOP SYSTEM

Tanks are required for drilling operations: No Pits.

The operator shall properly dispose of drilling contents at an authorized disposal site.

D. FEDERAL MINERAL MATERIALS PIT

Payment shall be made to the BLM prior to removal of any federal mineral materials. Call the Carlsbad Field Office at (575) 234-5972.

E. WELL PAD SURFACING

Surfacing of the well pad is not required.

If the operator elects to surface the well pad, the surfacing material may be required to be removed at the time of reclamation. The well pad shall be constructed in a manner which creates the smallest possible surface disturbance, consistent with safety and operational needs.

F. EXCLOSURE FENCING (CELLARS & PITS)

Exclosure Fencing

The operator will install and maintain exclosure fencing for all open well cellars to prevent access to public, livestock, and large forms of wildlife before and after drilling operations until the pit is free of fluids and the operator initiates backfilling. (For examples of exclosure fencing design, refer to BLM's Oil and Gas Gold Book, Exclosure Fence Illustrations, Figure 1, Page 18.)

G. ON LEASE ACCESS ROADS

Road Width

The access road shall have a driving surface that creates the smallest possible surface disturbance and does not exceed fourteen (14) feet in width. The maximum width of surface disturbance, when constructing the access road, shall not exceed twenty-five (25) feet.

Surfacing

Surfacing material is not required on the new access road driving surface. If the operator elects to surface the new access road or pad, the surfacing material may be required to be removed at the time of reclamation.

Where possible, no improvements should be made on the unsurfaced access road other than to remove vegetation as necessary, road irregularities, safety issues, or to fill low areas that may sustain standing water.

The Authorized Officer reserves the right to require surfacing of any portion of the access road at any time deemed necessary. Surfacing may be required in the event the road deteriorates, erodes, road traffic increases, or it is determined to be beneficial for future field development. The surfacing depth and type of material will be determined at the time of notification.

Crowning

Crowning shall be done on the access road driving surface. The road crown shall have a grade of approximately 2% (i.e., a 1" crown on a 14' wide road). The road shall conform to Figure 1; cross section and plans for typical road construction.

Ditching

Ditching shall be required on both sides of the road.

Turnouts


Vehicle turnouts shall be constructed on the road. Turnouts shall be intervisible with interval spacing distance less than 1000 feet. Turnouts shall conform to Figure 1; cross section and plans for typical road construction.

Drainage

Drainage control systems shall be constructed on the entire length of road (e.g. ditches, sidehill outsloping and insloping, lead-off ditches, culvert installation, and low water crossings).

A typical lead-off ditch has a minimum depth of 1 foot below and a berm of 6 inches above natural ground level. The berm shall be on the down-slope side of the lead-off ditch.

Cross Section of a Typical Lead-off Ditch

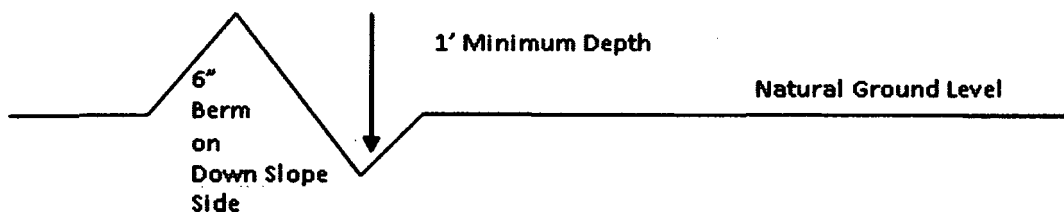

All lead-off ditches shall be graded to drain water with a 1 percent minimum to 3 percent maximum ditch slope. The spacing interval are variable for lead-off ditches and shall be determined according to the formula for spacing intervals of

lead-off ditches, but may be amended depending upon existing soil types and centerline road slope (in %);

Formula for Spacing Interval of Lead-off Ditches

Example - On a 4% road slope that is 400 feet long, the water flow shall drain water into a lead-off ditch. Spacing interval shall be determined by the following formula:

$$400 \text{ foot road with } 4\% \text{ road slope: } \frac{400'}{4\%} + 100' = 200' \text{ lead-off ditch interval}$$

Cattle guards

An appropriately sized cattle guard sufficient to carry out the project shall be installed and maintained at fence/road crossings. Any existing cattle guards on the access road route shall be repaired or replaced if they are damaged or have deteriorated beyond practical use. The operator shall be responsible for the condition of the existing cattle guards that are in place and are utilized during lease operations.

Fence Requirement

Where entry is granted across a fence line, the fence shall be braced and tied off on both sides of the passageway prior to cutting. The operator shall notify the private surface landowner or the grazing allotment holder prior to crossing any fences.

Public Access

Public access on this road shall not be restricted by the operator without specific written approval granted by the Authorized Officer.

Construction Steps

1. Salvage topsoil
2. Construct road

3. Redistribute topsoil
4. Revegetate slopes

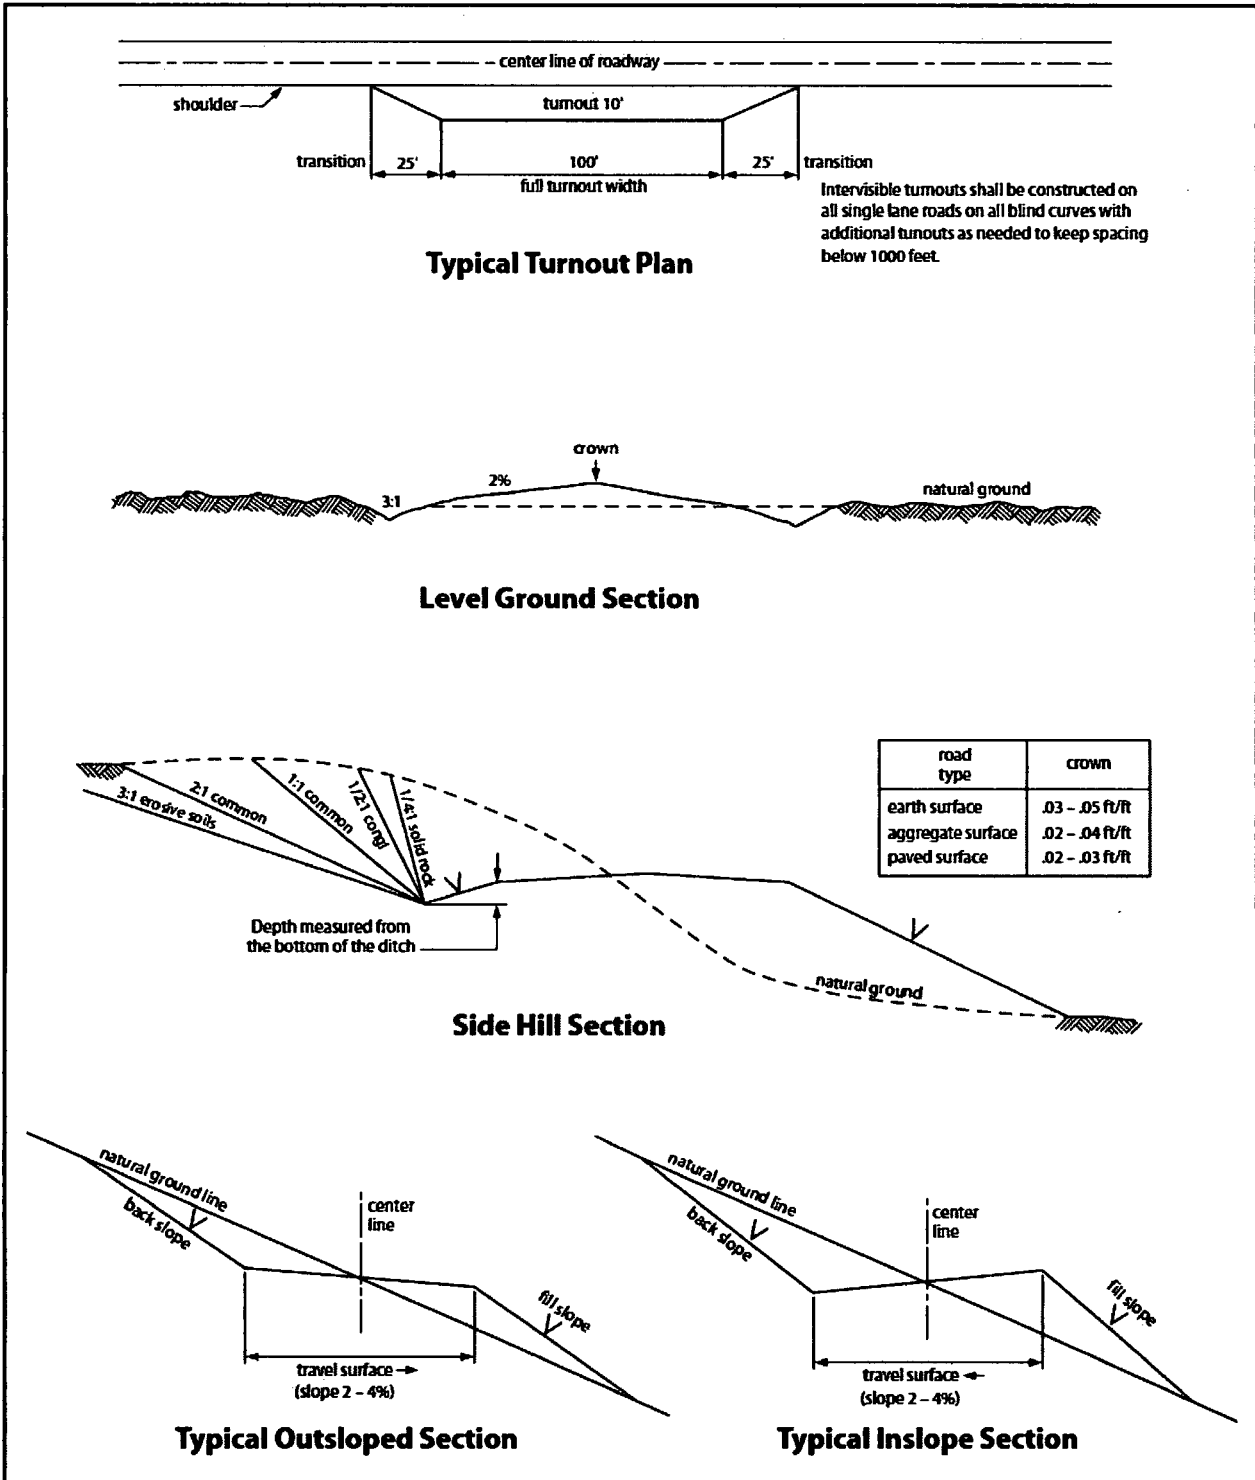


Figure 1. Cross-sections and plans for typical road sections representative of BLM resource or FS local and higher-class roads.

VII. PRODUCTION (POST DRILLING)

A. WELL STRUCTURES & FACILITIES

Placement of Production Facilities

Production facilities should be placed on the well pad to allow for maximum interim recontouring and revegetation of the well location.

Exclosure Netting (Open-top Tanks)

Immediately following active drilling or completion operations, the operator will take actions necessary to prevent wildlife and livestock access, including avian wildlife, to all open-topped tanks that contain or have the potential to contain salinity sufficient to cause harm to wildlife or livestock, hydrocarbons, or Resource Conservation and Recovery Act of 1976-exempt hazardous substances. At a minimum, the operator will net, screen, or cover open-topped tanks to exclude wildlife and livestock and prevent mortality. If the operator uses netting, the operator will cover and secure the open portion of the tank to prevent wildlife entry. The operator will net, screen, or cover the tanks until the operator removes the tanks from the location or the tanks no longer contain substances that could be harmful to wildlife or livestock. Use a maximum netting mesh size of 1 ½ inches. The netting must not be in contact with fluids and must not have holes or gaps.

Chemical and Fuel Secondary Containment and Exclosure Screening

The operator will prevent all hazardous, poisonous, flammable, and toxic substances from coming into contact with soil and water. At a minimum, the operator will install and maintain an impervious secondary containment system for any tank or barrel containing hazardous, poisonous, flammable, or toxic substances sufficient to contain the contents of the tank or barrel and any drips, leaks, and anticipated precipitation. The operator will dispose of fluids within the containment system that do not meet applicable state or U. S. Environmental Protection Agency livestock water standards in accordance with state law; the operator must not drain the fluids to the soil or ground. The operator will design, construct, and maintain all secondary containment systems to prevent wildlife and livestock exposure to harmful substances. At a minimum, the operator will install effective wildlife and livestock exclosure systems such as fencing, netting, expanded metal mesh, lids, and grate covers. Use a maximum netting mesh size of 1 ½ inches.

Open-Vent Exhaust Stack Exclosures

The operator will construct, modify, equip, and maintain all open-vent exhaust stacks on production equipment to prevent birds and bats from entering, and to discourage perching, roosting, and nesting. (*Recommended exclosure structures on open-vent exhaust stacks are in the shape of a cone.*) Production

equipment includes, but may not be limited to, tanks, heater-treaters, separators, dehydrators, flare stacks, in-line units, and compressor mufflers.

Containment Structures

Proposed production facilities such as storage tanks and other vessels will have a secondary containment structure that is constructed to hold the capacity of 1.5 times the largest tank, plus freeboard to account for precipitation, unless more stringent protective requirements are deemed necessary.

Painting Requirement

All above-ground structures including meter housing that are not subject to safety requirements shall be painted a flat non-reflective paint color, **Shale Green** from the BLM Standard Environmental Color Chart (CC-001: June 2008).

B. PIPELINES

STANDARD STIPULATIONS FOR SURFACE INSTALLED PIPELINES

A copy of the application (Grant, Sundry Notice, APD) and attachments, including stipulations, survey plat and/or map, will be on location during construction. BLM personnel may request to you a copy of your permit during construction to ensure compliance with all stipulations.

Holder agrees to comply with the following stipulations to the satisfaction of the Authorized Officer:

1. The holder shall indemnify the United States against any liability for damage to life or property arising from the occupancy or use of public lands under this grant.
2. The holder shall comply with all applicable Federal laws and regulations existing or hereafter enacted or promulgated. In any event, the holder shall comply with the Toxic Substances Control Act of 1976 as amended, 15 USC 2601 et seq. (1982) with regards to any toxic substances that are used, generated by or stored on the right-of-way or on facilities authorized under this right-of-way grant. (See 40 CFR, Part 702-799 and especially, provisions on polychlorinated biphenyls, 40 CFR 761.1-761.193.) Additionally, any release of toxic substances (leaks, spills, etc.) in excess of the reportable quantity established by 40 CFR, Part 117 shall be reported as required by the Comprehensive Environmental Response, Compensation, and Liability Act, section 102b. A copy of any report required or requested by any Federal agency or State government as a result of a reportable release or spill of any toxic substances shall be furnished to the authorized officer concurrent with the filing of the reports to the involved Federal agency or State government.
3. The holder agrees to indemnify the United States against any liability arising

from the release of any hazardous substance or hazardous waste (as these terms are defined in the Comprehensive Environmental Response, Compensation and Liability Act of 1980, 42 U.S.C. 9601, et seq. or the Resource Conservation and Recovery Act, 42 U.S.C. 6901, et seq.) on the Right-of-Way (unless the release or threatened release is wholly unrelated to activity of the Right-of-Way holder's activity on the Right-of-Way), or resulting from the activity of the Right-of-Way holder on the Right-of-Way. This agreement applies without regard to whether a release is caused by the holder, its agent, or unrelated third parties.

4. The holder shall be liable for damage or injury to the United States to the extent provided by 43 CFR Sec. 2883.1-4. The holder shall be held to a standard of strict liability for damage or injury to the United States resulting from pipe rupture, fire, or spills caused or substantially aggravated by any of the following within the right-of-way or permit area:

- a. Activities of the holder including, but not limited to construction, operation, maintenance, and termination of the facility.
- b. Activities of other parties including, but not limited to:
 - (1) Land clearing.
 - (2) Earth-disturbing and earth-moving work.
 - (3) Blasting.
 - (4) Vandalism and sabotage.
- c. Acts of God.

The maximum limitation for such strict liability damages shall not exceed one million dollars (\$1,000,000) for any one event, and any liability in excess of such amount shall be determined by the ordinary rules of negligence of the jurisdiction in which the damage or injury occurred.

This section shall not impose strict liability for damage or injury resulting primarily from an act of war or from the negligent acts or omissions of the United States.

5. If, during any phase of the construction, operation, maintenance, or termination of the pipeline, any oil, salt water, or other pollutant should be discharged from the pipeline system, impacting Federal lands, the control and total removal, disposal, and cleaning up of such oil, salt water, or other pollutant, wherever found, shall be the responsibility of the holder, regardless of fault. Upon failure of the holder to control, dispose of, or clean up such discharge on or affecting Federal lands, or to repair all damages resulting therefrom, on the Federal lands, the Authorized Officer may take such measures as he deems necessary to control and clean up the discharge and restore the area, including, where appropriate, the aquatic environment and fish and wildlife habitats, at the full expense of the holder. Such action by the Authorized Officer shall not relieve the holder of any responsibility as provided herein.

6. All construction and maintenance activity will be confined to the authorized right-of-way width of 20 feet. If the pipeline route follows an existing road or buried pipeline right-of-way, the surface pipeline must be installed no farther than 10 feet from the edge of the road or buried pipeline right-of-way. If existing surface pipelines prevent this distance, the proposed surface pipeline must be installed immediately adjacent to the outer surface pipeline. All construction and maintenance activity will be confined to existing roads or right-of-ways.

7. No blading or clearing of any vegetation will be allowed unless approved in writing by the Authorized Officer.

8. The holder shall install the pipeline on the surface in such a manner that will minimize suspension of the pipeline across low areas in the terrain. In hummocky or dune areas, the pipeline will be "snaked" around hummocks and dunes rather than suspended across these features.

9. The pipeline shall be buried with a minimum of 24 inches under all roads, "two-tracks," and trails. Burial of the pipe will continue for 20 feet on each side of each crossing. The condition of the road, upon completion of construction, shall be returned to at least its former state with no bumps or dips remaining in the road surface.

10. The holder shall minimize disturbance to existing fences and other improvements on public lands. The holder is required to promptly repair improvements to at least their former state. Functional use of these improvements will be maintained at all times. The holder will contact the owner of any improvements prior to disturbing them. When necessary to pass through a fence line, the fence shall be braced on both sides of the passageway prior to cutting of the fence. No permanent gates will be allowed unless approved by the Authorized Officer.

11. In those areas where erosion control structures are required to stabilize soil conditions, the holder will install such structures as are suitable for the specific soil conditions being encountered and which are in accordance with sound resource management practices.

12. Excluding the pipe, all above-ground structures not subject to safety requirement shall be painted by the holder to blend with the natural color of the landscape. The paint used shall be a color which simulates "Standard Environmental Colors" – **Shale Green**, Munsell Soil Color No. 5Y 4/2; designated by the Rocky Mountain Five State Interagency Committee.

13. The pipeline will be identified by signs at the point of origin and completion of the right-of-way and at all road crossings. At a minimum, signs will state the holder's name, BLM serial number, and the product being transported. Signs will

be maintained in a legible condition for the life of the pipeline.

14. The holder shall not use the pipeline route as a road for purposes other than routine maintenance as determined necessary by the Authorized Officer in consultation with the holder. The holder will take whatever steps are necessary to ensure that the pipeline route is not used as a roadway.

15. Any cultural and/or paleontological resource (historic or prehistoric site or object) discovered by the holder, or any person working on his behalf, on public or Federal land shall be immediately reported to the authorized officer. Holder shall suspend all operations in the immediate area of such discovery until written authorization to proceed is issued by the authorized officer. An evaluation of the discovery will be made by the authorized officer to determine appropriate cultural or scientific values. The holder will be responsible for the cost of evaluation and any decision as to proper mitigation measures will be made by the authorized officer after consulting with the holder.

16. The operator shall be held responsible if noxious weeds become established within the areas of operations. Weed control shall be required on the disturbed land where noxious weeds exist, which includes the roads, powerline corridor, and adjacent land affected by the establishment of weeds due to this action. The operator shall consult with the Authorized Officer for acceptable weed control methods, which include following EPA and BLM requirements and policies.

17. Surface pipelines must be less than or equal to 4 inches and a working pressure below 125 psi.

18. Special Stipulations:

- a. **Lesser Prairie-Chicken:** Oil and gas activities will not be allowed in lesser prairie-chicken habitat during the period from March 1st through June 15th annually. During that period, other activities that produce noise or involve human activity, such as the maintenance of oil and gas facilities and pipeline, road, and well pad construction, will be allowed except between 3:00 am and 9:00 am. The 3:00 am to 9:00 am restriction will not apply to normal, around-the-clock operations, such as venting, flaring, or pumping, which do not require a human presence during this period. Normal vehicle use on existing roads will not be restricted.
- b. A leak detection plan will be submitted to the BLM Carlsbad Field Office for approval prior to pipeline installation. The method could incorporate gauges to detect pressure drops, siting valves and lines so they can be visually inspected periodically or installing electronic sensors to alarm when a leak is present. The leak detection plan will incorporate an automatic shut off system that will be installed for proposed pipelines to minimize the effects of an undesirable event.

BURIED PIPELINE STIPULATIONS

A copy of the application (Grant, APD, or Sundry Notice) and attachments, including conditions of approval, survey plat and/or map, will be on location during construction. BLM personnel may request to you a copy of your permit during construction to ensure compliance with all stipulations.

Holder agrees to comply with the following stipulations to the satisfaction of the Authorized Officer:

1. The Holder shall indemnify the United States against any liability for damage to life or property arising from the occupancy or use of public lands under this grant.
2. The Holder shall comply with all applicable Federal laws and regulations existing or hereafter enacted or promulgated. In any event, the holder shall comply with the Toxic Substances Control Act of 1976 as amended, 15 USC 2601 et seq. (1982) with regards to any toxic substances that are used, generated by or stored on the right-of-way or on facilities authorized under this right-of-way grant. (See 40 CFR Part 702-799 and especially, provisions on polychlorinated biphenyls, 40 CFR 761.1-761.193.) Additionally, any release of toxic substances (leaks, spills, etc.) in excess of the reportable quantity established by 40 CFR Part 117 shall be reported as required by the Comprehensive Environmental Response, Compensation, and Liability Act, section 102b. A copy of any report required or requested by any Federal agency or State government as a result of a reportable release or spill of any toxic substances shall be furnished to the authorized officer concurrent with the filing of the reports to the involved Federal agency or State government.
3. The holder agrees to indemnify the United States against any liability arising from the release of any hazardous substance or hazardous waste (as these terms are defined in the Comprehensive Environmental Response, Compensation and Liability Act of 1980, 42 U.S.C. 9601, et seq. or the Resource Conservation and Recovery Act, 42 U.S.C. 6901, et seq.) on the Right-of-Way (unless the release or threatened release is wholly unrelated to the Right-of-Way holder's activity on the Right-of-Way), or resulting from the activity of the Right-of-Way holder on the Right-of-Way. This agreement applies without regard to whether a release is caused by the holder, its agent, or unrelated third parties.
4. If, during any phase of the construction, operation, maintenance, or termination of the pipeline, any oil or other pollutant should be discharged from the pipeline system, impacting Federal lands, the control and total removal, disposal, and cleaning up of such oil or other pollutant, wherever found, shall be

the responsibility of holder, regardless of fault. Upon failure of holder to control, dispose of, or clean up such discharge on or affecting Federal lands, or to repair all damages resulting therefrom, on the Federal lands, the Authorized Officer may take such measures as he deems necessary to control and clean up the discharge and restore the area, including where appropriate, the aquatic environment and fish and wildlife habitats, at the full expense of the holder. Such action by the Authorized Officer shall not relieve holder of any responsibility as provided herein.

5. All construction and maintenance activity will be confined to the authorized right-of-way.

6. The pipeline will be buried with a minimum cover of 36 inches between the top of the pipe and ground level.

7. The maximum allowable disturbance for construction in this right-of-way will be 30 feet:

- Blading of vegetation within the right-of-way will be allowed: maximum width of blading operations will not exceed 20 feet. The trench is included in this area. (*Blading is defined as the complete removal of brush and ground vegetation.*)
- Clearing of brush species within the right-of-way will be allowed: maximum width of clearing operations will not exceed 30 feet. The trench and bladed area are included in this area. (*Clearing is defined as the removal of brush while leaving ground vegetation (grasses, weeds, etc.) intact. Clearing is best accomplished by holding the blade 4 to 6 inches above the ground surface.*)
- The remaining area of the right-of-way (if any) shall only be disturbed by compressing the vegetation. (*Compressing can be caused by vehicle tires, placement of equipment, etc.*)

8. The holder shall stockpile an adequate amount of topsoil where blading is allowed. The topsoil to be stripped is approximately 6 inches in depth. The topsoil will be segregated from other spoil piles from trench construction. The topsoil will be evenly distributed over the bladed area for the preparation of seeding.

9. The holder shall minimize disturbance to existing fences and other improvements on public lands. The holder is required to promptly repair improvements to at least their former state. Functional use of these improvements will be maintained at all times. The holder will contact the owner of any improvements prior to disturbing them. When necessary to pass through a fence line, the fence shall be braced on both sides of the passageway prior to cutting of the fence. No permanent gates will be allowed unless approved by the Authorized Officer.

10. Vegetation, soil, and rocks left as a result of construction or maintenance activity will be randomly scattered on this right-of-way and will not be left in rows, piles, or berms, unless otherwise approved by the Authorized Officer. The entire right-of-way shall be recontoured to match the surrounding landscape. The backfilled soil shall be compacted and a 6 inch berm will be left over the ditch line to allow for settling back to grade.

11. In those areas where erosion control structures are required to stabilize soil conditions, the holder will install such structures as are suitable for the specific soil conditions being encountered and which are in accordance with sound resource management practices.

12. The holder will reseed all disturbed areas. Seeding will be done according to the attached seeding requirements, using the following seed mix.

<input type="checkbox"/> seed mixture 1	<input type="checkbox"/> seed mixture 3
<input type="checkbox"/> seed mixture 2	<input type="checkbox"/> seed mixture 4
<input checked="" type="checkbox"/> seed mixture 2/LPC	<input type="checkbox"/> Aplomado Falcon Mixture

13. All above-ground structures not subject to safety requirements shall be painted by the holder to blend with the natural color of the landscape. The paint used shall be color which simulates "Standard Environmental Colors" – **Shale Green**, Munsell Soil Color No. 5Y 4/2.

14. The pipeline will be identified by signs at the point of origin and completion of the right-of-way and at all road crossings. At a minimum, signs will state the holder's name, BLM serial number, and the product being transported. All signs and information thereon will be posted in a permanent, conspicuous manner, and will be maintained in a legible condition for the life of the pipeline.

15. The holder shall not use the pipeline route as a road for purposes other than routine maintenance as determined necessary by the Authorized Officer in consultation with the holder before maintenance begins. The holder will take whatever steps are necessary to ensure that the pipeline route is not used as a roadway. As determined necessary during the life of the pipeline, the Authorized Officer may ask the holder to construct temporary deterrence structures.

16. Any cultural and/or paleontological resources (historic or prehistoric site or object) discovered by the holder, or any person working on his behalf, on public or Federal land shall be immediately reported to the Authorized Officer. Holder shall suspend all operations in the immediate area of such discovery until written authorization to proceed is issued by the Authorized Officer. An evaluation of the discovery will be made by the Authorized Officer to determine appropriate actions to prevent the loss of significant cultural or scientific values. The holder will be responsible for the cost of evaluation and any decision as to proper mitigation measures will be made by the Authorized Officer after consulting with the holder.

17. The operator shall be held responsible if noxious weeds become established within the areas of operations. Weed control shall be required on the disturbed land where noxious weeds exist, which includes associated roads, pipeline corridor and adjacent land affected by the establishment of weeds due to this action. The operator shall consult with the Authorized Officer for acceptable weed control methods, which include following EPA and BLM requirements and policies.

18. Escape Ramps - The operator will construct and maintain pipeline/utility trenches [that are not otherwise fenced, screened, or netted] to prevent livestock, wildlife, and humans from becoming entrapped. At a minimum, the operator will construct and maintain escape ramps, ladders, or other methods of avian and terrestrial wildlife escape in the trenches according to the following criteria:

- a. Any trench left open for eight (8) hours or less is not required to have escape ramps; however, before the trench is backfilled, the contractor/operator shall inspect the trench for wildlife, remove all trapped wildlife, and release them at least 100 yards from the trench.
- b. For trenches left open for eight (8) hours or more, earthen escape ramps (built at no more than a 30 degree slope and spaced no more than 500 feet apart) shall be placed in the trench.

19. Special Stipulations:

Wildlife Mitigation Measures

Timing Limitation Stipulation/Condition of Approval for Lesser Prairie-Chicken:

Oil and gas activities including 3-D geophysical exploration, and drilling will not be allowed in lesser prairie-chicken habitat during the period from March 1st through June 15th annually. During that period, other activities that produce noise or involve human activity, such as the maintenance of oil and gas facilities, geophysical exploration other than 3-D operations, and pipeline, road, and well pad construction, will be allowed except between 3:00 am and 9:00 am. The 3:00 am to 9:00 am restriction will not apply to normal, around-the-clock operations, such as venting, flaring, or pumping, which do not require a human presence during this period. Additionally, no new drilling will be allowed within up to 200 meters of leaks known at the time of permitting. Normal vehicle use on existing roads will not be restricted. Exhaust noise from pump jack engines must be muffled or otherwise controlled so as not to exceed 75 db measured at 30 ft. from the source of the noise.

C. ELECTRIC LINES

STANDARD STIPULATIONS FOR OVERHEAD ELECTRIC DISTRIBUTION LINES

A copy of the grant and attachments, including stipulations, survey plat and/or map, will be on location during construction. BLM personnel may request to you a copy of your permit during construction to ensure compliance with all stipulations.

Holder agrees to comply with the following stipulations to the satisfaction of the Authorized Officer:

1. The holder shall indemnify the United States against any liability for damage to life or property arising from the occupancy or use of public lands under this grant.
2. The holder shall comply with all applicable Federal laws and regulations existing or hereafter enacted or promulgated. In any event, the holder shall comply with the Toxic Substances Control Act of 1976 as amended, 15 USC 2601 et seq. (1982) with regards to any toxic substances that are used, generated by or stored on the right-of-way or on facilities authorized under this right-of-way grant. (See 40 CFR, Part 702-799 and especially, provisions on polychlorinated biphenyls, 40 CFR 761.1-761.193.) Additionally, any release of toxic substances (leaks, spills, etc.) in excess of the reportable quantity established by 40 CFR, Part 117 shall be reported as required by the

Comprehensive Environmental Response, Compensation, and Liability Act, section 102b. A copy of any report required or requested by any Federal agency or State government as a result of a reportable release or spill of any toxic substances shall be furnished to the authorized officer concurrent with the filing of the reports to the involved Federal agency or State government.

3. The holder agrees to indemnify the United States against any liability arising from the release of any hazardous substance or hazardous waste (as these terms are defined in the Comprehensive Environmental Response, Compensation and Liability Act of 1980, 42 U.S.C. 9601, et seq. or the Resource Conservation and Recovery Act, 42 U.S.C. 6901, et seq.) on the Right-of-Way (unless the release or threatened release is wholly unrelated to the Right-of-Way holder's activity on the Right-of-Way), or resulting from the activity of the Right-of-Way holder on the Right-of-Way. This agreement applies without regard to whether a release is caused by the holder, its agent, or unrelated third parties.

4. There will be no clearing or blading of the right-of-way unless otherwise agreed to in writing by the Authorized Officer.

5. Power lines shall be constructed and designed in accordance to standards outlined in "Suggested Practices for Avian Protection on Power lines: The State of the Art in 2006" Edison Electric Institute, APLIC, and the California Energy Commission 2006 . The holder shall assume the burden and expense of proving that pole designs not shown in the above publication deter raptor perching, roosting, and nesting. Such proof shall be provided by a raptor expert approved by the Authorized Officer. The BLM reserves the right to require modification or additions to all powerline structures placed on this right-of-way, should they be necessary to ensure the safety of large perching birds. Such modifications and/or additions shall be made by the holder without liability or expense to the United States.

Raptor deterrence will consist of but not limited to the following: triangle perch discouragers shall be placed on each side of the cross arms and a nonconductive perching deterrence shall be placed on all vertical poles that extend past the cross arms.

6. The holder shall minimize disturbance to existing fences and other improvements on public lands. The holder is required to promptly repair improvements to at least their former state. Functional use of these improvements will be maintained at all times. The holder will contact the owner of any improvements prior to disturbing them. When necessary to pass through a fence line, the fence shall be braced on both sides of the passageway prior to cutting the fence. No permanent gates will be allowed unless approved by the Authorized Officer.

7. The BLM serial number assigned to this authorization shall be posted in a

permanent, conspicuous manner where the power line crosses roads and at all serviced facilities. Numbers will be at least two inches high and will be affixed to the pole nearest the road crossing and at the facilities served.

8. Upon cancellation, relinquishment, or expiration of this grant, the holder shall comply with those abandonment procedures as prescribed by the Authorized Officer.

9. All surface structures (poles, lines, transformers, etc.) shall be removed within 180 days of abandonment, relinquishment, or termination of use of the serviced facility or facilities or within 180 days of abandonment, relinquishment, cancellation, or expiration of this grant, whichever comes first. This will not apply where the power line extends service to an active, adjoining facility or facilities.

10. Any cultural and/or paleontological resource (historic or prehistoric site or object) discovered by the holder, or any person working on his behalf, on public or Federal land shall be immediately reported to the Authorized Officer. Holder shall suspend all operations in the immediate area of such discovery until written authorization to proceed is issued by the Authorized Officer. An evaluation of the discovery will be made by the Authorized Officer to determine appropriate actions to prevent the loss of significant cultural or scientific values. The holder will be responsible for the cost of evaluation and any decision as to proper mitigation measures will be made by the Authorized Officer after consulting with the holder.

11. Special Stipulations:

- For reclamation remove poles, lines, transformer, etc. and dispose of properly.
- Fill in any holes from the poles removed.

Timing Limitation Stipulation/Condition of Approval for Lesser Prairie-Chicken:

Oil and gas activities including 3-D geophysical exploration, and drilling will not be allowed in lesser prairie-chicken habitat during the period from March 1st through June 15th annually. During that period, other activities that produce noise or involve human activity, such as the maintenance of oil and gas facilities, geophysical exploration other than 3-D operations, and pipeline, road, and well pad construction, will be allowed except between 3:00 am and 9:00 am. The 3:00 am to 9:00 am restriction will not apply to normal, around-the-clock operations, such as venting, flaring, or pumping, which do not require a human presence during this period. Additionally, no new drilling will be allowed within up to 200 meters of leks known at the time of permitting. Normal vehicle use on existing roads will not be restricted. Exhaust noise from pump jack engines must be muffled or otherwise controlled so as not to exceed 75 db measured at 30 ft. from the source of the noise.

VIII. INTERIM RECLAMATION

During the life of the development, all disturbed areas not needed for active support of production operations should undergo interim reclamation in order to minimize the environmental impacts of development on other resources and uses.

Within six (6) months of well completion, operators should work with BLM surface management specialists (Jim Amos: 575-234-5909) to devise the best strategies to reduce the size of the location. Interim reclamation should allow for remedial well operations, as well as safe and efficient removal of oil and gas.

During reclamation, the removal of caliche is important to increasing the success of revegetating the site. Removed caliche that is free of contaminants may be used for road repairs, fire walls or for building other roads and locations. In order to operate the well or complete workover operations, it may be necessary to drive, park and operate on restored interim vegetation within the previously disturbed area. Disturbing revegetated areas for production or workover operations will be allowed. If there is significant disturbance and loss of vegetation, the area will need to be revegetated. Communicate with the appropriate BLM office for any exceptions/exemptions if needed.

All disturbed areas after they have been satisfactorily prepared need to be reseeded with the seed mixture provided below.

Upon completion of interim reclamation, the operator shall submit a Sundry Notices and Reports on Wells, Subsequent Report of Reclamation (Form 3160-5).

IX. FINAL ABANDONMENT & RECLAMATION

At final abandonment, well locations, production facilities, and access roads must undergo "final" reclamation so that the character and productivity of the land are restored.

Earthwork for final reclamation must be completed within six (6) months of well plugging. All pads, pits, facility locations and roads must be reclaimed to a satisfactory revegetated, safe, and stable condition, unless an agreement is made with the landowner or BLM to keep the road and/or pad intact.

After all disturbed areas have been satisfactorily prepared, these areas need to be revegetated with the seed mixture provided below. Seeding should be accomplished by drilling on the contour whenever practical or by other approved methods. Seeding may need to be repeated until revegetation is successful, as determined by the BLM.

Operators shall contact a BLM surface protection specialist prior to surface abandonment operations for site specific objectives (Jim Amos: 575-234-5909).

Ground-level Abandoned Well Marker to avoid raptor perching: Upon the plugging and subsequent abandonment of the well, the well marker will be installed at ground level on a plate containing the pertinent information for the plugged well.

Seed Mixture for LPC Sand/Shinnery Sites

Holder shall seed all disturbed areas with the seed mixture listed below. The seed mixture shall be planted in the amounts specified in pounds of pure live seed (PLS)* per acre. There shall be no primary or secondary noxious weeds in the seed mixture. Seed will be tested and the viability testing of seed shall be done in accordance with State law(s) and within nine (9) months prior to purchase. Commercial seed shall be either certified or registered seed. The seed container shall be tagged in accordance with State law(s) and available for inspection by the Authorized Officer.

Seed will be planted using a drill equipped with a depth regulator to ensure proper depth of planting where drilling is possible. The seed mixture will be evenly and uniformly planted over the disturbed area (smaller/heavier seeds have a tendency to drop the bottom of the drill and are planted first). Holder shall take appropriate measures to ensure this does not occur. Where drilling is not possible, seed will be broadcast and the area shall be raked or chained to cover the seed. When broadcasting the seed, the pounds per acre are to be doubled. Seeding shall be repeated until a satisfactory stand is established as determined by the Authorized Officer. Evaluation of growth may not be made before completion of at least one full growing season after seeding.

Species to be planted in pounds of pure live seed* per acre:

<u>Species</u>	<u>lb/acre</u>
Plains Bristlegrass	5lbs/A
Sand Bluestem	5lbs/A
Little Bluestem	3lbs/A
Big Bluestem	6lbs/A
Plains Coreopsis	2lbs/A
Sand Dropseed	1lbs/A

*Pounds of pure live seed:

Pounds of seed x percent purity x percent germination = pounds pure live seed.

1. FORMATION TOPS

The estimated tops of important geologic markers are as follows:

FORMATION	SUB-SEA TVD	KBTVD	MD
Rustler		809	
Castile		3,142	
Lamar		4,721	
Bell Canyon		4,757	
Cherry Canyon		5,352	
Brushy Canyon		7,091	
Bone Spring Limestone		8,712	
Upr. Avalon		8,816	
Top Bone Spring 1		9,701	
Top Bone Spring 2		10,306	
Estimated Target TVD		10,623	21,194

2. ESTIMATED DEPTH OF WATER, OIL, GAS & OTHER MINERAL BEARING FORMATIONS

The estimated depths at which the top and bottom of the anticipated water, oil, gas, or other mineral bearing formations are expected to be encountered are as follows:

Substance	Formation	Depth
Deepest Expected Base of Fresh Water		750
Water	Rustler	809
Water	Bell Canyon	4757
Water	Cherry Canyon	5352
Oil/Gas	Brushy Canyon	7091
Oil/Gas	Bone Spring Limestone	8712
Oil/Gas	Upr. Avalon	8816
Oil/Gas	Top Bone Spring 1	9701
Oil/Gas	Top Bone Spring 2	10306
Oil/Gas	Estimated Target TVD	10623

All shows of fresh water and minerals will be reported and protected.

3. BOP EQUIPMENT

Will have a minimum of a 5000 psi rig stack (see proposed schematic) for drill out below surface casing. . Stack will be tested as specified in the attached testing requirements. Batch drilling of the surface, intermediate, and production will take place. A full BOP test will be performed unless approval from BLM is received otherwise.

Chevron requests a variance to use a FMC UHS Multibowl wellhead, which will be run through the rig floor on surface casing. BOPE will be nipped up and tested after cementing surface casing. Subsequent tests will be performed as needed, not to exceed 30 days. The field report from FMC and BOP test information will be provided in a subsequent report at the end of the well. Please see the attached wellhead schematic. An installation manual has been placed on file with the BLM office and remains unchanged from previous submittal.

Chevron requests a variance to use a CoFlex hose with a metal protective covering that will be utilized between the BOP and Choke manifold. Please refer to the attached testing and specification documents

4. CASING PROGRAM

- a. The proposed casing program will be as follows:

Purpose	From	To	Hole Size	Csg Size	Weight	Grade	Thread	Condition
Surface	0'	850'	17-1/2"	13-3/8"	54.5 #	J55	STC	New
Intermediate	0'	4,818'	12-1/4"	9-5/8"	43.5#	L80	LTC	New
Production	0'	21,194'	8-1/2"	5-1/2"	20.0 #	P-110	TXP BTC	New

- b. Casing design subject to revision based on geologic conditions encountered.

- c. ***A "Worst Case" casing design for wells in a particular area is used below to calculate the Casing Safety Factors. If for any reason the casing design for a particular well requires setting casing deeper than the following "worst case" design, then the Casing Safety Factors will be recalculated & sent to the BLM prior to drilling.

- d. Chevron will fill casing at a minimum of every 20 jts (840') while running for intermediate and production casing in order to maintain collapse SF.

SF Calculations based on the following "Worst Case" casing design:

Surface Casing: 850'
Intermediate Casing: 4,735' TVD
Production Casing: 21,194' MD/10,623' TVD (10,444' VS @ 90 deg inc)

Casing String	Min SF Burst	Min SF Collapse	Min SF Tension	Min SF Tri-Axial
Surface	5.46	2.84	5.94	4.92
Intermediate	2.16	4.31	3.51	2.69
Production	1.11	2.10	2.16	1.29

Min SF is the smallest of a group of safety factors that include the following considerations:

	Surf	Int	Prod
Burst Design			
Pressure Test- Surface, Int, Prod Csg P external: Water P internal: Test psi + next section heaviest mud in csg	X	X	X
Displace to Gas- Surf Csg P external: Water P internal: Dry Gas from Next Csg Point	X		
Frac at Shoe, Gas to Surf- Int Csg P external: Water P internal: Dry Gas, 11.4 ppg Frac Gradient		X	
Stimulation (Frac) Pressures- Prod Csg P external: Water P internal: Max inj pressure w/ heaviest injected fluid			X
Tubing leak- Prod Csg (packer at KOP) P external: Water P internal: Leak just below surf, 8.7 ppg packer fluid			X
Collapse Design			
Full Evacuation P external: Water gradient in cement, mud above TOC P internal: none	X	X	X
Cementing- Surf, Int, Prod Csg P external: Wet cement P internal: water	X	X	X
Tension Design			
100k lb overpull	X	X	X

5. CEMENTING PROGRAM

Slurry	Type	Additives	Top	Bottom	Weight	Yield	%Excess	Sacks	Water
Surface					(ppg)	(sx/cu ft)	Open Hole		gal/sk
Tail	Class C	Extender Antifoam Retarder	0'	850'	14.8	1.34	50	718	6.40
Intermediate									
Lead	50/50 POZ/C	Antifoam Extender Salt Retarder Viscosifier	0'	4,218'	11.9	2.56	100	945	14.05
Tail	Class C	Antifoam Retarder Viscosifier	4,218'	4,818'	14.8	1.33	85	290	6.38
Production									
Lead	Class C	Antifoam Dispersent Fluid Loss Retarder Viscosifier	4,318'	10,104'	11.9	2.46	50	790	14.05
1st Tail	Class C	Antifoam Dispersent Fluid Loss Retarder Viscosifier	10,104'	20,194'	14.5	1.34	35	2337	6.36
2nd Tail	Acid Soluble/Class H	Antifoam Dispersent Fluid Loss Retarder Viscosifier	20,194'	21,194'	15	2.19	0	105	9.54

1. Final cement volumes will be determined by caliper.
2. Surface casing shall have at least one centralizer installed on each of the bottom three joints starting with the shoe joint.
3. Production casing will have one horizontal type centralizer on every joint for the first 1000' from TD, then every other joint to EOB, and then every third joint to KOP. Bowspring type centralizers will be run from KOP to intermediate casing.

6. MUD PROGRAM

From	To	Type	Weight	F. Vis	Filtrate
0'	850'	Spud Mud	8.3 - 8.7	32 - 34	NC - NC
850'	4,818'	Brine	9.5 - 10.2	28 - 30	NC - NC
4,818'	21,194'	Oil Based Mud	8.3 - 9.6	70 - 75	15 - 25

A closed system will be utilized consisting of above ground steel tanks. All wastes accumulated during drilling operations will be contained in a portable trash cage and removed from location and deposited in an approved sanitary landfill. Sanitary wastes will be contained in a chemical porta-toilet and then hauled to an approved sanitary landfill.

All fluids and cuttings will be disposed of in accordance with New Mexico Oil Conservation Division rules and regulations.

A mud test shall be performed every 24 hours after mudding up to determine, as applicable: density, viscosity, gel strength, filtration, and pH.

Visual mud monitoring equipment shall be in place to detect volume changes indicating loss or gain of circulating fluid volume. When abnormal pressures are anticipated -- a pit volume totalizer (PVT), stroke counter, and flow sensor will be used to detect volume changes indicating loss or gain of circulating fluid volume.

A weighting agent and lost circulating material (LCM) will be onsite to mitigate pressure or lost circulation as hole conditions dictate.

7. TESTING, LOGGING, AND CORING

The anticipated type and amount of testing, logging, and coring are as follows:

- a. Drill stem tests are not planned.
- b. The logging program will be as follows:

TYPE	Logs	Interval	Timing	Vendor
Mudlogs	2 man mudlog	Int Csg to TD	Drillout of Int Csg	TBD
LWD	MWD Gamma	Int. and Prod. Hole	While Drilling	TBD

- c. Conventional whole core samples are not planned.
- d. A Directional Survey will be run.

8. ABNORMAL PRESSURES AND HYDROGEN SULFIDE

- a. No abnormal pressures or temperatures are expected. Estimated BHP is: 5099 psi
- b. Hydrogen sulfide gas is not anticipated. An H2S Contingency plan is attached with this APD in the event that H2S is encountered



H₂S Preparedness and Contingency Plan Summary

CO Yeti 15 22 Fed Com 51H, 52H, 53H, 54H, 55H, 56H

Training

MCBU Drilling and Completions H₂S training requirements are intended to define the minimum level of training required for employees, contractors and visitors to enter or perform work at MCBU Drilling and Completions locations that have known concentrations of H₂S.

Awareness Level

Employees and visitors to MCBU Drilling and Completions locations that have known concentrations of H₂S, who are not required to perform work in H₂S areas, will be provided with an awareness level of H₂S training prior to entering any H₂S areas. At a minimum, awareness level training will include:

1. Physical and chemical properties of H₂S
2. Health hazards of H₂S
3. Personal protective equipment
4. Information regarding potential sources of H₂S
5. Alarms and emergency evacuation procedures

Awareness level training will be developed and conducted by personnel who are qualified either by specific training, educational experience and/or work-related background.

Advanced Level H₂S Training

Employees and contractors required to work in areas that may contain H₂S will be provided with Advanced Level H₂S training prior to initial assignment. In addition to the Awareness Level requirements, Advanced Level H₂S training will include:

1. H₂S safe work practice procedures;
2. Emergency contingency plan procedures;
3. Methods to detect the presence or release of H₂S (e.g., alarms, monitoring equipment), including hands-on training with direct reading and personal monitoring H₂S equipment.
4. Basic overview of respiratory protective equipment suitable for use in H₂S environments. Note: Employees who work at sites that participate in the Chevron Respirator User program will require separate respirator training as required by the MCBU Respiratory Protection Program;
5. Basic overview of emergency rescue techniques, first aid, CPR and medical evaluation procedures. Employees who may be required to perform "standby" duties are required to receive additional first aid and CPR training, which is not covered in the Advanced Level H₂S training;
6. Proficiency examination covering all course material.

Advanced H₂S training courses will be instructed by personnel who have successfully completed an appropriate H₂S train-the-trainer development course (ANSI/ASSE Z390.1-2006) or who possess significant past experience through educational or work-related background.



H₂S Preparedness and Contingency Plan Summary

H₂S Training Certification

All employees and visitors will be issued an H₂S training certification card (or certificate) upon successful completion of the appropriate H₂S training course. Personnel working in an H₂S environment will carry a current H₂S training certification card as proof of having received the proper training on their person at all times.

Briefing Area

A minimum of two briefing areas will be established in locations that at least one area will be upwind from the well at all times. Upon recognition of an emergency situation, all personnel should assemble at the designated upwind briefing areas for instructions.

H₂S Equipment

Respiratory Protection

- a) Six 30 minute SCBAs – 2 at each briefing area and 2 in the Safety Trailer.
- b) Eight 5 minute EBAs – 5 in the dog house at the rig floor, 1 at the accumulator, 1 at the shale shakers and 1 at the mud pits.

Visual Warning System

- a) One color code sign, displaying all possible conditions, will be placed at the entrance to the location with a flag displaying the current condition.
- b) Two windsocks will be on location, one on the dog house and one on the Drill Site Manager's Trailer.

H₂S Detection and Monitoring System

- a) H₂S monitoring system (sensor head, warning light and siren) placed throughout rig.
 - Drilling Rig Locations: at a minimum, in the area of the Shale shaker, rig floor, and bell nipple.
 - Workover Rig Locations: at a minimum, in the area of the Cellar, rig floor and circulating tanks or shale shaker.

H₂S Preparedness and Contingency Plan Summary



Well Control Equipment

- a) Flare Line 150' from wellhead with igniter.
- b) Choke manifold with a remotely operated choke.
- c) Mud / gas separator

Mud Program

In the event of drilling, completions, workover and well servicing operations involving a hydrogen sulfide concentration of 100 ppm or greater the following shall be considered:

- 1. Use of a degasser
- 2. Use of a zinc based mud treatment
- 3. Increasing mud weight

Public Safety - Emergency Assistance

<u>Agency</u>	<u>Telephone Number</u>
Eddy County Sheriff's Department	575-887-7551
Carlsbad Fire Department	575-885-3125
Carlsbad Medical Center	575-887-4100
Eddy County Emergency Management	575-885-3581
Poison Control Center	800-222-1222

Chevron U.S.A. Inc. (CUSA)
SUNDRY ATTACHMENT: SPUDDER RIG

DATA OPERATOR NAME: Chevron U.S.A. Inc.


1. SUMMARY OF REQUEST:

CUSA respectfully requests approval for the following operations for the surface hole in the drill plan:

1. Utilize a spudder rig to pre-set surface casing for time and cost savings.

2. Description of Operations

1. Spudder rig will move in to drill the surface hole and pre-set surface casing on the well.
 - a. After drilling the surface hole section, the spudder rig will run casing and cement following all the applicable rules and regulations (OnShore Order 2, all COAs and NMOCD regulations).
 - b. The spudder rig will utilize fresh water-based mud to drill the surface hole to TD. Solids control will be handled entirely on a closed loop basis. No earth pits will be used.
2. The wellhead will be installed and then tested offline after the WOC time has been reached.
3. An abandonment cap at the same pressure rating as the wellhead will be installed to seal the wellbore. Pressure will be monitored with needle valves installed on one wing-valve.
 - a. A means for intervention will be maintained while the drilling rig is not over the well.
4. Spudder rig operations are expected to take 2-3 days per well on the pad.
5. The BLM will be contacted and notified 24 hours prior to commencing spudder rig operations.
6. Drilling operations will begin with a larger rig and a BOP stack equal to or greater than the pressure rating that was permitted will be nipped up and tested on the wellhead before drilling operations resume on each well.
 - a. The larger rig will move back onto the location within 90 days from the point at which the wells are secured and the spudder rig is moved off location.
 - b. The BLM will be contacted / notified 24 hours before the larger rig moves back on the pre-set locations.
7. CUSA will have supervision on the rig to ensure compliance with all BLM and NMOCD regulations and to oversee operations.
8. Once the rig is removed, CUSA will secure the wellhead area by placing a guard rail around the cellar area.

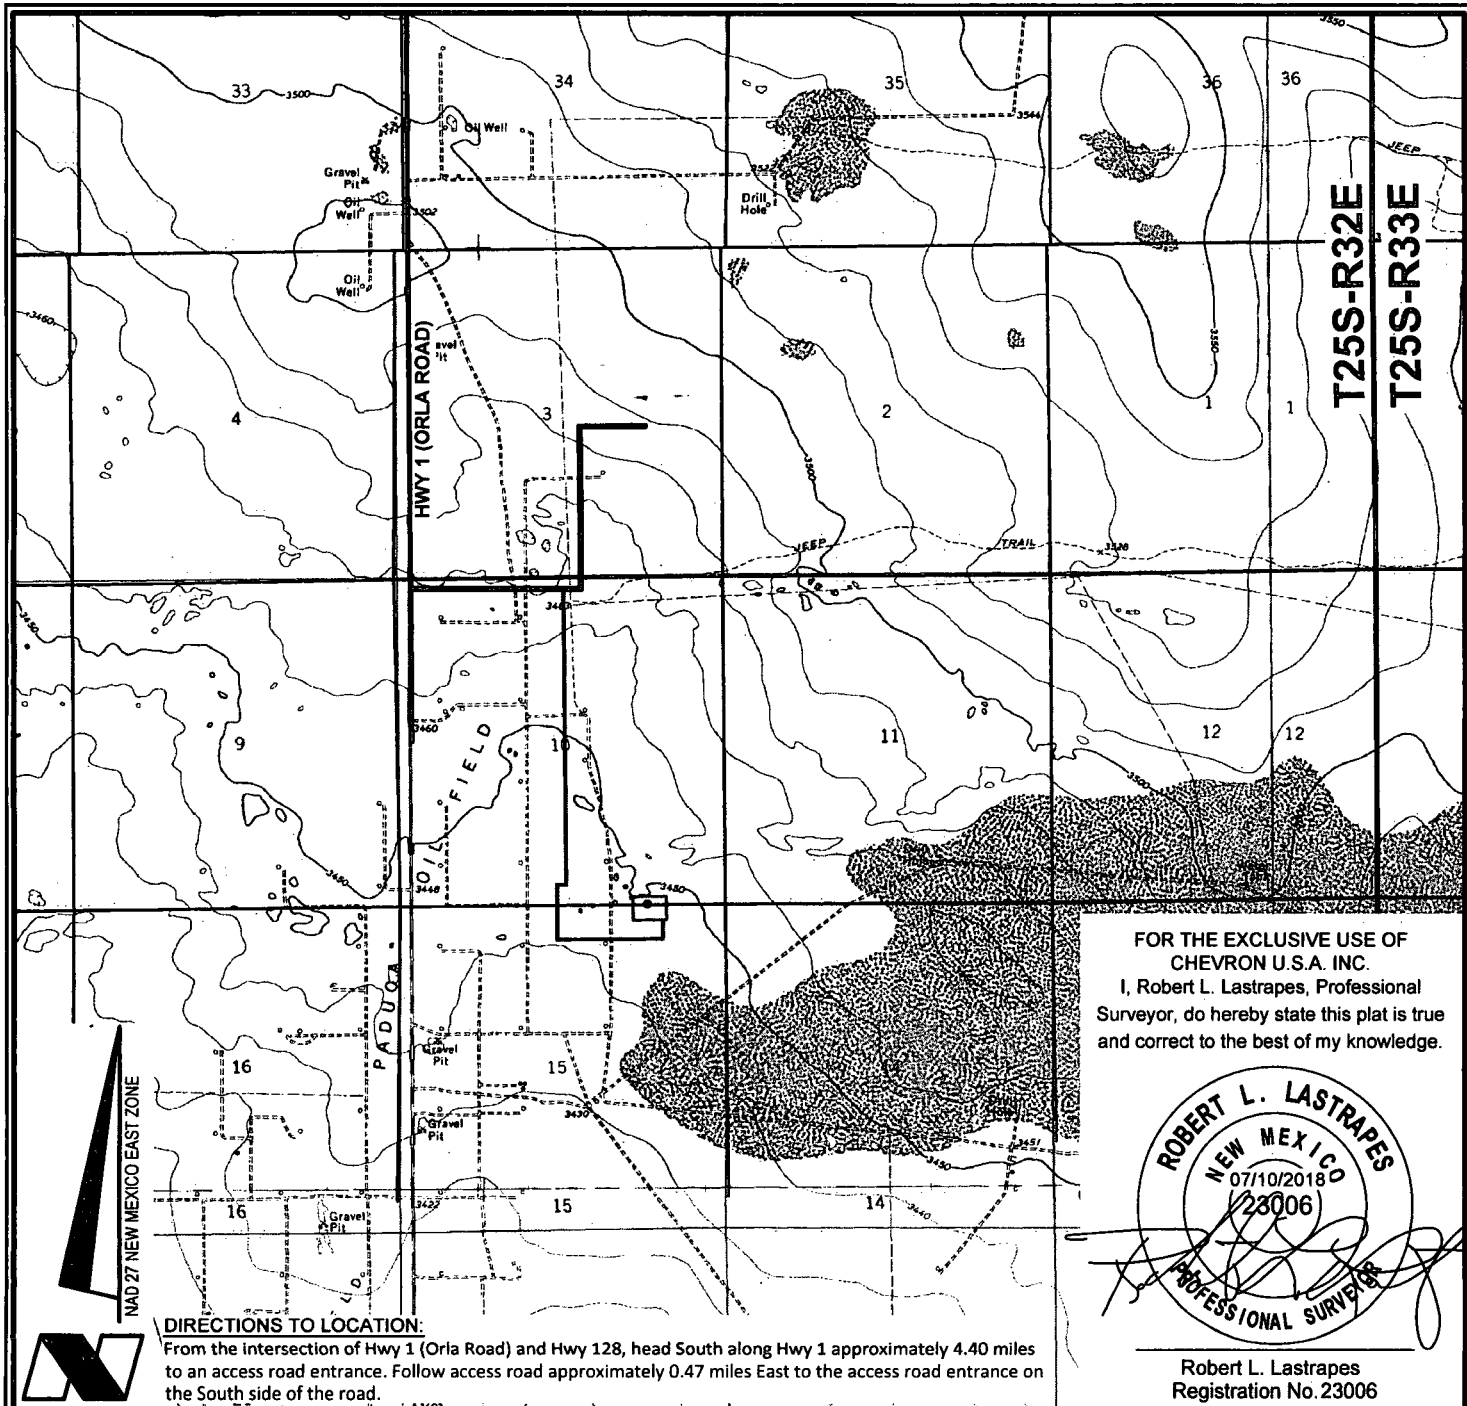

ROAD PLAT

Scale: 1" = 3000'

3000' 0 1500' 3000'

LEGEND

- Proposed Well
- Proposed Access Road
- Proposed Drillsite
- Existing Road
- Section Line
- Township & Range

CHEVRON U.S.A. INC.

CO YETI 15 22 FED COM NO. 0055H WELL
 LOCATED 10' FNL AND 1,235' FEL
 SECTION 15, T25S-R32E
 LEA COUNTY, NEW MEXICO



C. H. Fenstermaker & Associates, L.L.C.
 135 Regency Sq. Lafayette, LA 70508
 Ph. 337-237-2200 Fax. 337-232-3299
www.fenstermaker.com

REVISIONS


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DATE: 06/27/2018				
FILENAME: T:\2018\2187192\DWG\CO Yeti 15 22 Fed Com 0055H_Road Plat.dwg				

Bureau of Land Management



Bureau of Land Management

FOR THE EXCLUSIVE USE OF
CHEVRON U.S.A. INC.
I, Robert L. Lastrapes, Professional
Surveyor, do hereby state this plat is true
and correct to the best of my knowledge.

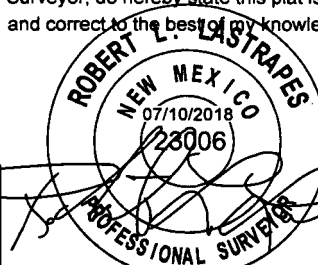

Robert L. Lastrapes
Registration No. 23006

Page 1 of 3

CHEVRON U.S.A. INC.
PROPOSED PAD
CO YETI 15 22 FED COM NOS. 0051H-0056H WELLS
SECTIONS 10 & 15, T25S-R32E
LEA COUNTY, NEW MEXICO

REVISIONS


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DATE: 02/19/2018	3	DMB	07/05/2018	Expanded pad & added wells.

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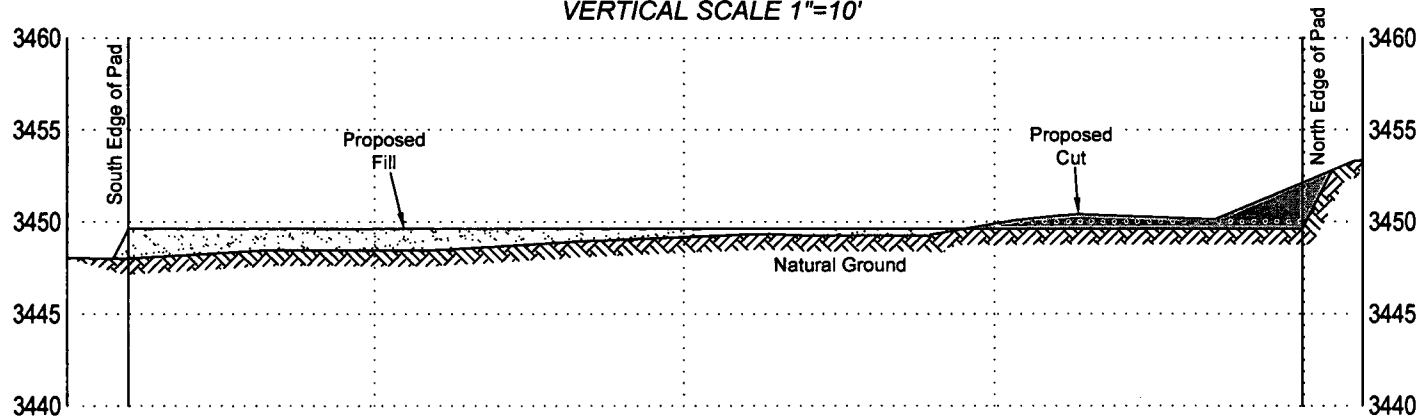


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CROSS SECTION A-A'
HORIZONTAL SCALE 1"=60'
VERTICAL SCALE 1"=10'



CROSS SECTION B-B'
HORIZONTAL SCALE 1"=60'
VERTICAL SCALE 1"=10'

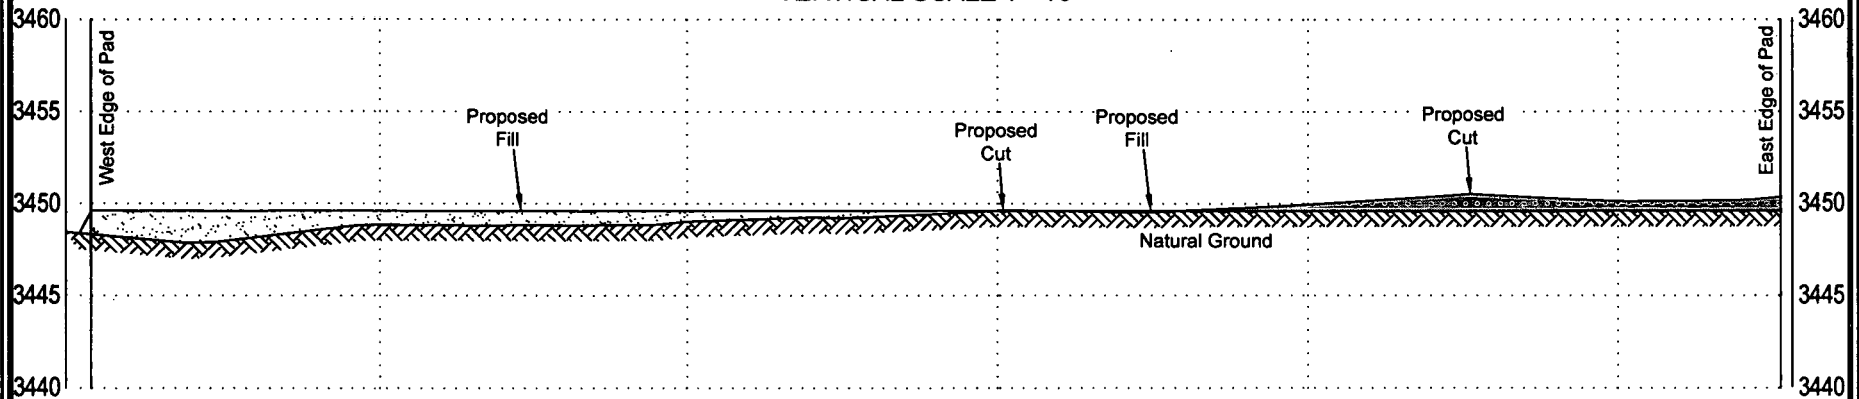

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CUT & FILL PLAT

Page 2 of 3

CHEVRON U.S.A. INC.


PROPOSED PAD
CO YETI 15 22 FED COM NOS. 0051H-0056H WELLS
SECTIONS 10 & 15, T25S-R32E
LEA COUNTY, NEW MEXICO

REVISIONS

DRAWN BY:	#	BY:	DATE:	DESCRIPTION:
DMB	2	DMB	04/18/2018	Added access road & removed 4H well.
DATE: 02/19/2018	3	DMB	07/05/2018	Expanded pad & added wells.
FILENAME: T:\2018\2187192\DWG\CO Yeti 15 22 Fed Com 0051H-0056H_Cut-Fill.dwg				



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NOTE:

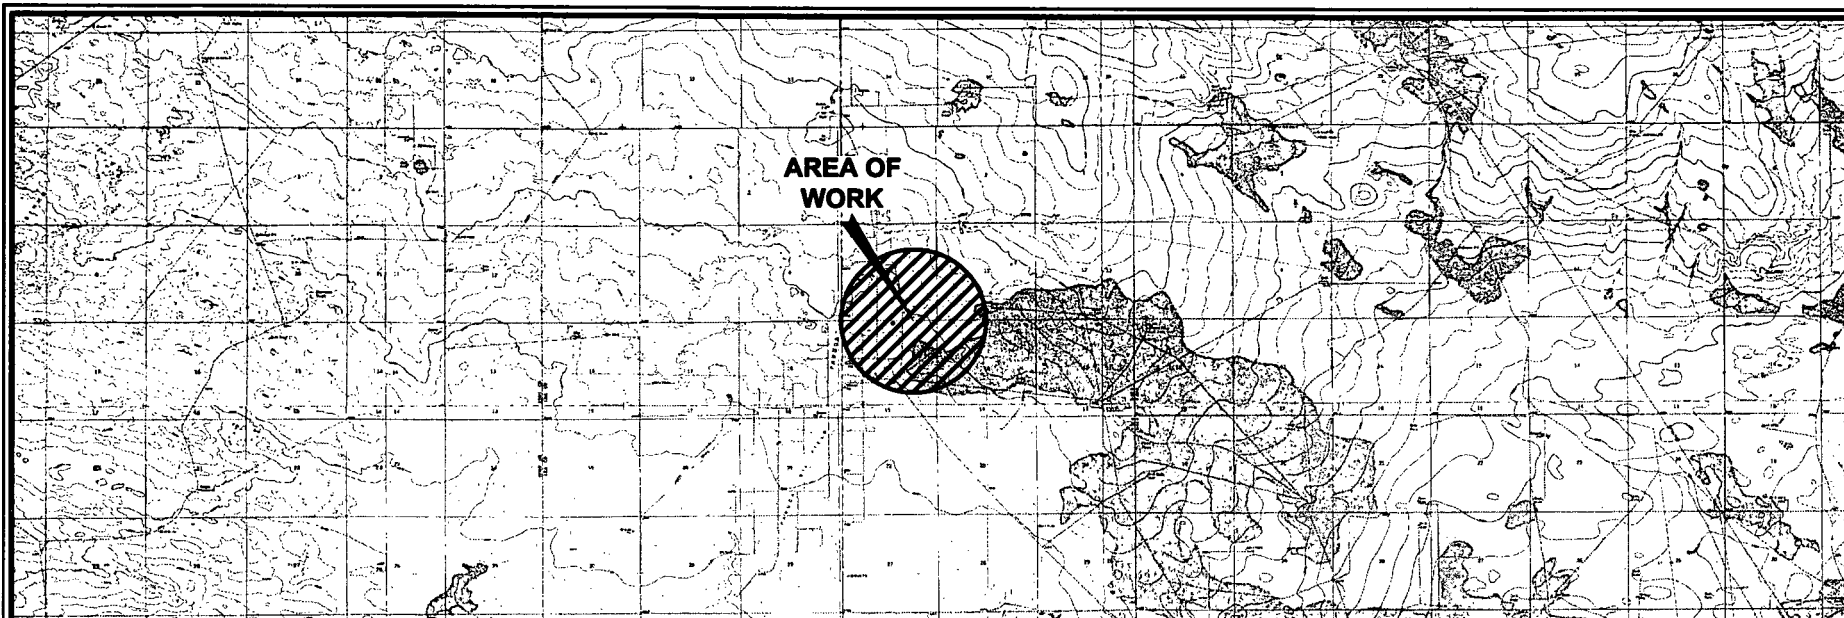1. Many states maintain information centers that establish links between those who dig (excavators) and those who own and operate underground facilities (operators). It is advisable and in most states, law, for the contractor to contact the center for assistance in locating and marking underground utilities. For guidance: New Mexico One Call www.nmonecall.org.

2. The design pad elevation recommendation is based solely on a cut and fill (1:1 ratio) balance of the pad and does not include material required for the access roads. A detailed soil test and slope stability analysis shall be performed prior to construction to ensure proper compaction and working performance of the pad under the anticipated loadings. This material balance sheet does not constitute a foundation design and C. H. Fenstermaker & Associates, L.L.C. makes no warranty to the structural integrity of the site layout as shown. Fenstermaker also makes no recommendation or warranty about the layout relative to flood hazards, erosion control, or soil stability issues. Elevations refer to the North American Vertical Datum of 1988.

3. Please be advised, that while reasonable efforts are made to locate and verify pipelines and anomalies using our standard pipeline locating equipment, it is impossible to be 100 % effective. As such, we advise using caution when performing work as there is a possibility that pipelines and other hazards, such as fiber optic cables, PVC pipelines, etc. may exist undetected on site.

DISCLAIMER: At this time, C. H. Fenstermaker & Associates, L.L.C. has not performed nor was asked to perform any type of engineering, hydrological modeling, flood plain, or "No Rise" certification analyses, including but not limited to determining whether the project will impact flood hazards in connection with federal/FEMA, state, and/or local laws, ordinances and regulations. Accordingly, Fenstermaker makes no warranty or representation of any kind as to the foregoing issues, and persons or entities using this information shall do so at their own risk.

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I, Robert L. Lastrapes, Professional
Surveyor, do hereby state this plat is true
and correct to the best of my knowledge.



Robert L. Lastrapes
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CUT & FILL PLAT

Page 3 of 3

CHEVRON U.S.A. INC.

PROPOSED PAD

CO YETI 15 22 FED COM NOS. 0051H-0056H WELLS

SECTIONS 10 & 15, T25S-R32E

LEA COUNTY, NEW MEXICO

REVISIONS

DRAWN BY:	DMB	#	BY:	DATE:	DESCRIPTION:
PROJ. MGR.:	VHV	2	DMB	04/18/2018	Added access road & removed 4H well.
DATE:	02/19/2018	3	DMB	07/05/2018	Expanded pad & added wells.
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Scale: 1" = 10,000'
10,000' 0 5,000' 10,000'




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R 32 E
Sec. 10

Bureau of Land Management

CO YETI 15 22 FED COM NO. 0055H WELL			
X=	709,121		
Y=	414,440		
LAT.	32.137610 N	NAD 27	
LONG.	103.657735 W		
X=	750,306		
Y=	414,498		
LAT.	32.137734 N	NAD83/2011	
LONG.	103.658211 W		
ELEV.	+3,452'	NAVD88	

T
25
S

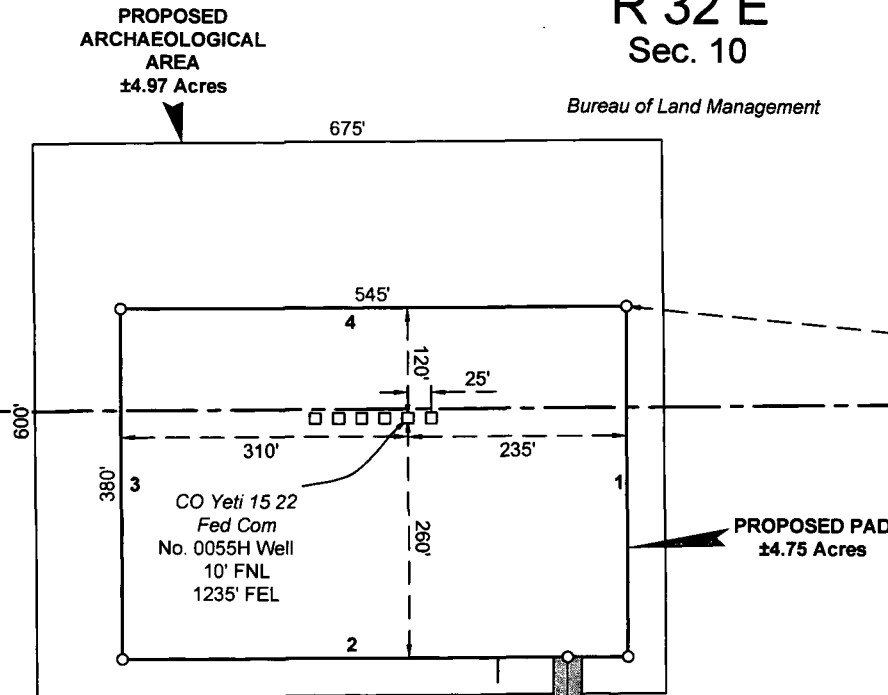

Sec. 15

Bureau of Land Management


LEGEND	
	Proposed Pad
	CL Proposed Access Road
	Section Line
	Proposed ROW
	Fnd. Monument

NAD 27 NEW MEXICO EAST ZONE



Scale: 1" = 200'
200' 0 100' 200'

FOR THE EXCLUSIVE USE OF
CHEVRON U.S.A. INC.
I, Robert L. Lastrapes, Professional
Surveyor, do hereby state this plat is true
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Page 1 of 3

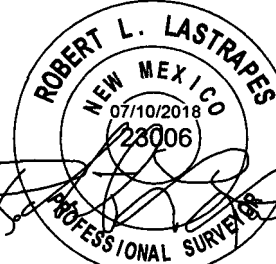CHEVRON U.S.A. INC.
PROPOSED PAD & ACCESS ROAD
CO YETI 15 22 FED COM NO. 0055H WELL
SECTIONS 10 & 15, T25S-R32E
LEA COUNTY, NEW MEXICO

REVISIONS				
DRAWN BY:	#	BY:	DATE:	DESCRIPTION:
PROJ. MGR.: VHV				
DATE: 06/26/2018				
FILENAME: T:\2018\2187192\DWG\ICO Yeti 15 22 Fed Com 0055H_Well Plat.dwg				

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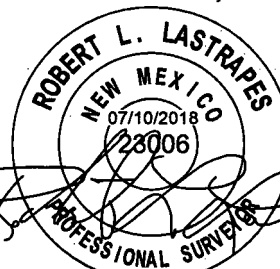
PROPOSED PAD		
COURSE	BEARING	DISTANCE
1	S 00° 26' 34" E	380.00'
2	S 89° 33' 26" W	545.00'
3	N 00° 26' 34" W	380.00'
4	N 89° 33' 26" E	545.00'

CENTERLINE PROPOSED ACCESS ROAD		
COURSE	BEARING	DISTANCE
5	SOUTH	303.05'
6	S 89° 27' 56" W	1056.28'
7	S 89° 36' 03" W	659.62'
8	N 00° 23' 57" W	57.11'
9	N 00° 03' 33" W	270.17'
10	N 00° 01' 43" W	254.85'
11	N 01° 06' 34" W	261.09'
12	N 00° 44' 07" W	38.19'
13	EAST	148.48'
14	N 00° 32' 17" W	4744.59'

NW ARCH. AREA CORNER		NE ARCH. AREA CORNER	
X=	708,718 NAD 27	X=	709,393 NAD 27
Y=	414,736	Y=	414,743
LAT.	32.138431	LAT.	32.138437
LONG.	103.659030	LONG.	103.656849
X=	749,903 NAD83	X=	750,578 NAD83
Y=	414,794	Y=	414,801
LAT.	32.138555	LAT.	32.138561
LONG.	103.659506	LONG.	103.657325
SW ARCH. AREA CORNER		SE ARCH. AREA CORNER	
X=	708,724 NAD 27	X=	709,399 NAD 27
Y=	414,136	Y=	414,143
LAT.	32.136781	LAT.	32.136788
LONG.	103.659023	LONG.	103.656843
X=	749,909 NAD83	X=	750,584 NAD83
Y=	414,194	Y=	414,201
LAT.	32.136906	LAT.	32.136912
LONG.	103.659499	LONG.	103.657318

NW PAD CORNER		NE PAD CORNER	
X=	708,810 NAD 27	X=	709,355 NAD 27
Y=	414,558	Y=	414,562
LAT.	32.137938	LAT.	32.137940
LONG.	103.658736	LONG.	103.656976
X=	749,995 NAD83	X=	750,540 NAD83
Y=	414,616	Y=	414,620
LAT.	32.138063	LAT.	32.138065
LONG.	103.659212	LONG.	103.657451
SW PAD CORNER		SE PAD CORNER	
X=	708,813 NAD 27	X=	709,358 NAD 27
Y=	414,178	Y=	414,182
LAT.	32.136894	LAT.	32.136896
LONG.	103.658735	LONG.	103.656974
X=	749,998 NAD83	X=	750,543 NAD83
Y=	414,236	Y=	414,240
LAT.	32.137018	LAT.	32.137020
LONG.	103.659210	LONG.	103.657449

FOR THE EXCLUSIVE USE OF
CHEVRON U.S.A. INC.
I, Robert L. Lastrapes, Professional
Surveyor, do hereby state this plat is true
and correct to the best of my knowledge.



Robert L. Lastrapes
Registration No. 23006



C. H. Fenstermaker & Associates, L.L.C.
135 Regency Sq. Lafayette, LA 70508
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CHEVRON U.S.A. INC.
PROPOSED PAD & ACCESS ROAD
CO YETI 15 22 FED COM NO. 0055H WELL
SECTIONS 10 & 15, T25S-R32E
LEA COUNTY, NEW MEXICO


Page 3 of 3

REVISIONS				
DRAWN BY:	#	BY:	DATE:	DESCRIPTION:
PROJ. MGR.: VHV				
DATE: 06/26/2018				
FILENAME: T:\2018\2187192\DWG\CO Yeti 15 22 Fed Com 0055H_Well Plat.dwg				

API	Well Name	Operator
30025081680000	COTTON DRAW UNIT	TEXACO INCORPORATED
30025081690000	COTTON DRAW UNIT	TEXACO INCORPORATED
30025081700000	COTTON DRAW UNIT	TEXACO INCORPORATED
30025081710000	COTTON DRAW UNIT	TEXACO INCORPORATED
30025081720000	EF RAY-FEDERAL B	TEXACO INCORPORATED
30025081720001	RAY EF-FEDERA B	TEXACO INCORPORATED
30025081730000	EF RAY-FEDERAL B	TEXACO INCORPORATED
30025081740000	COTTON DRAW UNIT	TEXACO INCORPORATED
30025081740001	COTTON DRAW UNIT	TEXACO INCORPORATED
30025081750000	COTTON DRAW UNIT	TEXACO INCORPORATED
30025081760000	COTTON DRAW UNIT	TEXACO INCORPORATED
30025081770000	EF RAY-FEDERA NCT-2	TEXACO INCORPORATED
30025081780000	EF RAY-FEDERAL B	TEXACO INCORPORATED
30025081790000	COTTON DRAW UNIT	TEXACO INCORPORATED
30025081800000	CONTINENTAL-FED	WESTATES PETROLEUM COMPANY
30025081810000	ORA HILL-FED 14	HILL & MEEKER
30025081820000	COTTON DRAW UNIT	TEXACO INCORPORATED
30025081830000	COTTON DRAW UNIT	TEXACO INCORPORATED
30025081830001	COTTON DRAW UNIT	TEXACO INCORPORATED
30025081840000	GE JORDAN NCT-1	TEXACO INCORPORATED
30025081850000	JORDAN G E FEDERAL NCT-1	TEXACO INCORPORATED
30025081860000	COTTON DRAW UNIT	TEXACO INCORPORATED
30025081860001	COTTON DRAW UNIT	TEXACO INCORPORATED
30025081870000	COTTON DRAW UNIT	TEXACO INCORPORATED
30025081880000	COTTON DRAW UNIT	TEXACO INCORPORATED
30025081890000	COTTON DRAW UNIT	TEXACO INCORPORATED
30025081900000	COTTON DRAW UNIT	TEXACO INCORPORATED
30025081910000	COTTON DRAW UNIT	TEXACO INCORPORATED
30025081910001	COTTON DRAW UNIT	TEXACO INCORPORATED
30025081920000	COTTON DRAW UNIT	TEXACO INCORPORATED
30025081920001	COTTON DRAW UNIT	TEXACO INCORPORATED
30025081940000	COTTON DRAW UNIT	TEXACO INCORPORATED
30025081950000	COTTON DRAW UNIT	TEXACO INCORPORATED
30025081960000	MONSANTO-STATE	TENNESSEE GAS TRANSMISSION COMPANY
30025081970000	MONSANTO-STATE	TENNESSEE GAS TRANSMISSION COMPANY
30025082030000	COTTON DRAW UNIT	TEXACO INCORPORATED
30025082040000	COTTON DRAW UNIT	TEXACO INCORPORATED
30025082050000	COTTON DRAW UNIT	TEXACO INCORPORATED
30025082180000	COTTON DRAW UNIT-FE	TEXACO INCORPORATED
30025082190000	COTTON DRAW UNIT	TEXACO INCORPORATED
30025082200000	COTTON DRAW UNIT	TEXACO INCORPORATED

30025082210000	COTTON DRAW UNIT	TEXACO INCORPORATED
30025082210001	COTTON DRAW UNIT	TEXACO INCORPORATED
30025082220000	COTTON DRAW UNIT	TEXACO INCORPORATED
30025082230000	COTTON DRAW UNIT	TEXACO INCORPORATED
30025082260000	GE JORDAN-FED NCT-1	TEXACO INCORPORATED
30025082360000	COTTON DRAW UNIT	TEXACO INCORPORATED
30025082380000	GE JORDAN-FED NCT-1	TEXACO INCORPORATED
30025201200000	COTTON DRAW UNIT	TEXACO INCORPORATED
30025220240000	COTTON DRAW UNIT	TEXACO INCORPORATED
30025220240001	COTTON DRAW SWD	MESQUITE SWD INCORPORATED
30025221370000	FEDERAL O	ONEILL JOSEPH I JR
30025222150000	FEDERAL P	ONEILL JOSEPH I JR
30025224300000	FEDERAL O	ONEILL JOSEPH I JR
30025276160000	PDUC FEDRL UNIT COM	SUPERIOR OIL COMPANY THE
30025276160001	PADUCA SWD	MESQUITE SWD INCORPORATED
30025278630000	DUNCAN FED	SUPERIOR OIL COMPANY THE
30025278720000	PADUCA UT	YATES PEYTON
30025278730000	COTTON DRAW UNIT	TEXACO INCORPORATED
30025289280000	PADUCA UNIT	YATES PETROLEUM CORPORATION
30025295770000	PADUCA UNIT	YATES PETROLEUM CORPORATION
30025303870000	PADUCA UNIT	YATES PETROLEUM CORPORATION
30025311770000	PADUCA AIU FEDERAL	YATES PETROLEUM CORPORATION
30025311770001	PADUCA AIU FEDERAL SWD	CIMAREX ENERGY COMPANY
30025374210000	MONSANTO STATE	POGO PRODUCING COMPANY
30025375210000	COTTON DRAW UNIT	POGO PRODUCING COMPANY
30025375940000	COTTON DRAW UNIT	POGO PRODUCING COMPANY
30025375980000	COTTON DRAW UNIT	POGO PRODUCING COMPANY
30025376310000	COTTON DRAW UNIT	POGO PRODUCING COMPANY
30025376330000	COTTON DRAW UNIT	POGO PRODUCING COMPANY
30025376350000	COTTON DRAW UNIT	POGO PRODUCING COMPANY
30025376360000	COTTON DRAW UNIT	POGO PRODUCING COMPANY
30025376570000	COTTON DRAW UNIT	POGO PRODUCING COMPANY
30025376580000	COTTON DRAW UNIT	POGO PRODUCING COMPANY
30025376590000	COTTON DRAW UNIT	POGO PRODUCING COMPANY
30025376600000	COTTON DRAW UNIT	POGO PRODUCING COMPANY
30025377760000	COTTON DRAW UNIT	POGO PRODUCING COMPANY
30025378020000	COTTON DRAW UNIT	POGO PRODUCING COMPANY
30025378030000	COTTON DRAW UNIT	POGO PRODUCING COMPANY
30025408130000	PADUCA FEDERAL SWD	MESQUITE SWD INCORPORATED
30025419960000	COTTON DRAW UNIT	DEVON ENERGY PRODUCTION COMPANY L P
30025422530000	PADUCA FEDERAL SWD	MESQUITE SWD INCORPORATED
30025422580000	PADUCA FEDERAL SWD	MESQUITE SWD INCORPORATED
30025423030000	FUGGLES 14 FEDERAL COM	CIMAREX ENERGY COMPANY
30025427170000	BLUE QUAIL SWD FEDERAL	MESQUITE SWD INCORPORATED
30025400690000	SOL 28 FEDERAL	COG PRODUCTION LLC
30025408030000	SOL 28 FEDERAL	COG PRODUCTION LLC
30025412130000	FEARLESS 'BSF' FEDERAL COM	YATES PETROLEUM CORPORATION
30025419960100	COTTON DRAW UNIT	DEVON ENERGY PRODUCTION COMPANY L P
30025421100000	FEARLESS 'BSF' FEDERAL COM	EOG RESOURCES INCORPORATED
30025423000000	FUGGLES 11 FEDERAL COM	CIMAREX ENERGY COMPANY
30025423010000	FUGGLES 11 FEDERAL COM	CIMAREX ENERGY COMPANY
30025423010100	FUGGLES 11 FEDERAL COM	CIMAREX ENERGY COMPANY
30025423020100	FUGGLES 14 FEDERAL COM	CIMAREX ENERGY COMPANY
30025423030100	FUGGLES 14 FEDERAL COM	CIMAREX ENERGY COMPANY
30025426340000	PADUCA BREAKS 9 FEDERAL	DEVON ENERGY PRODUCTION COMPANY L P
30025433420000	JENNINGS 27 WOBO FED COM	MEWBOURNE OIL COMPANY
30025433530000	JENNINGS 27 WOAP FED COM	MEWBOURNE OIL COMPANY
30025433540000	JENNINGS 27 W1AP FED COM	MEWBOURNE OIL COMPANY
30025446470000	JENNINGS 27 W1BO FEDERAL COM	MEWBOURNE OIL COMPANY

CO YETI 15 22 FED COM
0055H

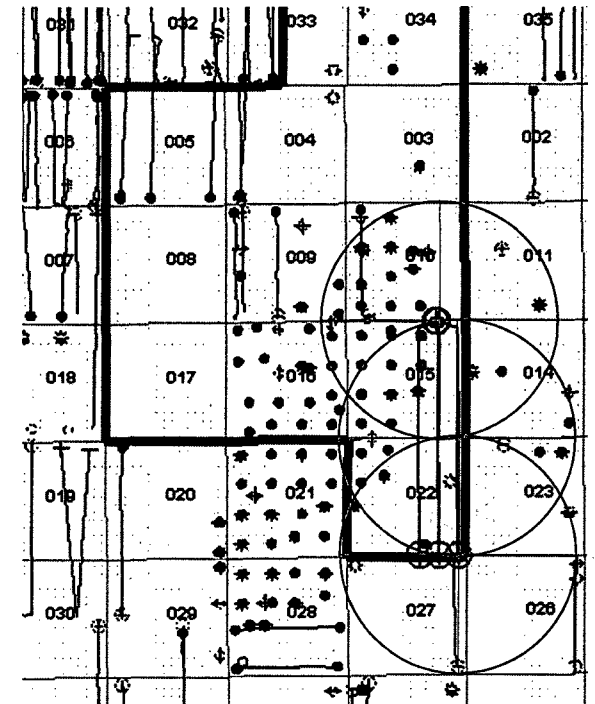

Proposed 60'
Wide ROW

Proposed Yeti Pad Access

R 32 E

PAD DESIGN TABLE

PT	NATURAL GROUND ELEV.	DESIGN ELEV.	CUT / FILL
A	3447.35	3447.23	-0.12
B	3447.44	3447.23	-0.21
C	3448.98	3447.23	-1.75
D	3447.99	3447.23	-0.76
E	3447.01	3447.23	0.22
F	3446.66	3447.23	0.57
G	3445.27	3447.23	1.96
H	3446.48	3447.23	0.75

CUT VOLUME = 2,581.17 Cu. Yd.
FILL VOLUME = 2,581.17 Cu. Yd.
NET VOLUME = 0.00 Cu. Yd.


PROPOSED CENTRAL
TANK BATTERY

T
25
S

FILL AREA

CUT AREA

FOR THE EXCLUSIVE USE OF
CHEVRON U.S.A. INC.
I, Robert L. Lastrapes, Professional
Surveyor, do hereby state this plat is true
and correct to the best of my knowledge.

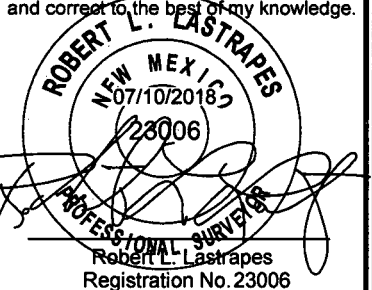

NAD 27 NEW MEXICO EAST ZONE



Scale: 1" = 100'

100' 0 50' 100'

Sec. 15

Bureau of Land Management

CUT & FILL PLAT

Page 1 of 3

CHEVRON U.S.A. INC.

PROPOSED PAD
COTTON DRAW CENTRAL TANK BATTERY PAD
SECTION 15, T25S-R32E
LEA COUNTY, NEW MEXICO

REVISIONS


DRAWN BY:	#	BY:	DATE:	DESCRIPTION:
PROJ. MGR.: VHV	1	AMT	04/20/2018	Removed Access.
DATE: 03/26/2018	2	BOR	06/22/2018	CTB moved east.

FILENAME: T:\2018\2187194\DWG\Cotton Draw CTB_Sec 15_Cut & Fill.dwg




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CROSS SECTION A-A'

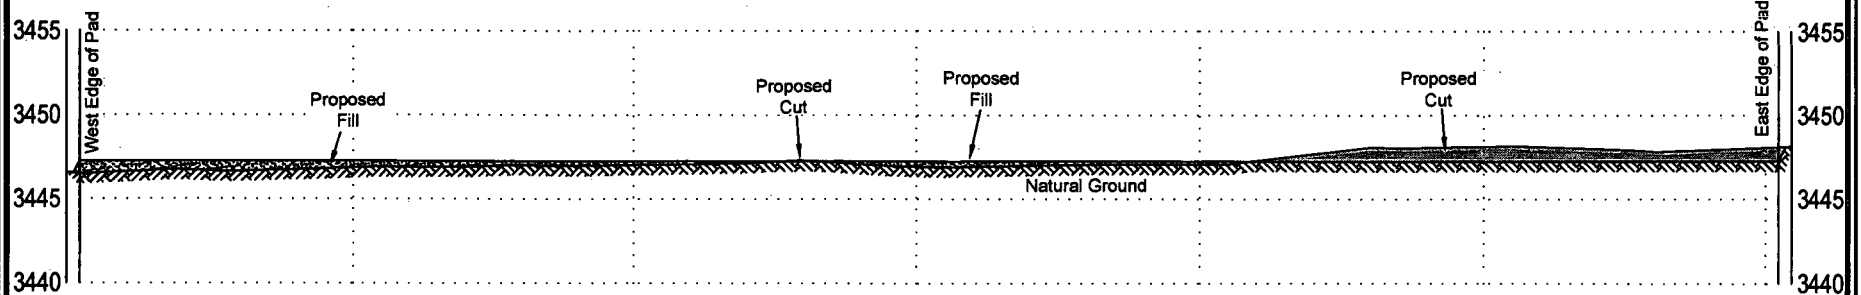

CROSS SECTION B-B'

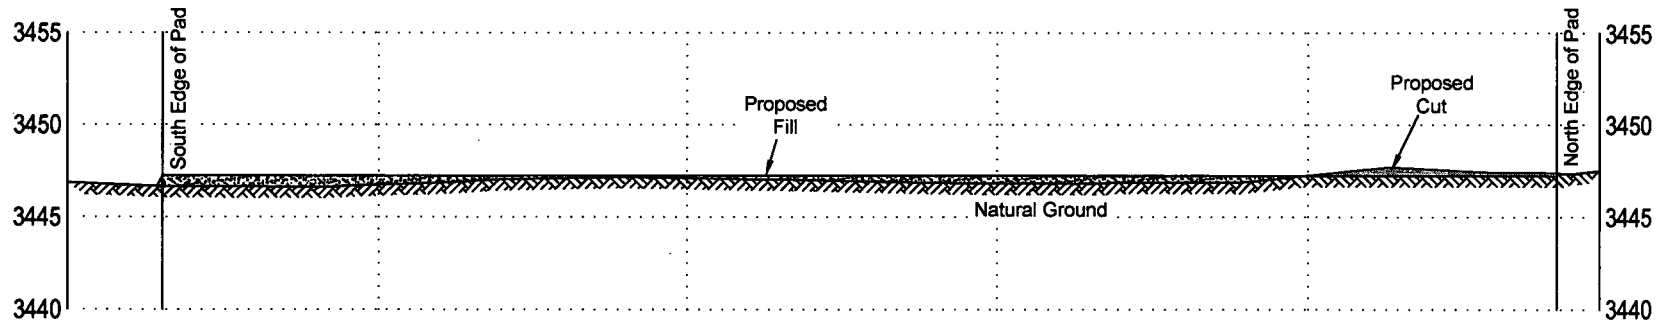

FOR THE EXCLUSIVE USE OF
CHEVRON U.S.A. INC.
I, Robert L. Lastrapes, Professional
Surveyor, do hereby state this plat is true
and correct to the best of my knowledge.



Robert L. Lastrapes
Registration No. 23006

CUT & FILL PLAT

Page 2 of 3


CHEVRON U.S.A. INC.
PROPOSED PAD
COTTON DRAW CENTRAL TANK BATTERY PAD
SECTION 15, T25S-R32E
LEA COUNTY, NEW MEXICO

REVISIONS

DRAWN BY:	#	BY:	DATE:	DESCRIPTION:
PROJ. MGR.: VHV	1	AMT	04/20/2018	Removed Access.
DATE: 03/26/2018	2	BOR	06/22/2018	CTB moved east.
FILENAME: T:\2018\2187194\DWG\Cotton Draw CTB_Sec 15_Cut & Fill.dwg				



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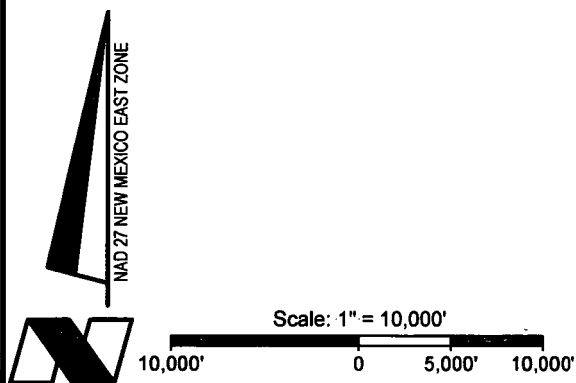
DISCLAIMER: At this time, C. H. Fenstermaker & Associates, L.L.C. has not performed nor was asked to perform any type of engineering, hydrological modeling, flood plain, or "No Rise" certification analyses, including but not limited to determining whether the project will impact flood hazards in connection with federal/FEMA, state, and/or local laws, ordinances and regulations. Accordingly, Fenstermaker makes no warranty or representation of any kind as to the foregoing issues, and persons or entities using this information shall do so at their own risk.

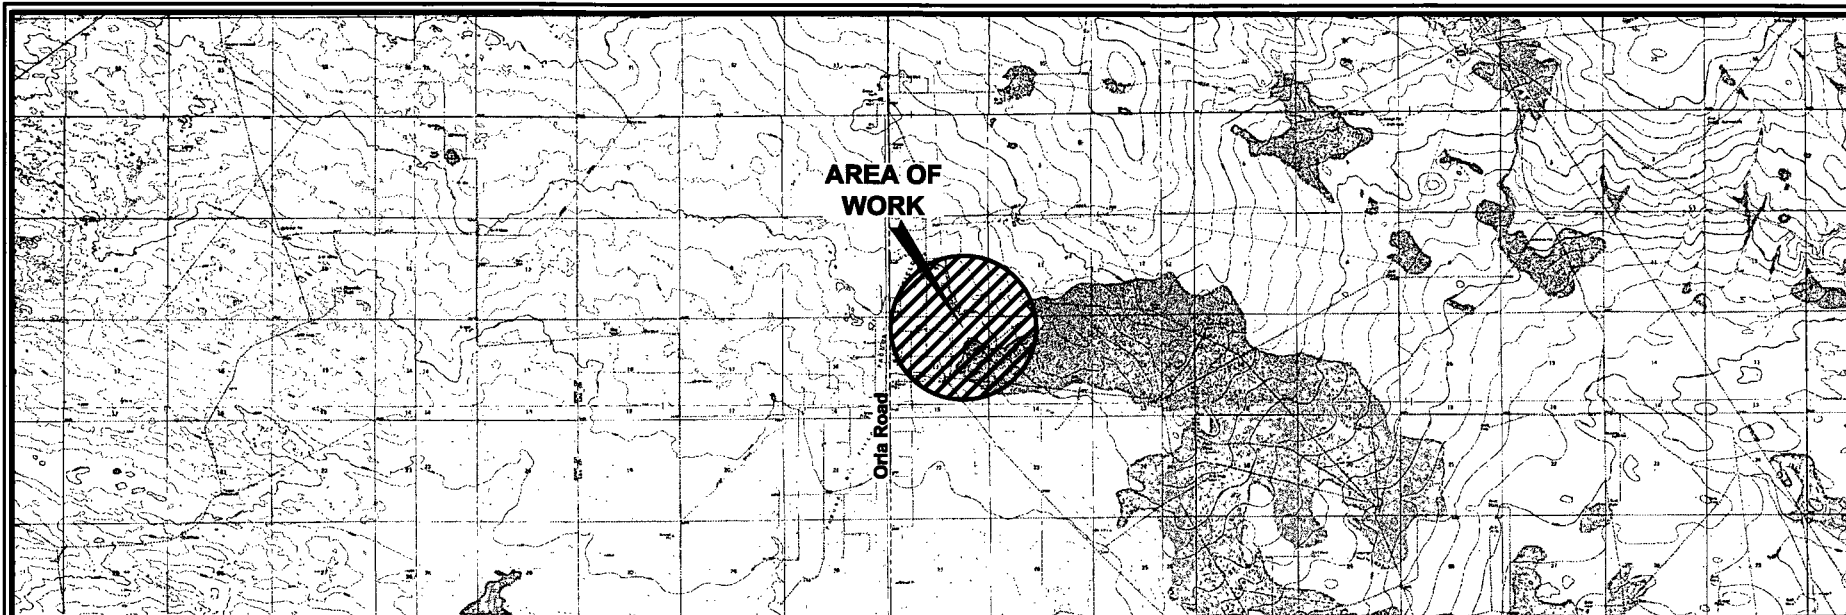NOTE:

1. Many states maintain information centers that establish links between those who dig (excavators) and those who own and operate underground facilities (operators). It is advisable and in most states, law, for the contractor to contact the center for assistance in locating and marking underground utilities. For guidance: New Mexico One Call www.nmonecall.org.

2. The design pad elevation recommendation is based solely on a cut and fill (1:1 ratio) balance of the pad and does not include material required for the access roads. A detailed soil test and slope stability analysis shall be performed prior to construction to ensure proper compaction and working performance of the pad under the anticipated loadings. This material balance sheet does not constitute a foundation design and C. H. Fenstermaker & Associates, L.L.C. makes no warranty to the structural integrity of the site layout as shown. Fenstermaker also makes no recommendation or warranty about the layout relative to flood hazards, erosion control, or soil stability issues. Elevations refer to the North American Vertical Datum of 1988.

3. Please be advised, that while reasonable efforts are made to locate and verify pipelines and anomalies using our standard pipeline locating equipment, it is impossible to be 100 % effective. As such, we advise using caution when performing work as there is a possibility that pipelines and other hazards, such as fiber optic cables, PVC pipelines, etc. may exist undetected on site.



FOR THE EXCLUSIVE USE OF
CHEVRON U.S.A. INC.
I, Robert L. Lastrapes, Professional
Surveyor, do hereby state this plat is true
and correct to the best of my knowledge.



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Robert L. Lastrapes
Registration No. 23006


CUT & FILL PLAT

Page 3 of 3

CHEVRON U.S.A. INC.
PROPOSED PAD
COTTON DRAW CENTRAL TANK BATTERY PAD
SECTION 15, T25S-R32E
LEA COUNTY, NEW MEXICO

REVISIONS

DRAWN BY:	#	BY:	DATE:	DESCRIPTION:
PROJ. MGR.: VHV	1	AMT	04/20/2018	Removed Access.
DATE: 03/26/2018	2	BOR	06/22/2018	CTB moved east.
FILENAME: T:\2018\2187194\DWG\Cotton Draw CTB_Sec 15_Cut & Fill.dwg				

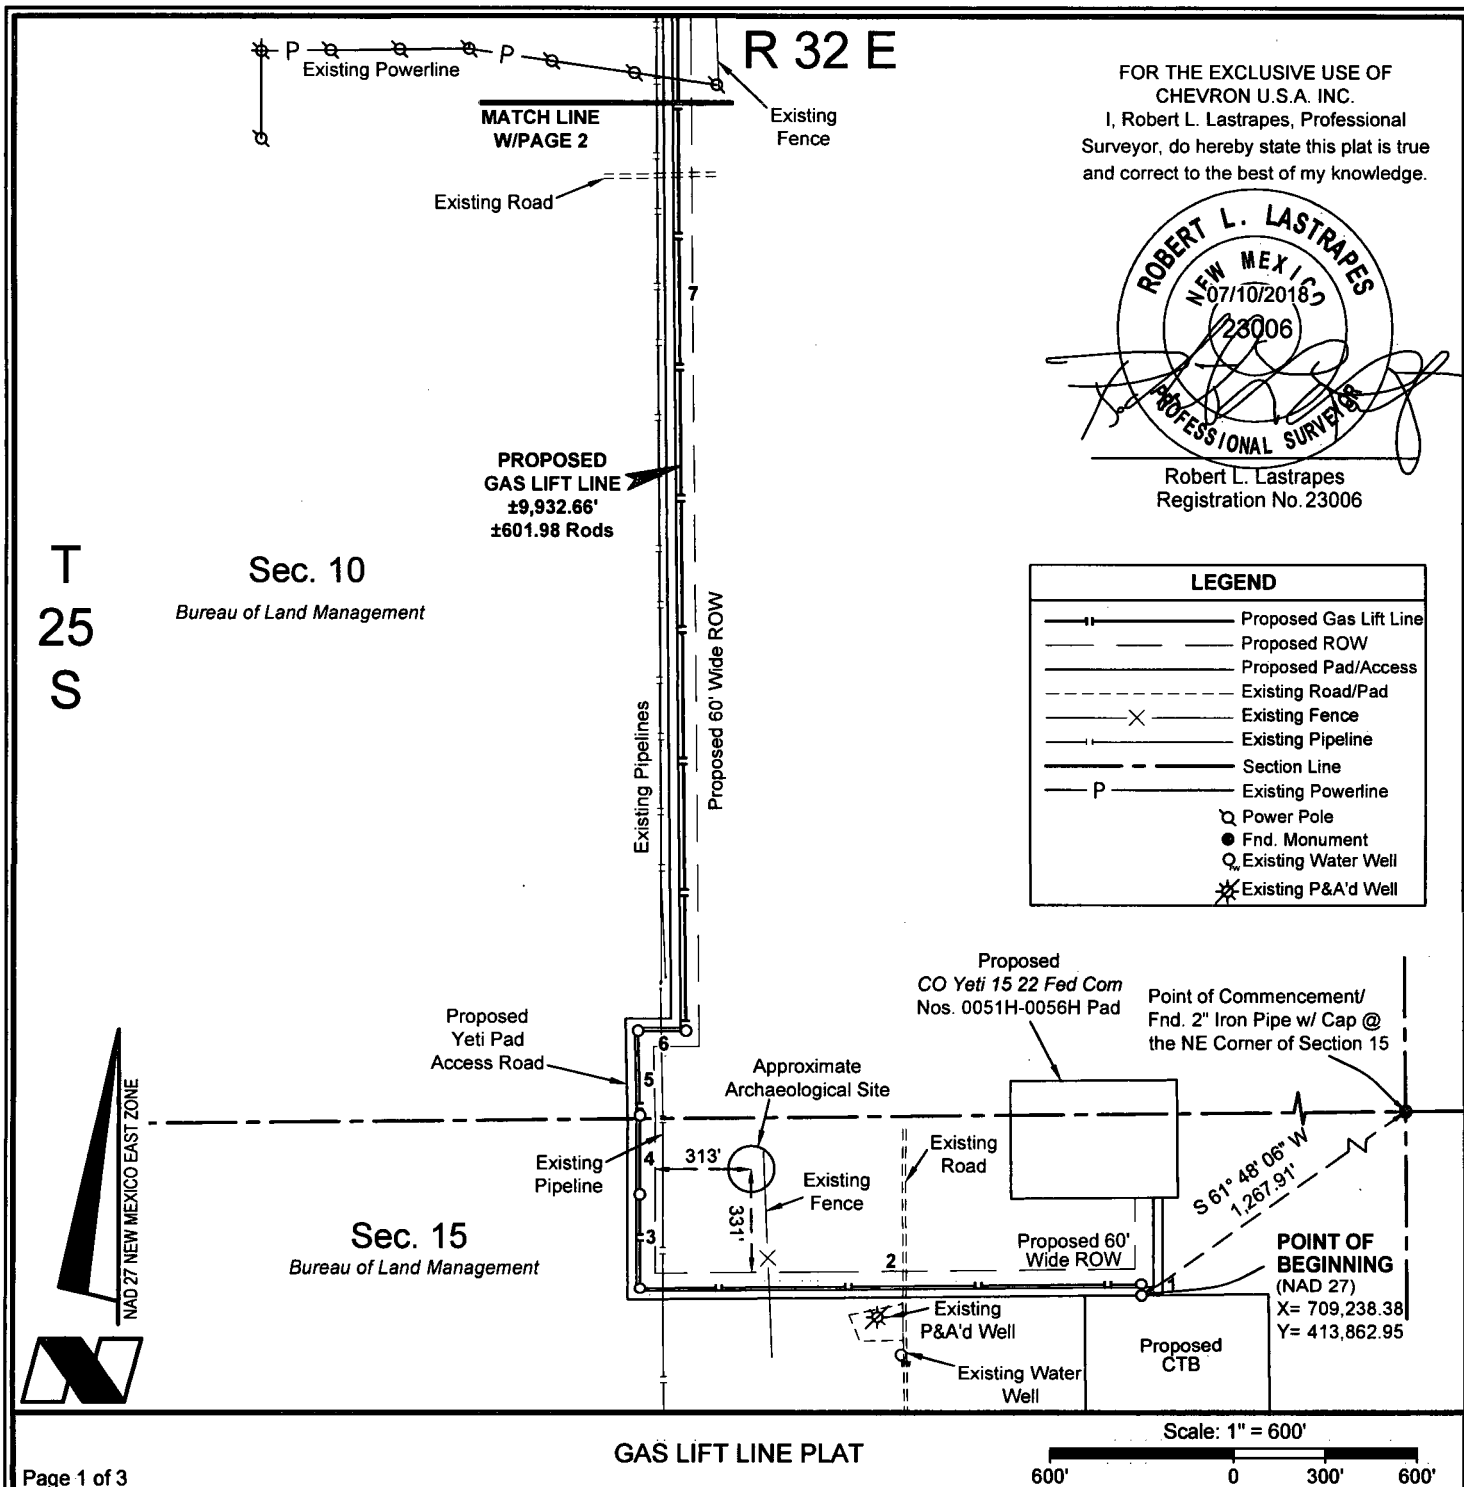

Page 1 of 3

CHEVRON U.S.A. INC.
PROPOSED GAS LIFT LINE
COTTON DRAW CENTRAL TANK BATTERY
SECTIONS 15, 10 & 3, T25S-R32E
LEA COUNTY, NEW MEXICO



C. H. Fenstermaker & Associates, L.L.C.
 135 Regency Sq. Lafayette, LA 70508
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REVISIONS				
DRAWN BY:	#	BY:	DATE:	DESCRIPTION:
PROJ. MGR.: VHV	1	AMT	04/20/2018	Removed Access Road & 4H Well.
DATE: 04/10/2018	2	AMT	06/29/2018	Revised ROW, access, pads & gas lift line.
FILENAME: T:\2018\2187194\DWG\Cotton Draw CTB_Sec 15_Gas Lift Line.dwg				

R 32 E

POINT OF ENDING
(NAD 27)
X= 707,976.23
Y= 421,700.75

Proposed Central
Tank Battery

FOR THE EXCLUSIVE USE OF
CHEVRON U.S.A. INC.
I, Robert L. Lastrapes, Professional
Surveyor, do hereby state this plat is true
and correct to the best of my knowledge.



Sec. 3

Bureau of Land Management

T
25
S

Existing Pipelines

Proposed 60' Wide ROW

Texaco
P & A'd Well

N 50° 03' 40" W 3,055.76'

Proposed
Compressor
Station

Existing Pipeline

Existing Powerline

Proposed Grizzly Pad Access Road

PROPOSED
GAS LIFT LINE
±9,932.66'
±601.98 Rods

Proposed
60' Wide
ROW

Existing
Fence

Fnd. 2" Iron Pipe w/
Cap @ the SE
Corner of Section 3

Sec. 10

Bureau of Land Management

Proposed
Yeti Pad
Access Road

Existing Powerline

MATCH LINE
W/PAGE 1

LEGEND

	Proposed Gas Lift Line
	Proposed ROW
	Proposed Pad/Access
	Existing Road
	Existing Fence
	Existing Pipeline
	Section Line
	Existing Powerline
	Power Pole
	Fnd. Monument
	P & A'd Well

GAS LIFT LINE PLAT

Scale: 1" = 600'

600' 0 300' 600'

Page 2 of 3

CHEVRON U.S.A. INC.
PROPOSED GAS LIFT LINE
COTTON DRAW CENTRAL TANK BATTERY
SECTIONS 15, 10 & 3, T25S-R32E
LEA COUNTY, NEW MEXICO



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REVISIONS

DRAWN BY:	#	BY:	DATE:	DESCRIPTION:
PROJ. MGR:	VHV	1	AMT 04/20/2018	Removed Access & 4H Well.
DATE:	04/10/2018	2	AMT 06/29/2018	Revised ROW, access, pads 7 gas lift line.
FILENAME: T:\2018\2187194\DWG\Cotton Draw CTB_Sec 15_Gas Lift Line.dwg				

**METES AND BOUNDS DESCRIPTION OF
PROPOSED GAS LIFT LINE
SECTIONS 15, 10 AND 3 OF TOWNSHIP 25 SOUTH RANGE 32 EAST
LEA COUNTY, NEW MEXICO**

Survey of a proposed gas lift line 9,932.66 feet or 601.98 rods crossing Bureau of Land Management land in Sections 15, 10 and 3 of Township 25 South Range 32 East, N.M.P.M. Lea County, New Mexico.

COMMENCING at a Found 2" Iron Pipe with Cap at the Northeast Corner of said Section 15; Thence South 61 degrees 48 minutes 06 seconds West 1,267.91 feet to the **POINT OF BEGINNING** having the following coordinates: X=709,238.38 and Y=413,862.95 (New Mexico State Plane Coordinate System, East Zone, NAD 27);

Thence North 00 degrees 32 minutes 04 seconds West 40.00 feet to a point;
Thence South 89 degrees 27 minutes 56 seconds West 1,636.46 feet to a point;
Thence North 00 degrees 03 minutes 33 seconds West 303.63 feet to a point;
Thence North 00 degrees 01 minutes 43 seconds West 255.07 feet to a point;
Thence North 01 degrees 06 minutes 34 seconds West 274.04 feet to a point;
Thence East 156.02 feet to a point;
Thence North 00 degrees 32 minutes 23 seconds West 4,752.19 feet to a point;
Thence South 89 degrees 58 minutes 59 seconds East 286.69 feet to a point;

Thence North 00 degrees 27 minutes 07 seconds West 2,228.56 feet to the **POINT OF ENDING** having the following coordinates: X=707,976.23 and Y=421,700.75 (New Mexico State Plane Coordinate System, East Zone, NAD 27)

The bearings recited hereon are oriented to NAD 27 New Mexico East Zone.

This description represents a survey made on the ground of a proposed gas lift line and intended solely for that purpose. This description does not represent a boundary survey.

PROPOSED GAS LIFT LINE			PROPOSED GAS LIFT LINE		
COURSE	BEARING	DISTANCE	COURSE	BEARING	DISTANCE
1	N 00° 32' 04" W	40.00'	6	EAST	156.02'
2	S 89° 27' 56" W	1636.46'	7	N 00° 32' 23" W	4752.19'
3	N 00° 03' 33" W	303.63'	8	S 89° 58' 59" E	286.69'
4	N 00° 01' 43" W	255.07'	9	N 00° 27' 07" W	2228.56'
5	N 01° 06' 34" W	274.04'			

NOTE:


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FOR THE EXCLUSIVE USE OF
CHEVRON U.S.A. INC.
I, Robert L. Lastrapes, Professional
Surveyor, do hereby state this plat is true
and correct to the best of my knowledge.



Robert L. Lastrapes
Registration No. 23006

GAS LIFT LINE PLAT

Page 3 of 3

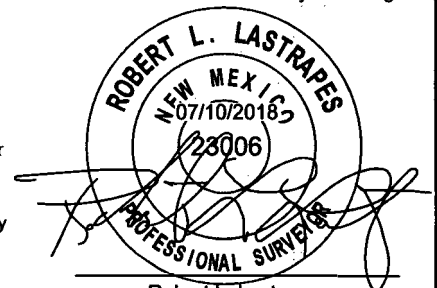**CHEVRON U.S.A. INC.
PROPOSED GAS LIFT LINE
COTTON DRAW CENTRAL TANK BATTERY
SECTIONS 15, 10 & 3, T25S-R32E
LEA COUNTY, NEW MEXICO**



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REVISIONS			
DRAWN BY:	BOR	#	BY: DATE: DESCRIPTION:
PROJ. MGR.:	VHV	1	AMT 04/20/2018 Removed Access & 4H Well.
DATE:	04/10/2018	2	AMT 06/29/2018 Revised ROW, access, pad & gas lift line.
FILENAME: T:\2018\2187194\DWG\Cotton Draw CTB_Sec 15_Gas Lift Line.dwg			

Sec. 10

Bureau of Land Management

R 32 E

Point of Commencement/
Fnd. 2" Iron Pipe
w/ Cap @ NE Corner
of Section 15

Proposed
CO Yeti 15 22 Fed Com
Nos. 0051H-0056H Pad

Existing Road

S 65° 14' 04" W 1,434.31'

Sec. 15

Bureau of Land Management

T
25
S

POINT OF ENDING

(NAD 27)
X= 709,052.64
Y= 413,943.72

Proposed 60' Wide ROW

Proposed Yeti Pad EDS Line

Proposed Yeti Pad Access Road

PROPOSED
EDS LINE
±82.50'
±5.00 Rods

POINT OF BEGINNING

(NAD 27)
X= 709,053.41
Y= 413,861.22

Proposed CTB

Existing
P&A'd Well

Existing
Water Well

FOR THE EXCLUSIVE USE OF
CHEVRON U.S.A. INC.
I, Robert L. Lastrapes, Professional
Surveyor, do hereby state this plat is true
and correct to the best of my knowledge.

ROBERT L. LASTRAPES
NEW MEXICO
07/10/2018
23006

Robert L. Lastrapes
Registration No. 23006

LEGEND

- Section Line
- Proposed Pad/Access Road
- Proposed EDS Line
- Proposed EDS Line
- Proposed ROW
- Existing Road
- Found Monument
- Existing Water Well
- Existing P&A'd Well

Page 1 of 2

EDS LINE PLAT

Scale: 1" = 200'

200' 0 100' 200'

CHEVRON U.S.A. INC.
PROPOSED EDS LINE
COTTON DRAW CENTRAL TANK BATTERY
SECTION 15, T25S-R32E
LEA COUNTY, NEW MEXICO



C. H. Fenstermaker & Associates, L.L.C.
135 Regency Sq. Lafayette, LA 70508
Ph. 337-237-2200 Fax. 337-232-3299
www.fenstermaker.com

REVISIONS

DRAWN BY: BOR	#	BY:	DATE:	DESCRIPTION:
PROJ. MGR.: VHV	1	AMT	04/20/2018	Removed Access Road & Revised EDS Line.
DATE: 04/10/2018	2	AMT	06/29/2018	Revised the ROW, access, pads and eds line.
FILENAME: T:\2018\2187194\DWG\Cotton Draw CTB_Sec 15_EDS Line.dwg				

**METES AND BOUNDS DESCRIPTION OF
PROPOSED EDS LINE
SECTION 15 OF TOWNSHIP 25 SOUTH RANGE 32 EAST
LEA COUNTY, NEW MEXICO**

Survey of a proposed EDS line 82.50 feet or 5.00 rods crossing Bureau of Land Management land in Section 15 of Township 25 South Range 32 East, N.M.P.M. Lea County, New Mexico.

COMMENCING at a Found 2" Iron Pipe with Cap at the Northeast Corner of said Section 15; Thence South 65 degrees 14 minutes 04 seconds West 1,434.31 feet to the **POINT OF BEGINNING** having the following coordinates: X=709,053.41 and Y=413,861.22(New Mexico State Plane Coordinate System, East Zone, NAD 27);

Thence North 00 degrees 32 minutes 04 seconds West 82.50 feet to the **POINT OF ENDING** having the following coordinates: X=709,052.64 and Y=413,943.72 (New Mexico State Plane Coordinate System, East Zone, NAD 27)

The bearings recited hereon are oriented to NAD 27 New Mexico East Zone.

This description represents a survey made on the ground of a proposed EDS Line and intended solely for that purpose. This description does not represent a boundary survey.

PROPOSED EDS LINE		
COURSE	BEARING	DISTANCE
1	N 00° 32' 04" W	82.50

NOTE:


Please be advised, that while reasonable efforts are made to locate and verify pipelines and anomalies using our standard pipeline locating equipment, it is impossible to be 100 % effective. As such, we advise using caution when performing work as there is a possibility that pipelines and other hazards, such as fiber optic cables, PVC pipelines, etc. may exist undetected on site.

NOTE:

Many states maintain information centers that establish links between those who dig (excavators) and those who own and operate underground facilities (operators). It is advisable and in most states, law, for the contractor to contact the center for assistance in locating and marking underground utilities. For guidance, New Mexico One Call www.nmonecall.org

DISCLAIMER: At this time, C. H. Fenstermaker & Associates, L.L.C. has not performed nor was asked to perform any type of engineering, hydrological modeling, flood plain, or "No Rise" certification analyses, including but not limited to determining whether the project will impact flood hazards in connection with federal/FEMA, state, and/or local laws, ordinances and regulations. Accordingly, Fenstermaker makes no warranty or representation of any kind as to the foregoing issues, and persons or entities using this information shall do so at their own risk.

FOR THE EXCLUSIVE USE OF
CHEVRON U.S.A. INC.
I, Robert L. Lastrapes, Professional
Surveyor, do hereby state this plat is true
and correct to the best of my knowledge.

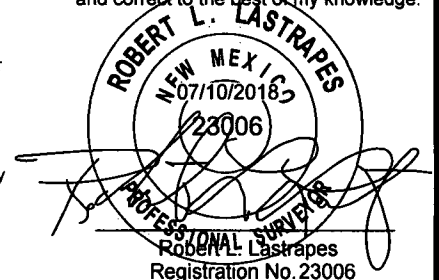

Page 2 of 2


EDS LINE PLAT

CHEVRON U.S.A. INC.
PROPOSED EDS LINE
COTTON DRAW CENTRAL TANK BATTERY
SECTION 15, T25S-R32E
LEA COUNTY, NEW MEXICO



C. H. Fenstermaker & Associates, L.L.C.
135 Regency Sq. Lafayette, LA 70508
Ph. 337-237-2200 Fax. 337-232-3299
www.fenstermaker.com

REVISIONS			
DRAWN BY:	#	BY:	DATE:
PROJ. MGR.: VHV	1	AMT	04/20/2018
DATE: 04/10/2018	2	AMT	06/29/2018
DESCRIPTION:			
Removed Access Road & Revised EDS Line.			
Revised the ROW, access, pads and eds line.			
FILENAME: T:\2018\2187194\DWG\Cotton Draw CTB_Sec 15_EDS Line.dwg			

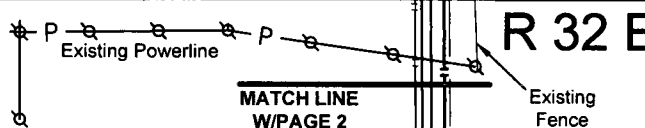

FOR THE EXCLUSIVE USE OF
CHEVRON U.S.A. INC.
I, Robert L. Lastrapes, Professional
Surveyor, do hereby state this plat is true
and correct to the best of my knowledge.

ROBERT L. LASTRAPES
NEW MEXICO
07/10/2018
23006
PROFESSIONAL SURVEYOR
Robert L. Lastrapes
Registration No. 23006

**T
25
S**
Sec. 10
Bureau of Land Management

**PROPOSED
FLOWLINE**
±9,917.10'
±601.04 Rods

LEGEND	
	Proposed Flowline
	Proposed ROW
	Proposed Pad/Access
	Existing Road/Pad
	Existing Fence
	Existing Pipeline
	Section Line
	Existing Powerline
	Power Pole
	Fnd. Monument
	Existing Water Well
	Existing P&A'd Well



Sec. 15
Bureau of Land Management

Proposed
Yeti Pad
Access Road

Existing Pipelines
Proposed 60' Wide ROW

Approximate
Archaeological Site

Proposed
CO Yeti 15 22 Fed Com
Nos. 0051H-0056H Pad

Point of Commencement/
Fnd. 2" Iron Pipe w/ Cap @
the NE Corner of Section 15

Existing
Pipeline

313'

331'

Existing
Fence

Existing
Road

Proposed 60'
Wide ROW

Existing
P&A'd Well

Existing Water
Well

Proposed
Access Road


S 61° 35' 26" W
1,259.06'

POINT OF BEGINNING
(NAD 27)
X= 709,248.38
Y= 413,863.04

FLOWLINE PLAT

Scale: 1" = 600'

Page 1 of 3

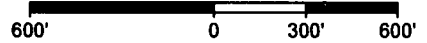

CHEVRON U.S.A. INC.
PROPOSED FLOWLINE
COTTON DRAW CENTRAL TANK BATTERY
SECTIONS 15, 10 & 3, T25S-R32E
LEA COUNTY, NEW MEXICO



C. H. Fenstermaker & Associates, L.L.C.
135 Regency Sq. Lafayette, LA 70508
Ph. 337-237-2200 Fax. 337-232-3299
www.fenstermaker.com

REVISIONS				
DRAWN BY:	#	BY:	DATE:	DESCRIPTION:
PROJ. MGR.: VHV	1	AMT	04/20/2018	Removed Access & 4H Well.
DATE: 04/10/2018	2	AMT	06/29/2018	Revised ROW, access, pads & flowline.
FILENAME: T:\2018\2187194\DWG\Cotton Draw CTB_Sec 15_Flowline.dwg				

R 32 E


POINT OF ENDING
(NAD 27)
X= 708,001.23
Y= 421,700.94

Sec. 3

Bureau of Land Management

Proposed Central
Tank Battery

FOR THE EXCLUSIVE USE OF
CHEVRON U.S.A. INC.
I, Robert L. Lastrapes, Professional
Surveyor, do hereby state this plat is true
and correct to the best of my knowledge.

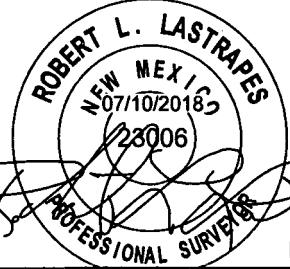

Robert L. Lastrapes
Registration No. 23006

Texaco
P & A'd Well

N 49° 56' 22" W 3,048.15'

Proposed 60' Wide ROW

Proposed
Compressor
Station

Existing Pipeline

Existing Powerline

Fnd. 2" Iron Pipe
w/ Cap @ the SE
Corner of Section 3

Proposed Grizzly Pad Access Road

PROPOSED
FLOWLINE
±9,917.10'
±601.04 Rods

Proposed
60' Wide
ROW

Existing
Fence

Sec. 10

Bureau of Land Management

Proposed
Yeti Pad
Access Road

Existing Powerline

MATCH LINE
W/PAGE 1

LEGEND

	Proposed Flowline
	Proposed ROW
	Proposed Pad/Access
	Existing Road
	Existing Fence
	Existing Pipeline
	Section Line
	Existing Powerline
	Power Pole
	Fnd. Monument
	P & A'd Well

FLOWLINE PLAT

Scale: 1" = 600'

600' 0 300' 600'

CHEVRON U.S.A. INC.
PROPOSED FLOWLINE
COTTON DRAW CENTRAL TANK BATTERY
SECTIONS 15, 10 & 3, T25S-R32E
LEA COUNTY, NEW MEXICO



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135 Regency Sq. Lafayette, LA 70508
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www.fenstermaker.com

REVISIONS

DRAWN BY: BOR	#	BY:	DATE:	DESCRIPTION:
PROJ. MGR.: VHV	1	AMT	04/20/2018	Removed Access & 4H Well.
DATE: 04/10/2018	2	AMT	06/29/2018	Revised ROW, access, pads & flowline.
FILENAME: T:\2018\2187194\DWG\Cotton Draw CTB_Sec 15_Flowline.dwg				

**METES AND BOUNDS DESCRIPTION OF
PROPOSED FLOWLINE
SECTIONS 15, 10 AND 3 OF TOWNSHIP 25 SOUTH RANGE 32 EAST
LEA COUNTY, NEW MEXICO**

Survey of a proposed flowline 9,917.10 feet or 601.04 rods crossing Bureau of Land Management land in Sections 15, 10 and 3 of Township 25 South Range 32 East, N.M.P.M. Lea County, New Mexico.

COMMENCING at a Found 2" Iron Pipe with Cap at the Northeast Corner of said Section 15; Thence South 61 degrees 35 minutes 26 seconds West 1,259.06 feet to the **POINT OF BEGINNING** having the following coordinates: X=709,248.38 and Y=413,863.04 (New Mexico State Plane Coordinate System, East Zone, NAD 27);

Thence North 00 degrees 32 minutes 04 seconds West 65.00 feet to a point;
Thence South 89 degrees 27 minutes 56 seconds West 1,621.25 feet to a point;
Thence North 00 degrees 03 minutes 33 seconds West 278.42 feet to a point;
Thence North 00 degrees 01 minutes 43 seconds West 255.29 feet to a point;
Thence North 01 degrees 06 minutes 34 seconds West 248.78 feet to a point;
Thence East 155.76 feet to a point;
Thence North 00 degrees 32 minutes 23 seconds West 4,752.18 feet to a point;
Thence South 89 degrees 58 minutes 59 seconds East 286.65 feet to a point;

Thence North 00 degrees 27 minutes 07 seconds West 2,253.77 feet to the **POINT OF ENDING** having the following coordinates: X=708,001.23 and Y=421,700.94 (New Mexico State Plane Coordinate System, East Zone, NAD 27)

The bearings recited hereon are oriented to NAD 27 New Mexico East Zone.

This description represents a survey made on the ground of a proposed flowline and intended solely for that purpose. This description does not represent a boundary survey.

PROPOSED FLOWLINE			PROPOSED FLOWLINE		
COURSE	BEARING	DISTANCE	COURSE	BEARING	DISTANCE
1	N 00° 32' 04" W	65.00'	6	EAST	155.76'
2	S 89° 27' 56" W	1621.25'	7	N 00° 32' 23" W	4752.18'
3	N 00° 03' 33" W	278.42'	8	S 89° 58' 59" E	286.65'
4	N 00° 01' 43" W	255.29'	9	N 00° 27' 07" W	2253.77'
5	N 01° 06' 34" W	248.78'			

NOTE:

Please be advised, that while reasonable efforts are made to locate and verify pipelines and anomalies using our standard pipeline locating equipment, it is impossible to be 100 % effective. As such, we advise using caution when performing work as there is a possibility that pipelines and other hazards, such as fiber optic cables, PVC pipelines, etc. may exist undetected on site.

NOTE:

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FOR THE EXCLUSIVE USE OF
CHEVRON U.S.A. INC.
I, Robert L. Lastrapes, Professional
Surveyor, do hereby state this plat is true
and correct to the best of my knowledge.



FLOWLINE PLAT

Page 3 of 3

**CHEVRON U.S.A. INC.
PROPOSED FLOWLINE
COTTON DRAW CENTRAL TANK BATTERY
SECTIONS 15, 10 & 3, T25S-R32E
LEA COUNTY, NEW MEXICO**



C. H. Fenstermaker & Associates, L.L.C.
135 Regency Sq. Lafayette, LA 70508
Ph. 337-237-2200 Fax. 337-232-3299
www.fenstermaker.com

REVISIONS				DESCRIPTION:
DRAWN BY:	#	BY:	DATE:	
PROJ. MGR.: VHV	1	AMT	04/20/2018	Removed Access & 4H Well.
DATE: 04/10/2018	2	AMT	06/29/2018	Revised ROW, access, pads & flowline.
FILENAME: T:\2018\2187194\DWG\Cotton Draw CTB_Sec 15_Flowline.dwg				

T24S-32E
T25S-32E

Flowline
Gathering Line
Gas Lift Line
Water Line
Electric Line
ROW/Access Edge

Sec 3

Sec 4

Sec 2

Sec 9


Sec 10

Sec 11

Sec 16

Sec 15

FOR THE EXCLUSIVE USE OF
CHEVRON U.S.A. INC.
I, Robert L. Lastrapes, Professional
Surveyor, do hereby state this plat is true
and correct to the best of my knowledge.

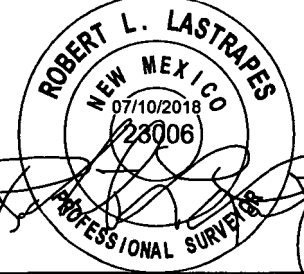

Robert L. Lastrapes
Registration No. 23006

AERIAL DETAIL

Scale: 1" = 2000'

2000' 0 1000' 2000'


CHEVRON U.S.A. INC.
WORK AREA DETAIL FOR THE
COTTON DRAW YETI PAD AND FACILITIES
SECTIONS 3, 9 & 10 & 15, T25S-R32E
LEA COUNTY, NEW MEXICO



C. H. Fenstermaker & Associates, L.L.C.
135 Regency Sq. Lafayette, LA 70508
Ph. 337-237-2200 Fax. 337-232-3299
www.fenstermaker.com

REVISIONS

DRAWN BY:	BOR	#	BY:	DATE:	DESCRIPTION:
PROJ. MGR.:	VHV	3	BOR	05/23/2018	Added liquid gathering line.Changed satellite to CTB.
DATE:	04/12/2018	4	BOR	06/29/2018	Revised ROW, access & lines.
FILENAME: T:\2018\2187192\DWG\Cotton Draw Yeti Pad and Facilities_AerialDetail.dwg					

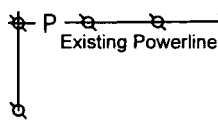


MATCH LINE
W/PAGE 2

Existing Road

R 32 E

Existing Fence

FOR THE EXCLUSIVE USE OF
CHEVRON U.S.A. INC.
I, Robert L. Lastrapes, Professional
Surveyor, do hereby state this plat is true
and correct to the best of my knowledge.

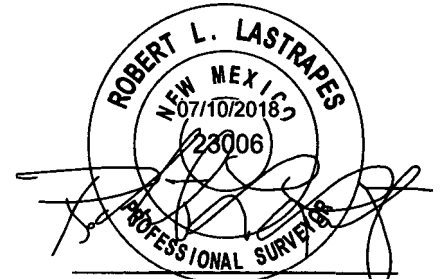

Robert L. Lastrapes
Registration No. 23006

T
25
S

Sec. 10

Bureau of Land Management

PROPOSED
GATHERING LINE
±9,917.22'
±601.04 Rods

Existing Pipelines

Proposed 60' Wide ROW

LEGEND

- Proposed Gathering Line
- Proposed ROW
- Proposed Pad/Access
- - - Existing Road/Pad
- X- Existing Fence
- + - Existing Pipeline
- - - Section Line
- P - Existing Powerline
- Power Pole
- Fnd. Monument
- Existing Water Well
- ✱ Existing P&A'd Well

Proposed
Yeti Pad
Access Road

Proposed
CO Yeti 15 22 Fed Com
Nos. 0051H-0056H Pad

Point of Commencement/
Fnd. 2" Iron Pipe w/ Cap @
the NE Corner of Section 15

Approximate
Archaeological Site

Sec. 15

Bureau of Land Management

Existing Pipeline

Existing Fence

Existing Road

Proposed 60'
Wide ROW

S 61° 41' 47" W
1,263.48'

POINT OF
BEGINNING
(NAD 27)

X= 709,243.38
Y= 413,862.99

Existing
P&A'd Well

Existing Water
Well

Proposed
CTB

GATHERING LINE

Scale: 1" = 600'

600' 0 300' 600'

Page 1 of 3

CHEVRON U.S.A. INC. PROPOSED GATHERING LINE COTTON DRAW CENTRAL TANK BATTERY SECTIONS 15, 10 & 3, T25S-R32E LEA COUNTY, NEW MEXICO



C. H. Fenstermaker & Associates, L.L.C.
135 Regency Sq. Lafayette, LA 70508
Ph. 337-237-2200 Fax. 337-232-3299
www.fenstermaker.com

REVISIONS


DRAWN BY:	AMT	#	BY:	DATE:	DESCRIPTION:
PROJ. MGR.:	VHV	1	AMT	06/29/2018	Revised ROW, access, pad & gathering line.
DATE:	05/23/2018				
FILENAME: T:\2018\2187194\DWG\Cotton Draw CTB_Sec 15_Liquid Gathering Line.dwg					

R 32 E

POINT OF ENDING
(NAD 27)
X= 707,996.23
Y= 421,700.90

Proposed Central
Tank Battery

FOR THE EXCLUSIVE USE OF
CHEVRON U.S.A. INC.
I, Robert L. Lastrapes, Professional
Surveyor, do hereby state this plat is true
and correct to the best of my knowledge.

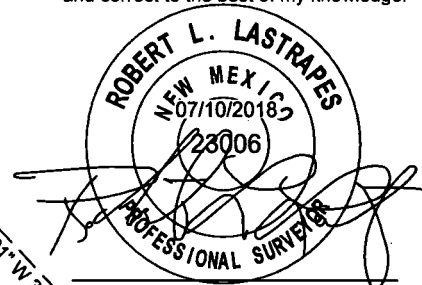

Robert L. Lastrapes
Registration No. 23006

Sec. 3

Bureau of Land Management

T
25
S

Existing Pipelines

Proposed 60' Wide ROW

Texaco
P & A'd Well

N 49° 49' 01" W 3,040.55'

Proposed
Compressor
Station

Existing Pipeline

Existing Powerline

Proposed Grizzly Pad Access Road

PROPOSED
GATHERING LINE
±9,917.22'
±601.04 Rods

Proposed
60' Wide
ROW

Existing
Fence

Sec. 10

Bureau of Land Management

Proposed
Yeti Pad
Access Road

Existing Powerline

MATCH LINE
W/PAGE 1

Fnd. 2" Iron Pipe w/
Cap @ the SE
Corner of Section 3

LEGEND

	Proposed Gathering Line
	Proposed ROW
	Proposed Pad/Access
	Existing Road
	Existing Fence
	Existing Pipeline
	Section Line
	Existing Powerline
	Power Pole
	Fnd. Monument
	P & A'd Well

Scale: 1" = 600'

600' 0 300' 600'

GATHERING LINE

Page 2 of 3

CHEVRON U.S.A. INC.
PROPOSED GATHERING LINE
COTTON DRAW CENTRAL TANK BATTERY
SECTIONS 15, 10 & 3, T25S-R32E
LEA COUNTY, NEW MEXICO



C. H. Fenstermaker & Associates, L.L.C.
135 Regency Sq. Lafayette, LA 70508
Ph. 337-237-2200 Fax. 337-232-3299
www.fenstermaker.com

REVISIONS

DRAWN BY:	AMT	#	BY:	DATE:	DESCRIPTION:
PROJ. MGR.:	VHV	1	AMT	06/29/2018	Revised ROW, access, pad & gathering line.
DATE:	05/23/2018				
FILENAME: T:\2018\2187194\DWG\Cotton Draw CTB_Sec 15_Liquid Gathering Line.dwg					

**METES AND BOUNDS DESCRIPTION OF
PROPOSED GATHERING LINE
SECTIONS 15, 10 AND 3 OF TOWNSHIP 25 SOUTH RANGE 32 EAST
LEA COUNTY, NEW MEXICO**

Survey of a proposed gathering line 9,917.22 feet or 601.04 rods crossing Bureau of Land Management land in Sections 15, 10 and 3 of Township 25 South Range 32 East, N.M.P.M. Lea County, New Mexico.

COMMENCING at a Found 2" Iron Pipe with Cap at the Northeast Corner of said Section 15; Thence South 61 degrees 41 minutes 47 seconds West 1,263.48 feet to the **POINT OF BEGINNING** having the following coordinates: X=709,243.38 and Y=413,862.99 (New Mexico State Plane Coordinate System, East Zone, NAD 27);

Thence North 00 degrees 32 minutes 04 seconds West 60.00 feet to a point;
Thence South 89 degrees 27 minutes 56 seconds West 1,621.29 feet to a point;
Thence North 00 degrees 03 minutes 33 seconds West 283.46 feet to a point;
Thence North 00 degrees 01 minutes 43 seconds West 255.25 feet to a point;
Thence North 01 degrees 06 minutes 34 seconds West 253.83 feet to a point;
Thence East 155.82 feet to a point;
Thence North 00 degrees 32 minutes 23 seconds West 4,752.18 feet to a point;
Thence South 89 degrees 58 minutes 59 seconds East 286.66 feet to a point

Thence North 00 degrees 27 minutes 07 seconds West 2,248.73 feet to the **POINT OF ENDING** having the following coordinates: X=707,996.23 and Y=421,700.90 (New Mexico State Plane Coordinate System, East Zone, NAD 27)

The bearings recited hereon are oriented to NAD 27 New Mexico East Zone.

This description represents a survey made on the ground of a proposed gathering line and intended solely for that purpose. This description does not represent a boundary survey.

PROPOSED GATHERING LINE			PROPOSED GATHERING LINE		
COURSE	BEARING	DISTANCE	COURSE	BEARING	DISTANCE
1	N 00° 32' 04" W	60.00'	6	EAST	155.82'
2	S 89° 27' 56" W	1621.29'	7	N 00° 32' 23" W	4752.18'
3	N 00° 03' 33" W	283.46'	8	S 89° 58' 59" E	286.66'
4	N 00° 01' 43" W	255.25'	9	N 00° 27' 07" W	2248.73'
5	N 01° 06' 34" W	253.83'			

NOTE:


Please be advised, that while reasonable efforts are made to locate and verify pipelines and anomalies using our standard pipeline locating equipment, it is impossible to be 100 % effective. As such, we advise using caution when performing work as there is a possibility that pipelines and other hazards, such as fiber optic cables, PVC pipelines, etc. may exist undetected on site.

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FOR THE EXCLUSIVE USE OF
CHEVRON U.S.A. INC.
I, Robert L. Lastrapes, Professional
Surveyor, do hereby state this plat is true
and correct to the best of my knowledge.


Robert L. Lastrapes
Registration No. 23006

GATHERING LINE

Page 3 of 3

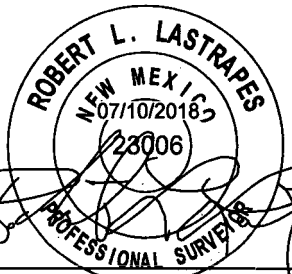**CHEVRON U.S.A. INC.
PROPOSED GATHERING LINE
COTTON DRAW CENTRAL TANK BATTERY
SECTIONS 15, 10 & 3, T25S-R32E
LEA COUNTY, NEW MEXICO**



C. H. Fenstermaker & Associates, L.L.C.
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Ph. 337-237-2200 Fax. 337-232-3299
www.fenstermaker.com


REVISIONS

DRAWN BY:	AMT	#	BY:	DATE:	DESCRIPTION:
PROJ. MGR.:	VHV	1	AMT	06/29/2018	Revised ROW, access, pad & gathering line.
DATE:	05/23/2018				
FILENAME: T:\2018\2187194\DWG\Cotton Draw Satellite Pad_Sec 15_Liquid Gathering Line.dwg					

R 32 E
Sec. 10

Bureau of Land Management

Fnd. 2" Iron Pipe
w/ Cap @ NE Corner
of Section 15

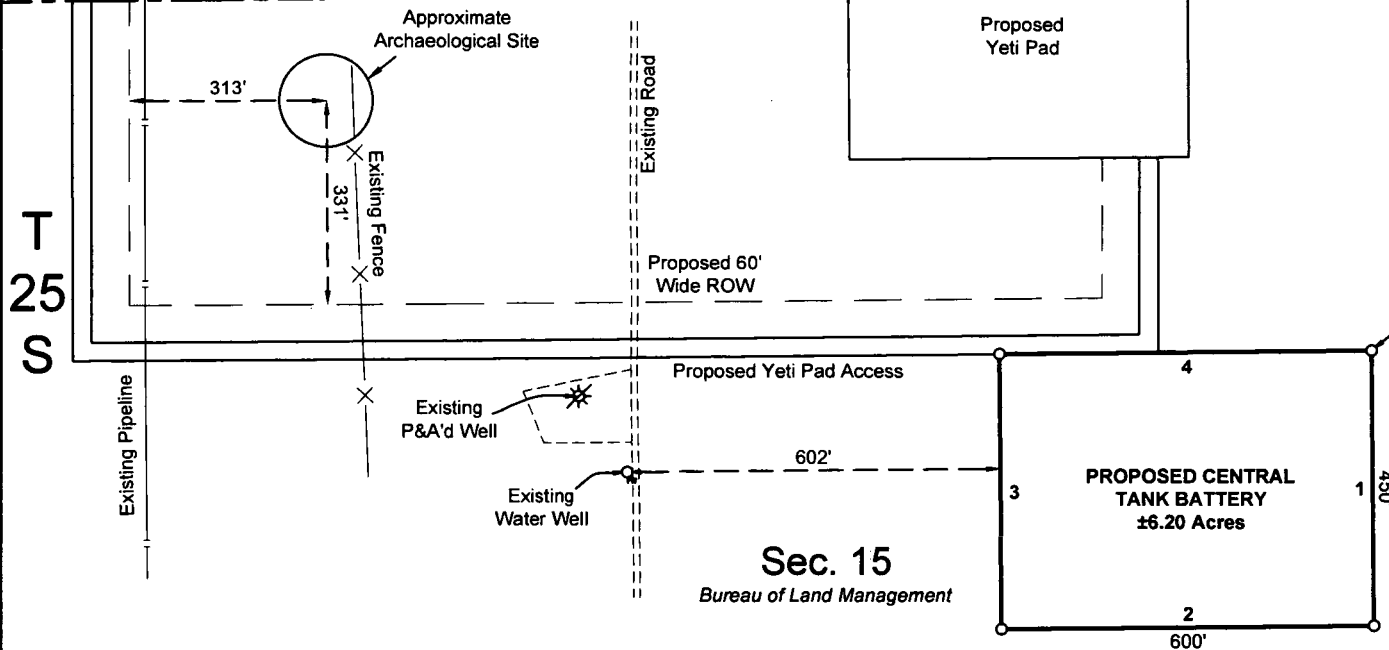

Sec. 15

Bureau of Land Management

LEGEND


- Proposed Pad/Access/CTB
- Existing Pipeline
- Proposed ROW
- Existing Fence
- Existing Road
- Existing P&A'd Well
- Existing Water Well
- Found Monument

Scale: 1" = 300'

300' 0 150' 300'

FOR THE EXCLUSIVE USE OF
CHEVRON U.S.A. INC.

I, Robert L. Lastrapes, Professional
Surveyor, do hereby state this plat is true
and correct to the best of my knowledge.

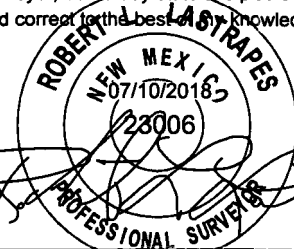

Robert L. Lastrapes
Registration No. 23006

SURFACE USE PLAT

Page 1 of 2

CHEVRON U.S.A. INC.

PROPOSED PAD
COTTON DRAW CENTRAL TANK BATTERY
SECTION 15, T25S-R32E
LEA COUNTY, NEW MEXICO

REVISIONS

DRAWN BY:	#	BY:	DATE:	DESCRIPTION:
PROJ. MGR.: VHV	2	AMT	05/23/2018	Enlarged CTB.
DATE: 03/09/2018	3	BOR	05/31/2018	Revised CTB, access road & ROW.
FILENAME: T:\2018\2187194\DWG\Cotton Draw CTB_Sec 15_SUP.dwg				



C. H. Fenstermaker & Associates, L.L.C.
135 Regency Sq. Lafayette, LA 70508
Ph. 337-237-2200 Fax. 337-232-3299
www.fenstermaker.com

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NW PAD CORNER			NE PAD CORNER		
X=	709,053	NAD 27	X=	709,653	NAD 27
Y=	413,861		Y=	413,867	
SW PAD CORNER			SE PAD CORNER		
X=	709,058	NAD 27	X=	709,658	NAD 27
Y=	413,411		Y=	413,417	

PROPOSED CENTRAL TANK BATTERY		
COURSE	BEARING	DISTANCE
1	S 00° 32' 04" E	450.00'
2	S 89° 27' 56" W	600.00'
3	N 00° 32' 04" W	450.00'
4	N 89° 27' 56" E	600.00'

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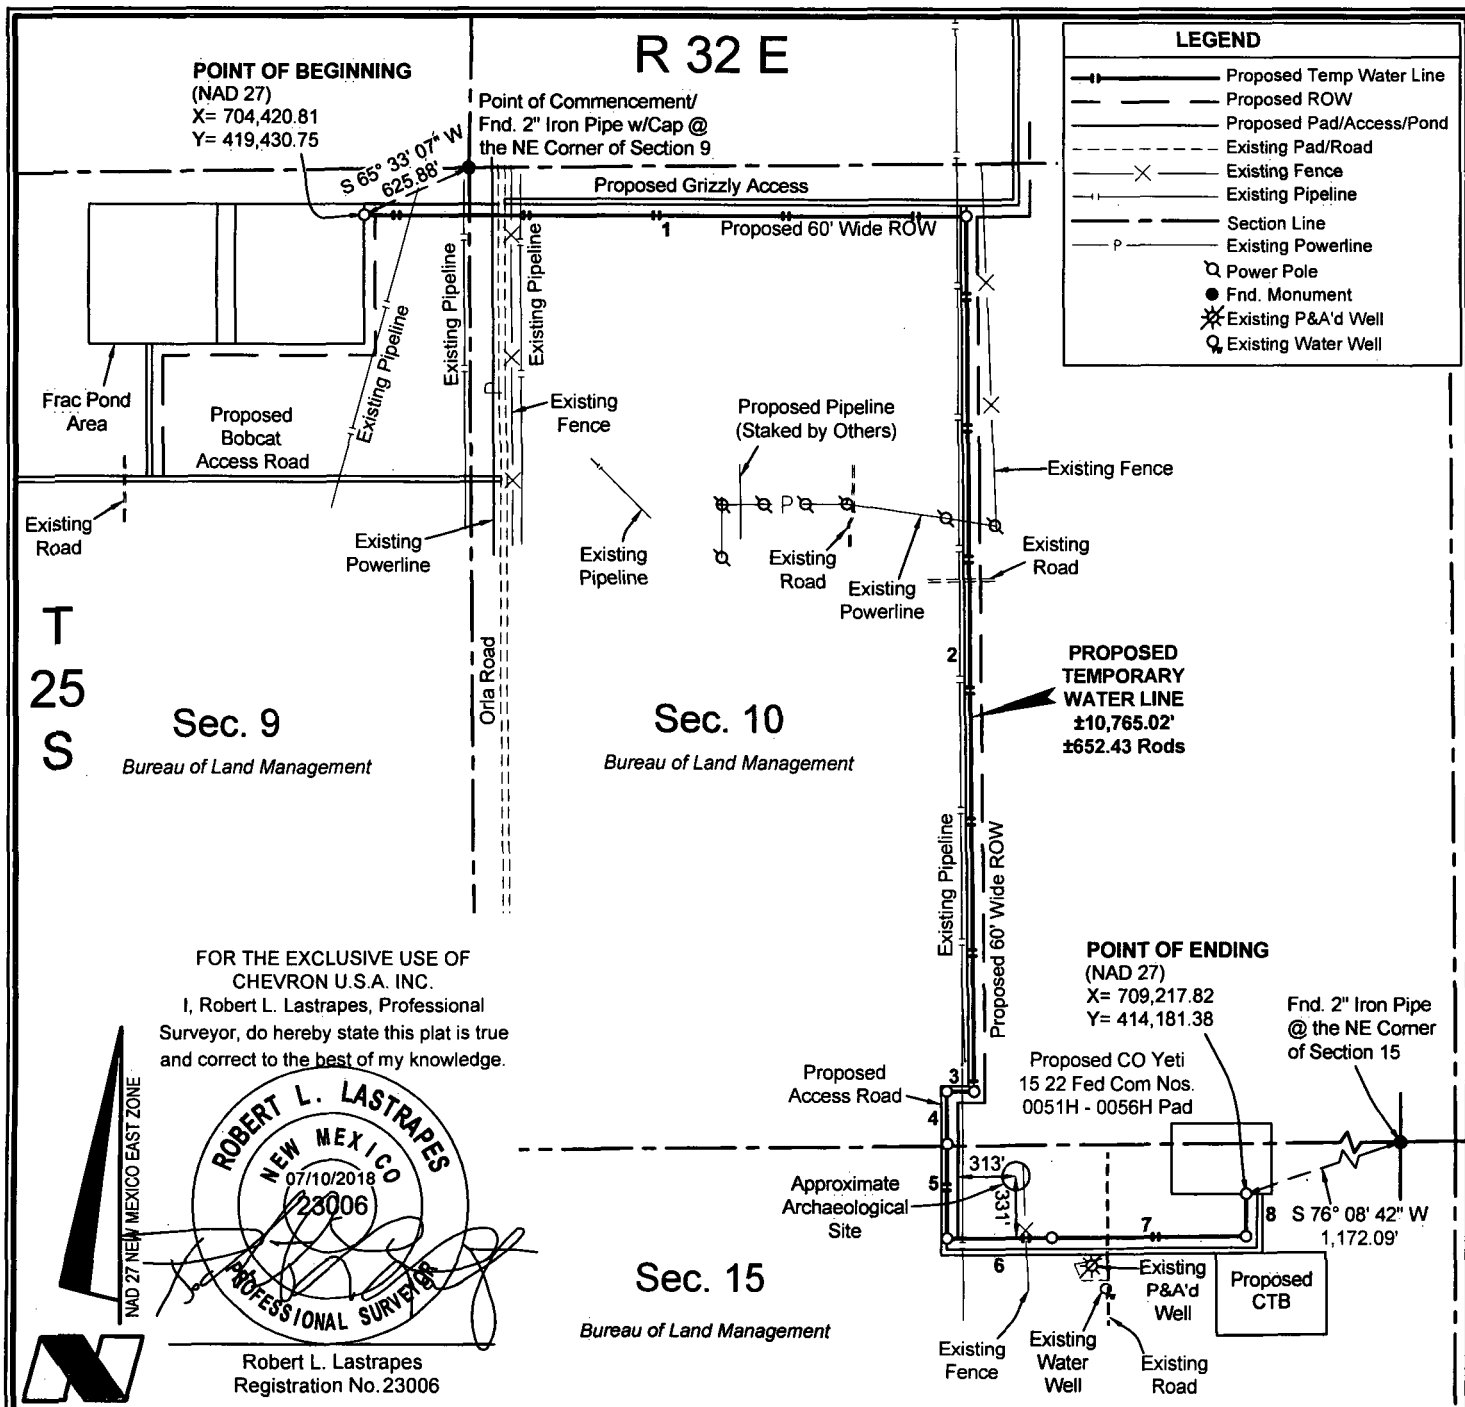
SURFACE USE PLAT

Page 2 of 2

CHEVRON U.S.A. INC.
PROPOSED PAD
COTTON DRAW CENTRAL TANK BATTERY
SECTION 15, T25S-R32E
LEA COUNTY, NEW MEXICO

REVISIONS

DRAWN BY:	#	BY:	DATE:	DESCRIPTION:
PROJ. MGR.: VHV	2	AMT	05/23/2018	Enlarged CTB.
DATE: 03/09/2018	3	BOR	05/31/2018	Revised CTB, access road & ROW.
FILENAME: T:\2018\2187194\DWG\Cotton Draw CTB_Sec 15_SUP.dwg				



Page 1 of 2

CHEVRON U.S.A. INC.
PROPOSED TEMPORARY WATER LINE
CO YETI 15 22 FED COM NOS. 0051H - 0056H WELLS
SECTIONS 9, 10 & 15, T25S-R32E
LEA COUNTY, NEW MEXICO



C. H. Fenstermaker & Associates, L.L.C.
135 Regency Sq. Lafayette, LA 70508
Ph. 337-237-2200 Fax. 337-232-3299
www.fenstermaker.com

REVISIONS				
DRAWN BY:	#	BY:	DATE:	DESCRIPTION:
PROJ. MGR.: VHV	2	DMB	05/02/2018	Revised temporary water line route.
DATE: 04/04/2018	3	AMT	06/28/2018	Revised temporary water line route.
FILENAME: T:20182187192DWG\CO Yeti 15 22 Fed Com 0051H-0056H_Temp Water Line.dwg				

**METES AND BOUNDS DESCRIPTION OF
PROPOSED TEMPORARY WATER LINE
SECTIONS 9, 10 AND 15 OF TOWNSHIP 25 SOUTH RANGE 32 EAST
LEA COUNTY, NEW MEXICO**

Survey of a proposed temporary water line 10,765.02 feet or 652.43 rods crossing Bureau of Land Management land in Sections 9, 10 and 15 of Township 25 South Range 32 East, N.M.P.M. Lea County, New Mexico.

COMMENCING at a Found 2" Iron Pipe with Cap at the Northeast Corner of said Section 9; Thence South 65 degrees 33 minutes 07 seconds West 625.88 feet to the **POINT OF BEGINNING** having the following coordinates: X=704,420.81 and Y=419,430.75 (New Mexico State Plane Coordinate System, East Zone, NAD 27);

Thence North 89 degrees 59 minutes 43 seconds East 3,269.29 feet to a point;
Thence South 00 degrees 32 minutes 17 seconds East 4,700.87 feet to a point;
Thence West 148.43 feet to a point;
Thence South 01 degrees 04 minutes 45 seconds East 284.14 feet to a point;
Thence South 00 degrees 02 minutes 38 seconds East 507.35 feet to a point;
Thence North 89 degrees 36 minutes 03 seconds East 569.34 feet to a point;
Thence North 89 degrees 27 minutes 56 seconds East 1,056.97 feet to a point;
Thence North 228.63 feet to the **POINT OF ENDING** having the following coordinates: X=709,217.82 and Y=414,181.38 (New Mexico State Plane Coordinate System, East Zone, NAD 27)


The bearings recited hereon are oriented to NAD 27 New Mexico East Zone.

This description represents a survey made on the ground of a proposed temporary water line and intended solely for that purpose. This description does not represent a boundary survey.

PROPOSED TEMPORARY WATER LINE		
COURSE	BEARING	DISTANCE
1	N 89° 59' 43" E	3269.29'
2	S 00° 32' 17" E	4700.87'
3	WEST	148.43'
4	S 01° 04' 45" E	284.14'
5	S 00° 02' 38" E	507.35'
6	N 89° 36' 03" E	569.34'
7	N 89° 27' 56" E	1056.97'
8	NORTH	228.63'

FOR THE EXCLUSIVE USE OF
CHEVRON U.S.A. INC.

I, Robert L. Lastrapes, Professional
Surveyor, do hereby state this plat is true
and correct to the best of my knowledge.

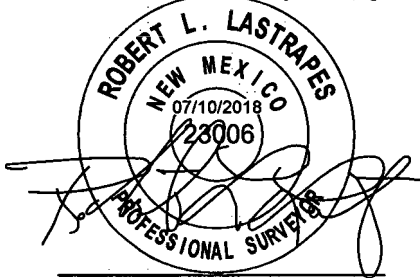

Robert L. Lastrapes
Registration No. 23006

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TEMPORARY WATER LINE PLAT

Page 2 of 2

CHEVRON U.S.A. INC.
PROPOSED TEMPORARY WATER LINE
CO YETI 15 22 FED COM NOS. 0051H - 0056H WELLS
SECTIONS 9, 10 & 15, T25S-R32E
LEA COUNTY, NEW MEXICO



C. H. Fenstermaker & Associates, L.L.C.
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www.fenstermaker.com

REVISIONS				
DRAWN BY:	#	BY:	DATE:	DESCRIPTION:
PROJ. MGR.: VHV	2	DMB	05/02/2018	Revised temporary water line route.
DATE: 04/04/2018	3	AMT	06/28/2018	Revised temporary water line route.
FILENAME: T:\2018\2187192\DWG\CO Yeti 15 22 Fed Com 0051H-0056H_Temp Water Line.dwg				


R 32 E
Sec. 10

Bureau of Land Management

CO YETI 15 22 FED COM
NO. 0055H WELL

X=	709,121	NAD 27
Y=	414,440	
LAT.	32.137610 N	
LONG.	103.657735 W	
X=	750,306	NAD83/2011
Y=	414,498	
LAT.	32.137734 N	
LONG.	103.658211 W	
ELEV.	+3,452'	NAVD88

T
25
S

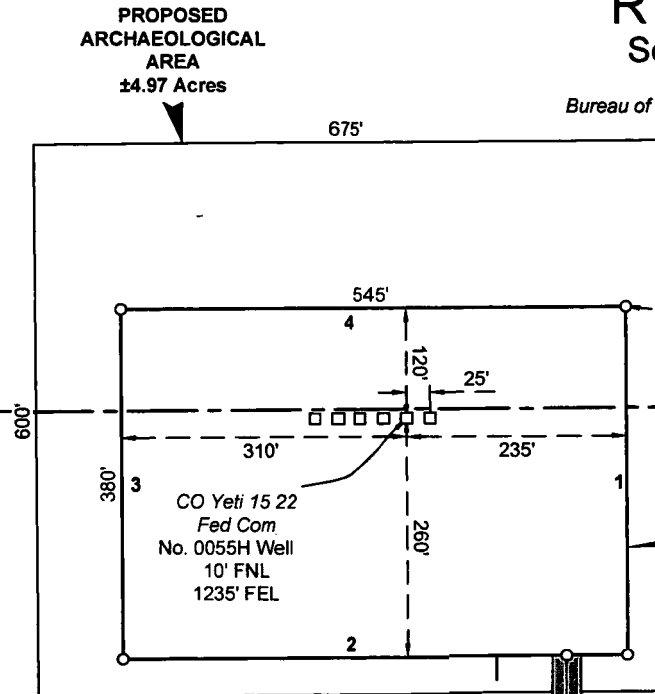

PROPOSED PAD
±4.75 Acres

Sec. 15

Bureau of Land Management

PROPOSED 60' WIDE ROW CONTAINING
3 FLOWLINES, 2 GAS LIFT LINES,
TEMPORARY WATER LINE & EDS LINE
±8,348.99', ±506.00 Rods

CENTERLINE
PROPOSED
ACCESS ROAD
30' x 17,793.43'
±472.33 Rods
±5.37 Acres

LEGEND

	Proposed Pad
	CL Proposed Access Road
	Section Line
	Proposed ROW
	Fnd. Monument

FOR THE EXCLUSIVE USE OF
CHEVRON U.S.A. INC.
I, Robert L. Lastrapes, Professional
Surveyor, do hereby state this plat is true
and correct to the best of my knowledge.



Robert L. Lastrapes
Registration No. 23006

Page 1 of 3

CHEVRON U.S.A. INC.
PROPOSED PAD & ACCESS ROAD
CO YETI 15 22 FED COM NO. 0055H WELL
SECTIONS 10 & 15, T25S-R32E
LEA COUNTY, NEW MEXICO

REVISIONS

DRAWN BY:	#	BY:	DATE:	DESCRIPTION:
PROJ. MGR.: VHV				
DATE: 06/26/2018				

FILENAME: T:\2018\2187192\DWG\CO Yeti 15 22 Fed Com 0055H_Well Plat.dwg



NAD 27 NEW MEXICO EAST ZONE

Scale: 1" = 200'

200' 0 100' 200'



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R 32 E

Sec. 3

Bureau of Land Management

Proposed
Compressor
Station

Sec. 2

LEGEND

- Proposed Pad
- CL Proposed Access Road
- Section Line
- Proposed ROW
- Existing Pipeline
- Existing Fence
- Existing Road
- Existing Powerline
- Existing Water Well
- Fnd. Monument
- Power Pole
- Existing P&A'd Well

Orla Road

Proposed Grizzly Access Road

Existing
Pipelines

Existing
Fence

Proposed Bobcat Pipeline ROW

Existing Powerline


Existing
2-Tract
Road

Sec. 10

14 Bureau of Land Management

Sec. 11

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Registration No. 23006

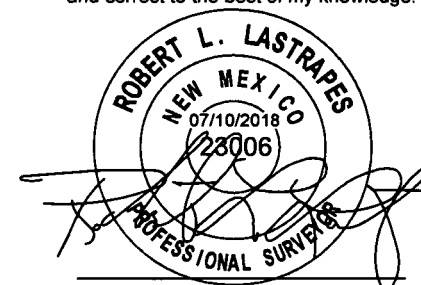CENTERLINE
PROPOSED
ACCESS ROAD
30' x $\pm 7,793.43'$
 ± 472.33 Rods
 ± 5.37 Acres

PROPOSED 60' WIDE
ROW CONTAINING 3
FLOWLINES, 2 GAS LIFT
LINES, TEMPORARY
WATER LINE & EDS LINE
 $\pm 8,348.99'$, ± 506.00 Rods

Approximate
Archaeological
Site

SEE
PAGE 1

Existing
Pipeline

Existing
Road

Existing
Fence

Proposed
CTB

Existing
P&A'd Well

Existing
Water Well

Sec. 15

Bureau of Land Management

Page 2 of 3

CHEVRON U.S.A. INC.
PROPOSED PAD & ACCESS ROAD
CO YETI 15 22 FED COM NO. 0055H WELL
SECTIONS 10 & 15, T25S-R32E
LEA COUNTY, NEW MEXICO

REVISIONS

DRAWN BY:	#	BY:	DATE:	DESCRIPTION:
PROJ. MGR.: VHV				
DATE: 06/26/2018				

FILENAME: T:\2018\2187192\DWG\CO Yeti 15 22 Fed Com 0055H_Well Plat.dwg



C. H. Fenstermaker & Associates, L.L.C.
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Scale: 1" = 1000'

1000' 0 500' 1000'

NAD 27 NEW MEXICO EAST ZONE

**T
25
S**

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PROPOSED PAD		
COURSE	BEARING	DISTANCE
1	S 00° 26' 34" E	380.00'
2	S 89° 33' 26" W	545.00'
3	N 00° 26' 34" W	380.00'
4	N 89° 33' 26" E	545.00'

CENTERLINE PROPOSED ACCESS ROAD		
COURSE	BEARING	DISTANCE
5	SOUTH	303.05'
6	S 89° 27' 56" W	1056.28'
7	S 89° 36' 03" W	659.62'
8	N 00° 23' 57" W	57.11'
9	N 00° 03' 33" W	270.17'
10	N 00° 01' 43" W	254.85'
11	N 01° 06' 34" W	261.09'
12	N 00° 44' 07" W	38.19'
13	EAST	148.48'
14	N 00° 32' 17" W	4744.59'

NW ARCH. AREA CORNER		NE ARCH. AREA CORNER	
X=	708,718 NAD 27	X=	709,393 NAD 27
Y=	414,736	Y=	414,743
LAT.	32.138431	LAT.	32.138437
LONG.	103.659030	LONG.	103.656849
X=	749,903 NAD83	X=	750,578 NAD83
Y=	414,794	Y=	414,801
LAT.	32.138555	LAT.	32.138561
LONG.	103.659506	LONG.	103.657325
SW ARCH. AREA CORNER		SE ARCH. AREA CORNER	
X=	708,724 NAD 27	X=	709,399 NAD 27
Y=	414,136	Y=	414,143
LAT.	32.136781	LAT.	32.136788
LONG.	103.659023	LONG.	103.656843
X=	749,909 NAD83	X=	750,584 NAD83
Y=	414,194	Y=	414,201
LAT.	32.136906	LAT.	32.136912
LONG.	103.659499	LONG.	103.657318

NW PAD CORNER		NE PAD CORNER	
X=	708,810 NAD 27	X=	709,355 NAD 27
Y=	414,558	Y=	414,562
LAT.	32.137938	LAT.	32.137940
LONG.	103.658736	LONG.	103.656976
X=	749,995 NAD83	X=	750,540 NAD83
Y=	414,616	Y=	414,620
LAT.	32.138063	LAT.	32.138065
LONG.	103.659212	LONG.	103.657451
SW PAD CORNER		SE PAD CORNER	
X=	708,813 NAD 27	X=	709,358 NAD 27
Y=	414,178	Y=	414,182
LAT.	32.136894	LAT.	32.136896
LONG.	103.658735	LONG.	103.656974
X=	749,998 NAD83	X=	750,543 NAD83
Y=	414,236	Y=	414,240
LAT.	32.137018	LAT.	32.137020
LONG.	103.659210	LONG.	103.657449

FOR THE EXCLUSIVE USE OF
CHEVRON U.S.A. INC.
I, Robert L. Lastrapes, Professional
Surveyor, do hereby state this plat is true
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Robert L. Lastrapes
Registration No. 23006



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CHEVRON U.S.A. INC.
PROPOSED PAD & ACCESS ROAD
CO YETI 15 22 FED COM NO. 0055H WELL
SECTIONS 10 & 15, T25S-R32E
LEA COUNTY, NEW MEXICO


REVISIONS				
DRAWN BY:	#	BY:	DATE:	DESCRIPTION:
PROJ. MGR.: VHV				
DATE: 06/26/2018				
FILENAME: T:\2018\2187192\DWG\ICO Yeti 15 22 Fed Com 0055H_Well Plat.dwg				

R 32 E

Sec. 10

Bureau of Land Management

T
25
S

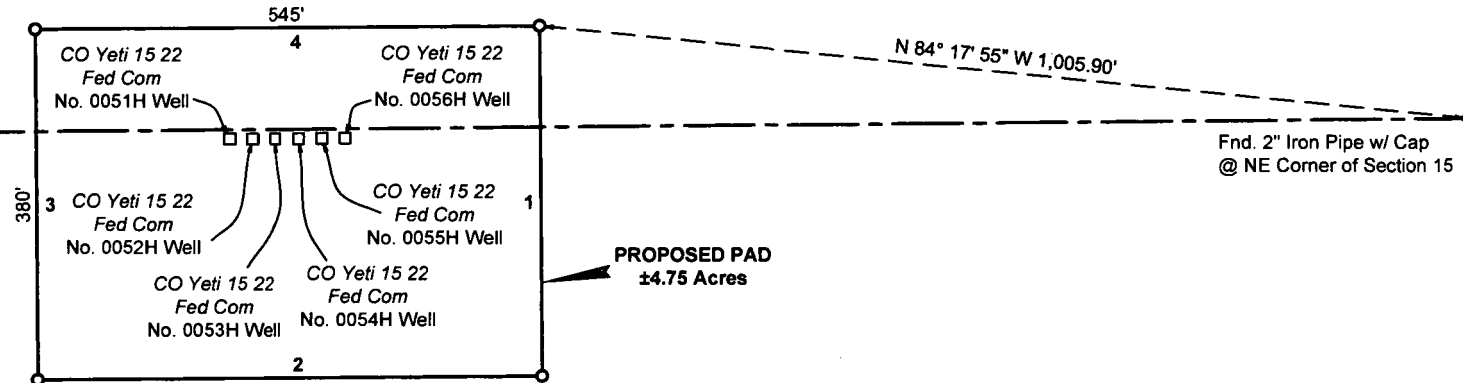

Sec. 15

Bureau of Land Management

NAD 27 NEW MEXICO EAST ZONE


LEGEND	
	Proposed Pad
	Section Line
	Fnd. Monument

Scale: 1" = 200'

200' 0 100' 200'

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PAD PLAT

Page 1 of 2

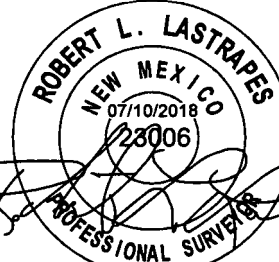CHEVRON U.S.A. INC.

PROPOSED PAD

CO YETI 15 22 FED COM NOS. 0051H-0056H WELLS
SECTIONS 10 & 15, T25S-R32E
LEA COUNTY, NEW MEXICO

REVISIONS

DRAWN BY:	#	BY:	DATE:	DESCRIPTION:
DMB	2	DMB	04/18/2018	Removed 4H well.
DATE: 01/11/2018	3	BOR	05/23/2018	Expanded pad & added 3 wells.
FILENAME: T:\2018\2187192\DWG\CO Yeti 15 22 Fed Com 0051H-0056H_Pad Plat.dwg				



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NW PAD CORNER			NE PAD CORNER		
X=	708,810	NAD 27	X=	709,355	NAD 27
Y=	414,558		Y=	414,562	
LAT.	32.137938		LAT.	32.137940	
LONG.	103.658736		LONG.	103.656976	
X=	749,995	NAD83	X=	750,540	NAD83
Y=	414,616		Y=	414,620	
LAT.	32.138063		LAT.	32.138065	
LONG.	103.659212		LONG.	103.657451	
SW PAD CORNER			SE PAD CORNER		
X=	708,813	NAD 27	X=	709,358	NAD 27
Y=	414,178		Y=	414,182	
LAT.	32.136894		LAT.	32.136896	
LONG.	103.658735		LONG.	103.656974	
X=	749,998	NAD83	X=	750,543	NAD83
Y=	414,236		Y=	414,240	
LAT.	32.137018		LAT.	32.137020	
LONG.	103.659210		LONG.	103.657449	

PROPOSED PAD		
COURSE	BEARING	DISTANCE
1	S 00° 26' 34" E	380.00'
2	S 89° 33' 26" W	545.00'
3	N 00° 26' 34" W	380.00'
4	N 89° 33' 26" E	545.00'

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I, Robert L. Lastrapes, Professional
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Robert L. Lastrapes
Registration No. 23006

PAD PLAT

Page 2 of 2

CHEVRON U.S.A. INC.
PROPOSED PAD
CO YETI 15 22 FED COM NOS. 0051H-0056H WELLS
SECTIONS 10 & 15, T25S-R32E
LEA COUNTY, NEW MEXICO

REVISIONS

DRAWN BY:	#	BY:	DATE:	DESCRIPTION:
DMB				
PROJ. MGR.:	VHV	2	DMB 04/18/2018	Removed 4H well.
DATE:	01/11/2018	3	BOR 05/23/2018	Expanded pad & added 3 wells.
FILENAME: T:\2018\2187192\DWG\CO Yeti 15 22 Fed Com 0051H-0056H_Pad Plat.dwg				



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LEGEND

- Proposed EDS Line
- Proposed ROW
- Proposed Pad/Access
- Existing Road
- Existing Fence
- Existing Pipeline
- Section Line
- Existing Powerline
- Power Pole
- Fnd. Monument
- Existing P&A'd Well
- Existing Water Well

T
25
S


Sec. 9

Bureau of Land Management

Sec. 10


Bureau of Land Management

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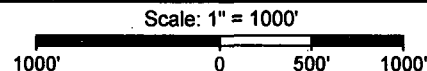
R 32 E

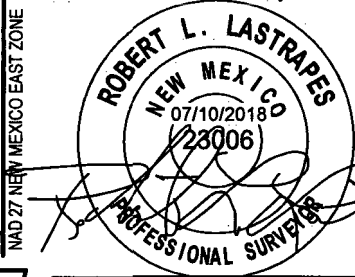

Sec. 15

Bureau of Land Management

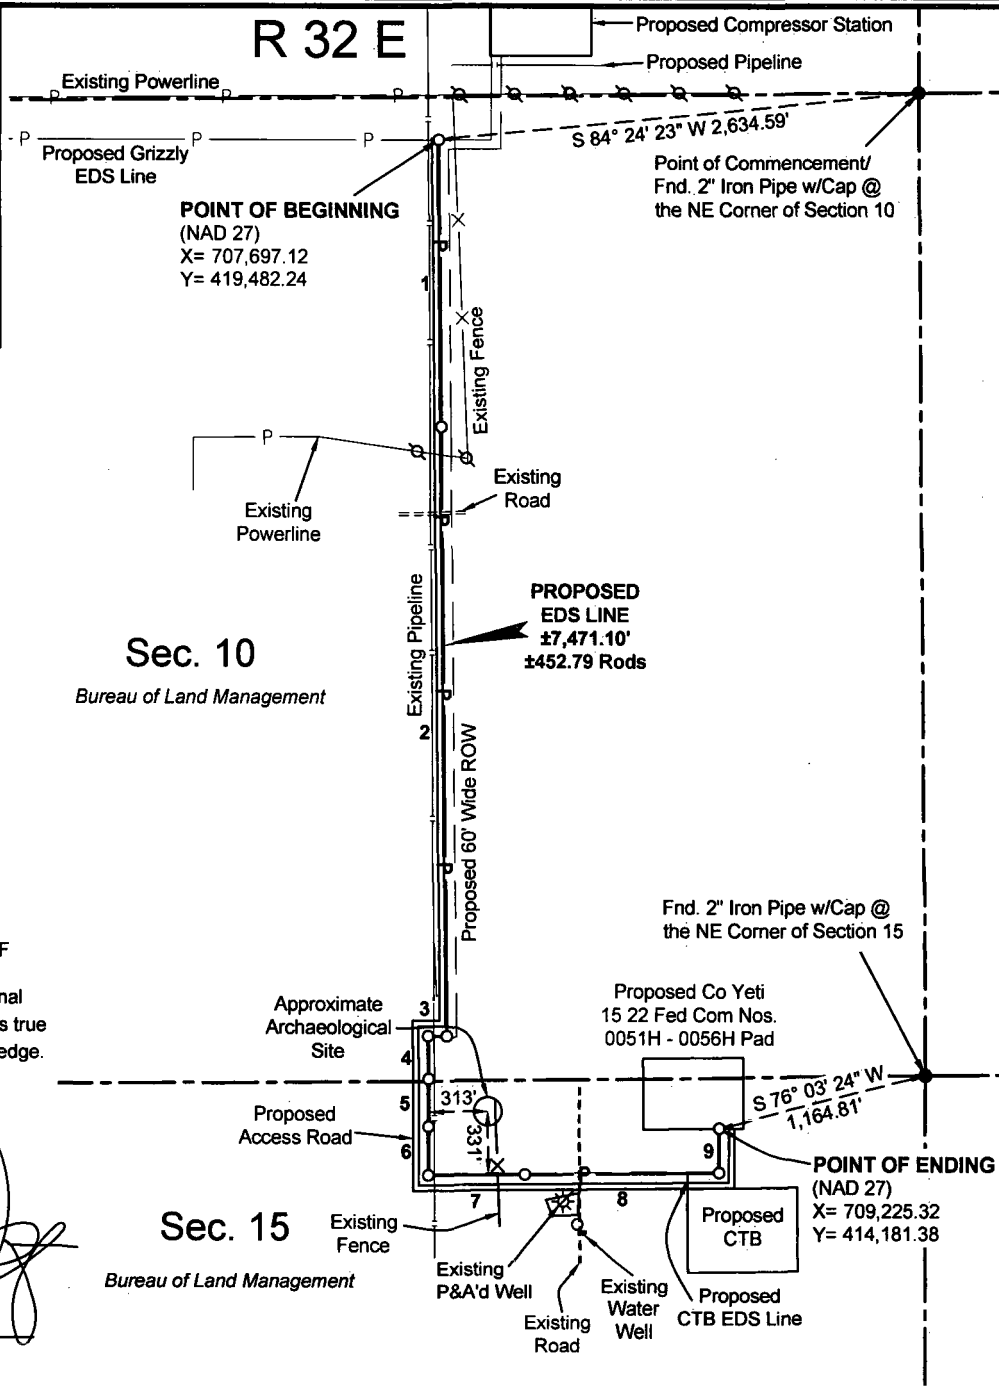EDS LINE PLAT



Page 1 of 2

CHEVRON U.S.A. INC.
PROPOSED EDS LINE
CO YETI 15 22 FED COM NOS. 0051H-0056H WELLS
SECTIONS 10 & 15, T25S-R32E
LEA COUNTY, NEW MEXICO



C. H. Fenstermaker & Associates, L.L.C.
135 Regency Sq. Lafayette, LA 70508
Ph. 337-237-2200 Fax. 337-232-3299
www.fenstermaker.com

REVISIONS				
DRAWN BY:	AMT	#	BY:	DATE:
PROJ. MGR.:	VHV	1	DMB	04/18/2018
DATE:	04/04/2018	2	AMT	06/28/2018
DESCRIPTION:				
Revised EDS line, access & ROW.				
Revised EDS line.				
FILENAME: T:\2018\2187192\DWG\CO Yeti 15 22 Fed Com 0051H-0056H_EDS Line.dwg				

**METES AND BOUNDS DESCRIPTION OF
PROPOSED EDS LINE
SECTIONS 10 AND 15 OF TOWNSHIP 25 SOUTH RANGE 32 EAST
LEA COUNTY, NEW MEXICO**

Survey of a proposed EDS line 7,471.10 feet or 452.79 rods crossing Bureau of Land Management land in Sections 10 and 15 of Township 25 South Range 32 East, N.M.P.M. Lea County, New Mexico.

COMMENCING at a Found 2" Iron Pipe with Cap at the Northeast Corner of said Section 10; Thence South 84 degrees 24 minutes 23 seconds West 2,634.59 feet to the **POINT OF BEGINNING** having the following coordinates: X=707,697.12 and Y=419,482.24 (New Mexico State Plane Coordinate System, East Zone, NAD 27);

Thence South 00 degrees 32 minutes 14 seconds East 1,542.17 feet to a point;
Thence South 00 degrees 32 minutes 18 seconds East 3,262.42 feet to a point;
Thence West 103.03 feet to a point;
Thence South 01 degrees 06 minutes 34 seconds East 231.11 feet to a point;
Thence South 00 degrees 01 minutes 43 seconds East 255.45 feet to a point;
Thence South 00 degrees 03 minutes 33 seconds East 259.55 feet to a point;
Thence North 89 degrees 36 minutes 03 seconds East 516.90 feet to a point;
Thence North 89 degrees 27 minutes 56 seconds East 1,064.41 feet to a point;

Thence North 236.06 feet to the **POINT OF ENDING** having the following coordinates: X=709,225.32 and Y=414,181.38 (New Mexico State Plane Coordinate System, East Zone, NAD 27)

The bearings recited hereon are oriented to NAD 27 New Mexico East Zone.

This description represents a survey made on the ground of a proposed EDS line and intended solely for that purpose. This description does not represent a boundary survey.

DISCLAIMER: At this time, C. H. Fenstermaker & Associates, L.L.C. has not performed nor was asked to perform any type of engineering, hydrological modeling, flood plain, or "No Rise" certification analyses, including but not limited to determining whether the project will impact flood hazards in connection with federal/FEMA, state, and/or local laws, ordinances and regulations. Accordingly, Fenstermaker makes no warranty or representation of any kind as to the foregoing issues, and persons or entities using this information shall do so at their own risk.


NOTE:

Please be advised, that while reasonable efforts are made to locate and verify pipelines and anomalies using our standard pipeline locating equipment, it is impossible to be 100 % effective. As such, we advise using caution when performing work as there is a possibility that pipelines and other hazards, such as fiber optic cables, PVC pipelines, etc. may exist undetected on site.

NOTE:

Many states maintain information centers that establish links between those who dig (excavators) and those who own and operate underground facilities (operators). It is advisable and in most states, law, for the contractor to contact the center for assistance in locating and marking underground utilities. For guidance, New Mexico One Call www.nmonecall.org

FOR THE EXCLUSIVE USE OF
CHEVRON U.S.A. INC.
I, Robert L. Lastrapes, Professional
Surveyor, do hereby state this plat is true
and correct to the best of my knowledge.

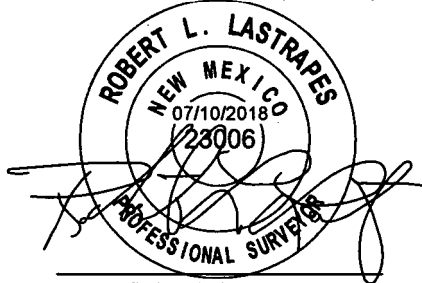

Robert L. Lastrapes
Registration No. 23006

PROPOSED EDS LINE		
COURSE	BEARING	DISTANCE
1	S 00° 32' 14" E	1542.17'
2	S 00° 32' 18" E	3262.42'
3	WEST	103.03'
4	S 01° 06' 34" E	231.11'
5	S 00° 01' 43" E	255.45'
6	S 00° 03' 33" E	259.55'
7	N 89° 36' 03" E	516.90'
8	N 89° 27' 56" E	1064.41'
9	NORTH	236.06'

EDS LINE PLAT

Page 2 of 2

CHEVRON U.S.A. INC.
PROPOSED EDS LINE
CO YETI 15 22 FED COM NOS. 0051H-0056H WELLS
SECTIONS 10 & 15, T25S-R32E
LEA COUNTY, NEW MEXICO



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REVISIONS				
DRAWN BY:	AMT	#	BY:	DATE:
PROJ. MGR.:	VHV	1	DMB	04/18/2018
DATE:	04/04/2018	2	AMT	06/28/2018
DESCRIPTION:				
Revised EDS line, access & ROW.				
Revised EDS line.				
FILENAME: T:\2018\2187192\DWG\CO Yeti 15 22 Fed Com 0051H-0056H_EDS Line.dwg				

R 32 E

Sec. 10

Bureau of Land Management

Point of Commencement/
Fnd. 2" Iron Pipe w/ Cap @
the NE Corner of Section 15

Proposed CO Yeti 15 22 Fed Com
Nos. 0051H - 0056H Pad

Sec. 15

Bureau of Land Management

POINT OF BEGINNING
(NAD 27)
X= 709,255.82
Y= 414,181.38

**PROPOSED
FLOWLINES (6)**
±318.28'
±19.29 Rods

POINT OF ENDING
(NAD 27)
X= 709,255.82
Y= 413,863.11

Proposed
CTB

LEGEND


- +— Proposed Flowlines
- - - Proposed ROW
- - - Proposed Pad/Access
- - - Existing Pad/Road
- X- Existing Fence
- - - Existing Pipeline
- - - Section Line
- * Existing P&A'd Well
- Q Existing Water Well
- Fnd. Monument

Existing P&A'd Well

Existing Water Well

FOR THE EXCLUSIVE USE OF
CHEVRON U.S.A. INC.

I, Robert L. Lastrapes, Professional
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Robert L. Lastrapes
Registration No. 23006

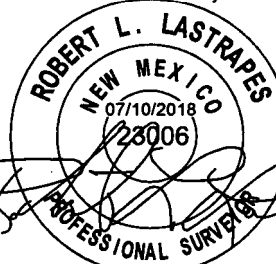FLOWLINE PLAT

Page 1 of 2

CHEVRON U.S.A. INC.
PROPOSED FLOWLINES
CO YETI 15 22 FED COM NOS. 0051H - 0056H WELLS
SECTION 15, T25S-R32E
LEA COUNTY, NEW MEXICO

REVISIONS

DRAWN BY:	#	BY:	DATE:	DESCRIPTION:
PROJ. MGR.: VHV	1	DMB	04/18/2018	Revised flowlines, access & ROW.
DATE: 04/03/2018	2	AMT	06/28/2018	Revised Flowlines.
FILENAME: T:\2018\2187192\DWG\CO Yeti 15 22 Fed Com 0051H-0056H_Flowlines.dwg				

T
25
S

NAD 27 NEW MEXICO EAST ZONE

Scale: 1" = 200'

200' 0 100' 200'



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**METES AND BOUNDS DESCRIPTION OF
PROPOSED FLOWLINES
SECTION 15 OF TOWNSHIP 25 SOUTH RANGE 32 EAST
LEA COUNTY, NEW MEXICO**

Survey of proposed flowlines 318.28 feet or 19.29 rods crossing Bureau of Land Management land in Section 15 of Township 25 South Range 32 East, N.M.P.M. Lea County, New Mexico.

COMMENCING at a Found 2" Iron Pipe with Cap at the Northeast Corner of said Section 15; Thence South 75 degrees 41 minutes 08 seconds West 1,135.24 feet to the **POINT OF BEGINNING** having the following coordinates: X=709,255.82 and Y=414,181.38 (New Mexico State Plane Coordinate System, East Zone, NAD 27);

Thence South 318.28 feet to the **POINT OF ENDING** having the following coordinates: X=709,255.82 and Y=413,863.11 (New Mexico State Plane Coordinate System, East Zone, NAD 27)

The bearings recited hereon are oriented to NAD 27 New Mexico East Zone.

This description represents a survey made on the ground of proposed flowlines and intended solely for that purpose. This description does not represent a boundary survey.

PROPOSED FLOWLINES		
COURSE	BEARING	DISTANCE
1	SOUTH	318.28'

NOTE:


Please be advised, that while reasonable efforts are made to locate and verify pipelines and anomalies using our standard pipeline locating equipment, it is impossible to be 100 % effective. As such, we advise using caution when performing work as there is a possibility that pipelines and other hazards, such as fiber optic cables, PVC pipelines, etc. may exist undetected on site.

NOTE:

Many states maintain information centers that establish links between those who dig (excavators) and those who own and operate underground facilities (operators). It is advisable and in most states, law, for the contractor to contact the center for assistance in locating and marking underground utilities. For guidance, New Mexico One Call www.nmonecall.org

DISCLAIMER: At this time, C. H. Fenstermaker & Associates, L.L.C. has not performed nor was asked to perform any type of engineering, hydrological modeling, flood plain, or "No Rise" certification analyses, including but not limited to determining whether the project will impact flood hazards in connection with federal/FEMA, state, and/or local laws, ordinances and regulations. Accordingly, Fenstermaker makes no warranty or representation of any kind as to the foregoing issues, and persons or entities using this information shall do so at their own risk.

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Surveyor, do hereby state this plat is true
and correct to the best of my knowledge.

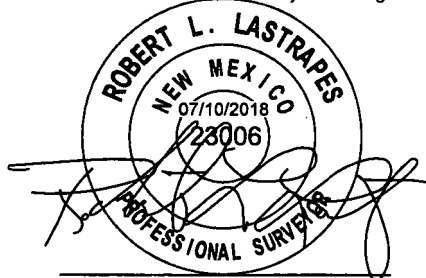

Robert L. Lastrapes
Registration No. 23006



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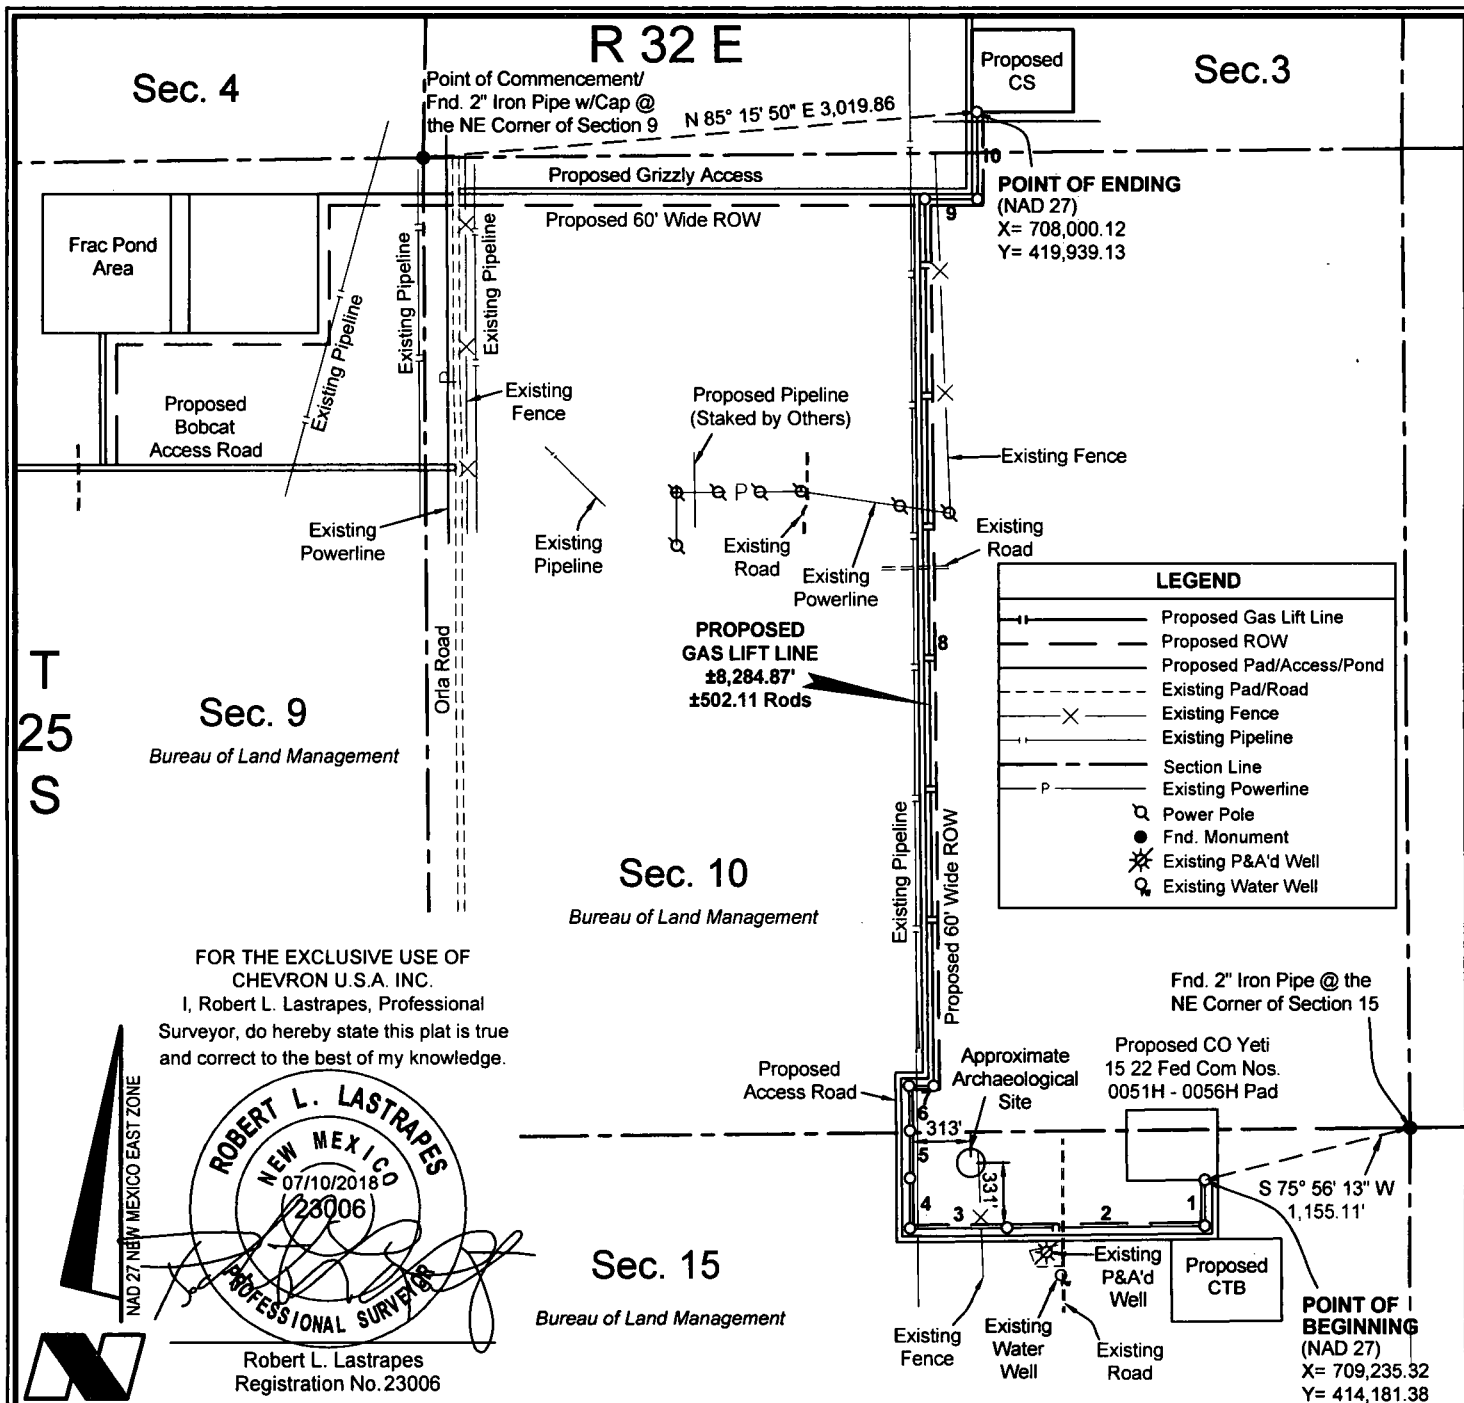
FLOWLINE PLAT

Page 2 of 2

CHEVRON U.S.A. INC.
PROPOSED FLOWLINES
CO YETI 15 22 FED COM NOS. 0051H - 0056H WELLS
SECTION 15, T25S-R32E
LEA COUNTY, NEW MEXICO

REVISIONS

DRAWN BY:	DMB	#	BY:	DATE:	DESCRIPTION:
PROJ. MGR.:	VHV	1	DMB	04/18/2018	Revised flowlines, access & ROW.
DATE:	04/03/2018	2	AMT	06/28/2018	Revised Flowlines.
FILENAME: T:\2018\2187192\DWG\CO Yeti 15 22 Fed Com 0051H-0056H_Flowlines.dwg					



Page 1 of 2

CHEVRON U.S.A. INC.

PROPOSED GAS LIFT LINE
CO YETI 15 22 FED COM NOS. 0051H - 0056H WELLS
SECTIONS 3, 10 & 15, T25S-R32E
LEA COUNTY, NEW MEXICO



C. H. Fenstermaker & Associates, L.L.C.
135 Regency Sq. Lafayette, LA 70508
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REVISIONS				
DRAWN BY:	#	BY:	DATE:	DESCRIPTION:
PROJ. MGR.: VHV	1	DMB	04/18/2018	Revised gas lift line, access and ROW
DATE: 04/04/2018	2	AMT	06/28/2018	Revised Gas Lift Line.
FILENAME: T:\2018\2187192\DWG\CO Yeti 15 22 Fed Com 0051H-0056H_Gas Lift_Line.dwg				

**METES AND BOUNDS DESCRIPTION OF
PROPOSED GAS LIFT LINES
SECTIONS 3, 10 & 15 OF TOWNSHIP 25 SOUTH RANGE 32 EAST
LEA COUNTY, NEW MEXICO**

Survey of proposed gas lift lines 8,284.87 feet or 502.11 rods crossing Bureau of Land Management land in Sections 3, 10 & 15 of Township 25 South Range 32 East, N.M.P.M. Lea County, New Mexico.

COMMENCING at a Found 2" Iron Pipe with at the Northeast Corner of said Section 15;
Thence South 75 degrees 56 minutes 13 seconds West 1,155.11 feet to the **POINT OF BEGINNING** having the following coordinates: X=709,235.32 and Y=414,181.38 (New Mexico State Plane Coordinate System, East Zone, NAD 27);

Thence South 245.96 feet to a point;
Thence South 89 degrees 27 minutes 56 seconds West 1,074.33 feet to a point;
Thence South 89 degrees 36 minutes 03 seconds West 526.97 feet to a point;
Thence North 00 degrees 03 minutes 33 seconds West 269.62 feet to a point;
Thence North 00 degrees 01 minutes 43 seconds West 255.35 feet to a point;
Thence North 01 degrees 06 minutes 34 seconds West 241.21 feet to a point;
Thence East 133.19 feet to a point;
Thence North 00 degrees 32 minutes 23 seconds West 4,774.68 feet to a point;
Thence South 89 degrees 59 minutes 00 seconds East 286.67 feet to a point;

Thence North 00 degrees 27 minutes 07 seconds West 476.89 feet to the **POINT OF ENDING** having the following coordinates: X=708,000.12 and Y=419,939.13 (New Mexico State Plane Coordinate System, East Zone, NAD 27)


The bearings recited hereon are oriented to NAD 27 New Mexico East Zone.

This description represents a survey made on the ground of proposed gas lift lines and intended solely for that purpose. This description does not represent a boundary survey.

PROPOSED GAS LIFT LINE		
COURSE	BEARING	DISTANCE
1	SOUTH	245.96'
2	S 89° 27' 56" W	1074.33'
3	S 89° 36' 03" W	526.97'
4	N 00° 03' 33" W	269.62'
5	N 00° 01' 43" W	255.35'
6	N 01° 06' 34" W	241.21'
7	EAST	133.19'
8	N 00° 32' 23" W	4774.68'
9	S 89° 59' 00" E	286.67'
10	N 00° 27' 07" W	476.89'

FOR THE EXCLUSIVE USE OF
CHEVRON U.S.A. INC.

I, Robert L. Lastrapes, Professional
Surveyor, do hereby state this plat is true
and correct to the best of my knowledge.

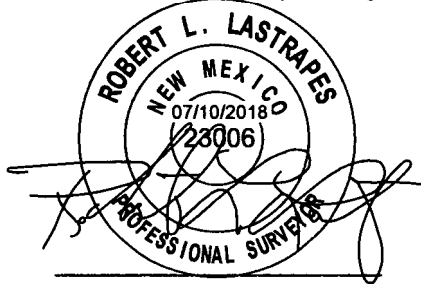

Robert L. Lastrapes
Registration No. 23006

NOTE:

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GAS LIFT LINE PLAT

Page 2 of 2

CHEVRON U.S.A. INC.
PROPOSED GAS LIFT LINE
CO YETI 15 22 FED COM NOS. 0051H - 0056H WELLS
SECTIONS 3, 10 & 15, T25S-R32E
LEA COUNTY, NEW MEXICO



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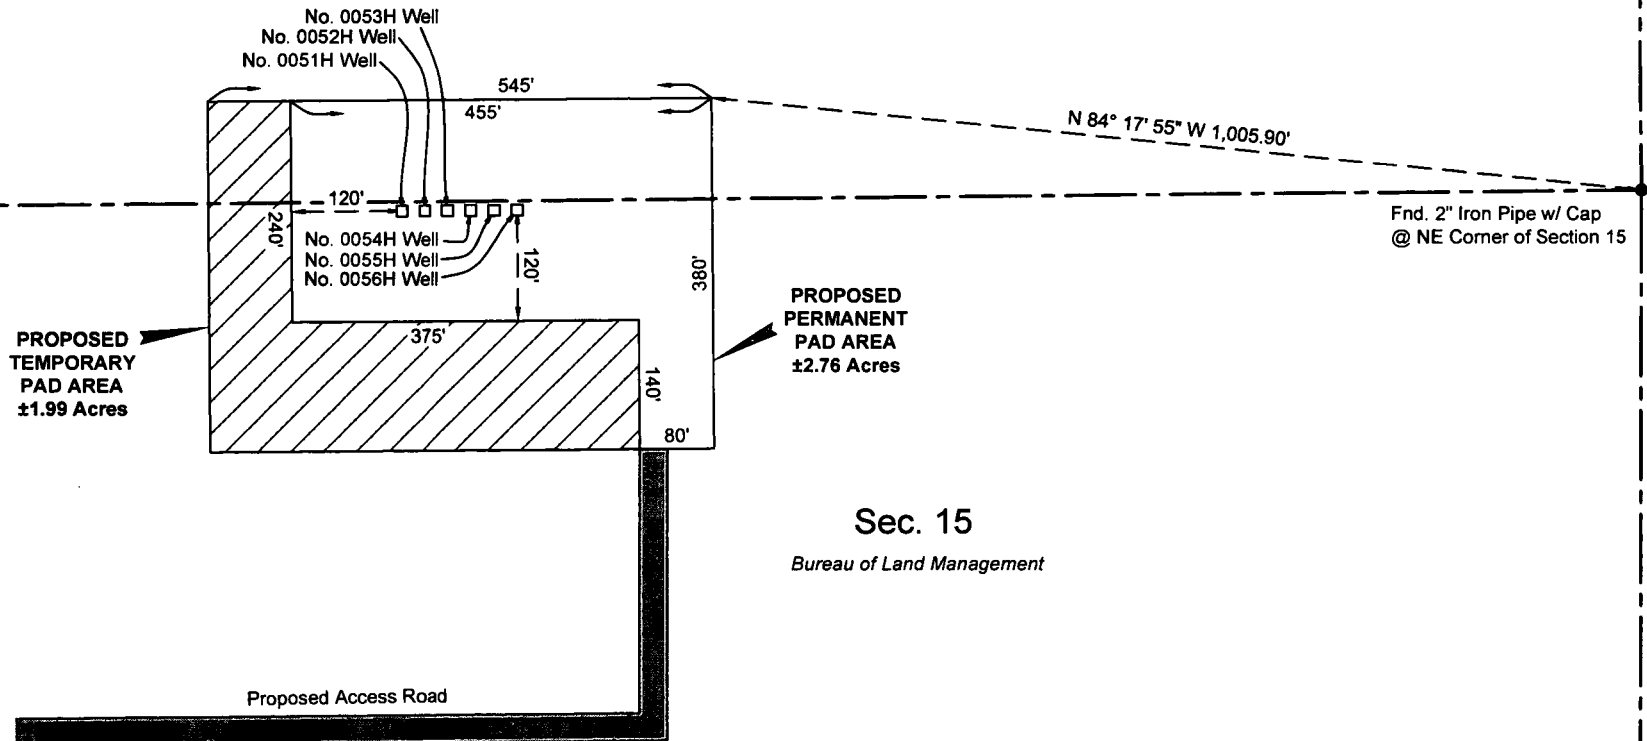
REVISIONS				
DRAWN BY:	#	BY:	DATE:	DESCRIPTION:
PROJ. MGR.: VHV	1	DMB	04/18/2018	Revised temp. water line, access & ROW.
DATE: 04/04/2018	2	AMT	06/28/2018	Revised Gas Lift Line.
FILENAME: T:\2018\2187192\DWG\CO Yeti 15 22 Fed Com 0051H-0056H_Gas Lift Line.dwg				

R 32 E

Sec. 10

Bureau of Land Management

T
25
S



Sec. 15

Bureau of Land Management

NAD 27 NEW MEXICO EAST ZONE

LEGEND

	Proposed Pad
	Proposed Access Road
	Section Line
	Fnd. Monument

Scale: 1" = 200'

200' 0 100' 200'

FOR THE EXCLUSIVE USE OF
CHEVRON U.S.A. INC.

I, Robert L. Lastrapes, Professional
Surveyor, do hereby state this plat is true
and correct to the best of my knowledge.



Robert L. Lastrapes
Registration No. 23006

INTERIM RECLAMATION PLAT

Page 1 of 2

CHEVRON U.S.A. INC.

INTERIM RECLAMATION

CO YETI 15 22 FED COM NOS. 0051H-0056H WELLS

SECTIONS 10 & 15, T25S-R32E

LEA COUNTY, NEW MEXICO

REVISIONS

DRAWN BY:	#	BY:	DATE:	DESCRIPTION:
PROJ. MGR.: VHV	1	DMB	04/18/2018	Revised access road & removed 4H well.
DATE: 04/03/2018	2	VHV	07/05/2018	Revised Pad Size

FILENAME: T:\2018\2187192\DWG\CO Yeti 15 22 Fed Com 0051H-0056H_IR.dwg



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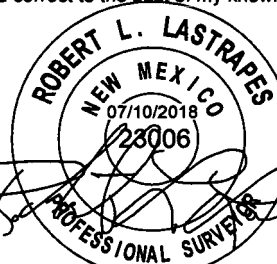
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NW PAD CORNER			NE PAD CORNER		
X=	708,810	NAD 27	X=	709,355	NAD 27
Y=	414,558		Y=	414,562	
LAT.	32.137938 N		LAT.	32.137940 N	
LONG.	103.658736 W		LONG.	103.656976 W	
X=	749,995	NAD83/2011	X=	750,540	NAD83/2011
Y=	414,616		Y=	414,620	
LAT.	32.138062 N		LAT.	32.138064 N	
LONG.	103.659212 W		LONG.	103.657451 W	
SW PAD CORNER			SE PAD CORNER		
X=	708,813	NAD 27	X=	709,358	NAD 27
Y=	414,178		Y=	414,182	
LAT.	32.136894 N		LAT.	32.136896 N	
LONG.	103.658735 W		LONG.	103.656974 W	
X=	749,998	NAD83/2011	X=	750,543	NAD83/2011
Y=	414,236		Y=	414,240	
LAT.	32.137018 N		LAT.	32.137020 N	
LONG.	103.659210 W		LONG.	103.657450 W	

FOR THE EXCLUSIVE USE OF
CHEVRON U.S.A. INC.
I, Robert L. Lastrapes, Professional
Surveyor, do hereby state this plat is true
and correct to the best of my knowledge.



Robert L. Lastrapes
Registration No. 23006



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INTERIM RECLAMATION PLAT					Page 2 of 2
CHEVRON U.S.A. INC. INTERIM RECLAMATION CO YETI 15 22 FED COM NOS. 0051H-0056H WELLS SECTIONS 10 & 15, T25S-R32E LEA COUNTY, NEW MEXICO					
REVISIONS					
DRAWN BY:	VHV	#	BY:	DATE:	DESCRIPTION:
PROJ. MGR.:	VHV	1	DMB	04/18/2018	Revised access road & removed 4H well.
DATE:	04/03/2018	2	VHV	07/05/2018	Revised Pad Size.
FILENAME: T:\2018\2187192\DWG\ICO Yeti 15 22 Fed Com 0051H-0056H_IR.dwg					

APD Surface Use Plan of Operations

Existing Roads (Road Plat Attached)

- The operator will improve or maintain existing roads in a condition the same as or better than before operations begin. The operator will repair pot holes, clear ditches, repair the crown, etc. All existing structures on the entire access route such as cattle guards, other range improvement projects, culverts, etc. will be properly repaired or replaced if they are damaged or have deteriorated beyond practical use. We will prevent and abate fugitive dust as needed, whether created by vehicular traffic, equipment operations, or wind events. BLM written approval will be acquired before application of surfactants, binding agents, or other dust suppression chemicals on roadways.
- Driving Directions – From Jal, New Mexico. The location is approximately 29 miles from the nearest town, which is Jal, New Mexico. From Jal, proceed west on Highway 128 approximately 27 miles and turn left (South) onto CR1 (Orla Hwy) and go approximately 5 miles on CR1 until the road reaches a lease road on the left. Turn left (east) onto lease road (Chevron has an agreement and easement for use of this road) and travel easterly approximately .75 miles, then bear left (north) approximately .75 miles on lease road to the well location.

New or Reconstructed Access Roads (Well Plat Attached)

- There will be 7,793.43 of new road construction for the well pad and facilities.
- Road Width: The access road shall have a driving surface that creates the smallest possible surface disturbance and does not exceed 20'. The maximum width of surface disturbance shall not exceed 25'.
- Maximum Grade: 3%
- Crown Design: Crowning shall be done on the access road driving surface. The road crown shall have a grade of approximately 2%. The road shall conform to cross section and plans for typical road construction found in the BLM Gold Book.
- Turnouts: 50-60'
- Ditch Design: Ditching will be constructed on both sides of road.
- Cattle guards: None suggestion
- Major Cuts and Fills: 2:1 during drilling and completions. Cuts and fills taken back to 3:1 at interim.

CHEVRON U.S.A. Inc.

CO YETI 15 22 FED COM 0055H

USA NMLC 062300 & USA NMNM 123518

SECTION 15, T26S-R32E

SECTION 22, T25S, R32E

SHL 10' FNL & 1235' FEL

BHL 100' FSL & 330' FEL

- Type of Surfacing Material: Caliche. The road will also have a dust abatement polymer coating to decrease dust as well as help maintain the road, Envirotac II.

Location of Existing Wells (Diagram Attached)

- 1-Mile radius map is attached

Location of Existing and/or Proposed Production Facilities (Work Area Detail Map Attached)

- Facilities:
 - A proposed **CTB production site** will be located on the South side of the well pad in Sec. 15, T26S-R32E where oil and gas sales will take place. Please see CTB site plat and Cut & Fill plat attached hereto.
 - A proposed **Compressor Station** will be located approximately 1 mile north of the above-referenced CTB Production Facility in Sec. 3, T26S-R32E where oil and gas sales will take place. Please see compressor station site plat and Cut & Fill plat attached hereto.
 - A proposed **Frac Pond** will be in the NE4 of Sec. 9, T25S-R32E. Please see frac pond site plat and Cut & Fill plat attached hereto.
 - Open top tanks or open containments will be netted.
 - Open vent exhaust stacks will be modified to prevent birds or bats from entering, discourage perching, roosting, and nesting.
 - Facilities will have a secondary containment 1.5 times the holding capacity of largest storage tank.
 - All above ground structures will be painted non-reflective shale green for blending with surrounding environment.
 - The tank battery will be connected to the existing water gathering system in the field for permanent water disposal.

Location of Proposed ROW (Work Area Detail Map Attached)

- Pipelines: 6 - 4" buried flowlines, approximately 318.28', will be laid from well to the CTB production facility at the south side of the well site.
 - All construction activity will be confined to the approved ROW.
- Pipelines: 2 - 4" buried gas lift pipelines, approximately 8,284.87', will be laid from the well site running adjacent to the lease road to the Compressor facility in Sec. 3, T26S-R32E.
 - All construction activity will be confined to the approved ROW.
 - Pipeline will run parallel to existing disturbances and will stay within approved ROW.

CHEVRON U.S.A. Inc.

CO YETI 15 22 FED COM 0055H

USA NMLC 062300 & USA NMNM 123518

SECTION 15, T26S-R32E

SECTION 22, T25S, R32E

SHL 10' FNL & 1235' FEL

BHL 100' FSL & 330' FEL

- CTB Flowlines: 2 - 4" buried pipelines, approximately 9,917.10' in length, will be laid from well to the CTB production facility at the south side of the well site and run north within the proposed 60' easement to the Central Tank Battery located in Section 3.
 - All construction activity will be confined to the approved ROW.
- CTB Gas Lift line: 1 - 4" buried pipeline, approximately 9,932.66' in length, will be laid from well to the CTB production facility at the south side of the well site and run north within the proposed 60' easement to the Central Tank Battery located in Section 3.
 - All construction activity will be confined to the approved ROW.
- CTB Liquid Gathering line: 1 - 4" buried pipeline, approximately 9,917.22' in length, will be laid from well to the CTB production facility at the south side of the well site and run north within the proposed 60' easement to the Central Tank Battery located in Section 3.
 - All construction activity will be confined to the approved ROW.
- CTB Power line: A powerline, approximately 82.50' in length, will be installed from the CTB northward and connecting to the proposed Yeti pad powerline referenced below.
- Power lines: A powerline, approximately 7,471.10' in length, will be installed from the well site west to an existing pipeline easement and running north along said easement and connecting to an existing powerline on the northern boundary line of Section 10.
 - This will cross lease lines and a ROW will be applied for through the BLM.
 - All construction activity will be confined to the approved ROW.
 - Power line will run parallel to the road and will stay within approved ROW.

Location and Types of Water Supply (Work Area Detail Map Attached)

- A proposed **Frac Pond** will be in the NE4 of Sec. 9, T25S-R32E. (Please see frac pond site plat and Cut & Fill plat attached hereto) and will be utilized for fresh water and recycled water.
- Fresh water will be obtained from a private water source.
- A temporary 10" expanding pipe water transfer line will run west from the Yeti pad and then north and then west within the proposed 60' easement corridor approximately 10,765.02' to the proposed frac pond in the NE corner of Section 9.
 - This will cross lease lines and a BLM ROW will be required for the water transfer line.

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USA NMLC 062300 & USA NMNM 123518

SECTION 15, T26S-R32E

SECTION 22, T25S, R32E

SHL 10' FNL & 1235' FEL

BHL 100' FSL & 330' FEL

Construction Material

- Caliche will be used to construct well pad and roads. Material will be purchased from the private land owners (Oliver Kiehne) caliche pit located in Sec 27, T26, R33E, Lea County, NM.
- The proposed source of construction material will be located and purchased by Chevron U.S.A. Inc.
 - Notification shall be given to BLM at (575) 234-5909 at least 3 working days prior to commencing construction of access road and/or well pad.

Methods for Handling Waste

- Drilling fluids and produced oil and water from the well during drilling and completion operations will be stored safely and disposed of properly in an NMOCD approved disposal facility.
- Garbage and trash produced during drilling and completion operations will be collected in a trash container and disposed of properly at a state approved disposal facility. All trash on and around the well site will be collected for disposal.
- Human waste and grey water will be properly contained and disposed of properly at a state approved disposal facility.
- After drilling and completion operations, trash, chemicals, salts, frac sand and other waste material will be removed and disposed of properly at a state approved disposal facility.
- The well will be drilled utilizing a closed loop system. Drill cutting will be properly disposed of into steel tanks and taken to an NMOCD approved disposal facility.

Ancillary Facilities

None

Well Site Layout (Well Plat Attached)

- Well Plat
 - Exterior well pad dimensions are 380' x 545'.
 - Interior well pad dimensions from point of entry (well head) of the easternmost well are N-120', S-260', E-235', W-310'. The length to the west includes 25' spacing for next well on multi-well pad (five wells). Total disturbance area needed for construction of well pad will be 4.75 acres.
 - Topsoil placement is on the east where interim reclamation is planned to be completed upon completion of well and evaluation of best management practices.

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Proposed Pad Cut & Fill (Plat Attached)

- Cut and fill: will be minimal.

Rig Layout (Attached)

Plans for Surface Reclamation (Pad Plat Attached)

Reclamation Objectives

- The objective of interim reclamation is to restore vegetative cover and a portion of the landform sufficient to maintain healthy, biologically active topsoil; control erosion; and minimize habitat and forage loss, visual impact, and weed infestation, during the life of the well or facilities.
- The long-term objective of final reclamation is to return the land to a condition similar to what existed prior to disturbance. This includes restoration of the landform and natural vegetative community, hydrologic systems, visual resources, and wildlife habitats. To ensure that the long-term objective will be reached through human and natural processes, actions will be taken to ensure standards are met for site stability, visual quality, hydrological functioning, and vegetative productivity.
- The BLM will be notified at least 3 days prior to commencement of any reclamation procedures.
- If circumstances allow, interim reclamation and/or final reclamation actions will be completed no later than 6 months from when the final well on the location has been completed or plugged. We will gain written permission from the BLM if more time is needed.
- Reclamation will be performed by using the following procedures:

Interim Reclamation Procedures

- Within 6 months, Chevron will contact BLM Surface Management Specialists to devise the best strategies to reduce the size of the location. Current plans for interim reclamation include reducing the pad size to approximately 2.76 acres from the proposed size of 4.75 acres. Within 30 days of well completion, the well location and surrounding areas will be cleared of, and maintained free of, all materials, trash, and equipment not required for production. A plan will be submitted showing where interim reclamation will be completed in order to allow for safe operations, protection of the environment outside of drilled well, and following best management practices found in the BLM "Gold Book".
- In areas planned for interim reclamation, all the surfacing material will be removed and returned to the original mineral pit or recycled to repair or build roads and well pads.
- The areas planned for interim reclamation will then be recontoured to the original contour if feasible, or if not feasible, to an interim contour that blends with the surrounding topography as much as possible. Where applicable, the fill material of

the well pad will be backfilled into the cut to bring the area back to the original contour. The interim cut and fill slopes prior to re-seeding will not be steeper than a 3:1 ratio, unless the adjacent native topography is steeper. Note: Constructed slopes may be much steeper during drilling, but will be recontoured to the above ratios during interim reclamation.

- Topsoil will be evenly re-spread and aggressively revegetated over the entire disturbed area not needed for all-weather operations including cuts & fills. To seed the area, the proper BLM seed mixture (BLM #2), free of noxious weeds, will be used.
- Proper erosion control methods will be used on the area to control erosion, runoff and siltation of the surrounding area.
- The interim reclamation will be monitored periodically to ensure that vegetation has reestablished

Final Reclamation (well pad, buried pipelines, and power lines, etc.)

- Prior to final reclamation procedures, the well pad, road, and surrounding area will be cleared of material, trash, and equipment.
- All surfacing material will be removed and returned to the original mineral pit or recycled to repair or build roads and well pads.
- All disturbed areas, including roads, pipelines, pads, production facilities, and interim reclaimed areas will be recontoured to the contour existing prior to initial construction or a contour that blends in distinguishably with the surrounding landscape. Topsoil that was spread over the interim reclamation areas will be stockpiled prior to recontouring. The topsoil will be redistributed evenly over the entire disturbed site to ensure successful revegetation.
- After all the disturbed areas have been properly prepared; the areas will be seeded with the proper BLM seed mixture (BLM #2), free of noxious weeds.
- Proper erosion control methods will be used on the entire area to control erosion, runoff and siltation of the surrounding area.

Surface Ownership

- All subject property and infrastructure is on Federal Surface.
- **Nearest Post Office:** Jal Post Office; 29 Miles East

Other Information

- On-site performed by BLM NRS: Paul Murphy 6/20/2018
- Cultural report attached: N/A Participating Agreement attached: **Yes**
- Erosion / Drainage: Drainage control system shall be constructed on the entire length of road by the use of any of the following: ditches, side hill out-sloping and in-sloping, lead-off ditches, culvert installation, or low water crossings.

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- Exclosure fencing will be installed around open cellar to prevent livestock or large wildlife from being trapped after installation. Fencing will remain in place while no activity is present and until backfilling takes place.
- Terrain: Landscape is flat
- Soil: Sandy loam
- Vegetation: Vegetation present in surrounding area includes mesquite, shrubs, and grass (needle-grass, burro grass, dropseed).
- Wildlife: No wildlife observed, but it is likely that deer, rabbits, coyotes, and rodents pass through the area.
- Surface Water: No surface water concerns.
- Cave Karst: Low Karst area with no caves or visual signs of caves found.
- Watershed Protection: The entire perimeter of the well pad will be bermed to prevent oil, salt, and other chemical contaminants from leaving the well pad.
- Water wells: No known water wells within the 1- mile radius.
- Residences and Buildings: No dwellings within the immediate vicinity of the proposed location.
- Well Signs: Well signs will be in compliance per federal and state requirements and specifications.

Chevron Representatives

Primary point of contact:

W Mark Woodard

432 687 7999

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