


REVIEWED
By Kellie Jones at 8:52 am, Jan 25, 2016

APPROVED
By Kellie Jones at 8:52 am, Jan 25, 2016

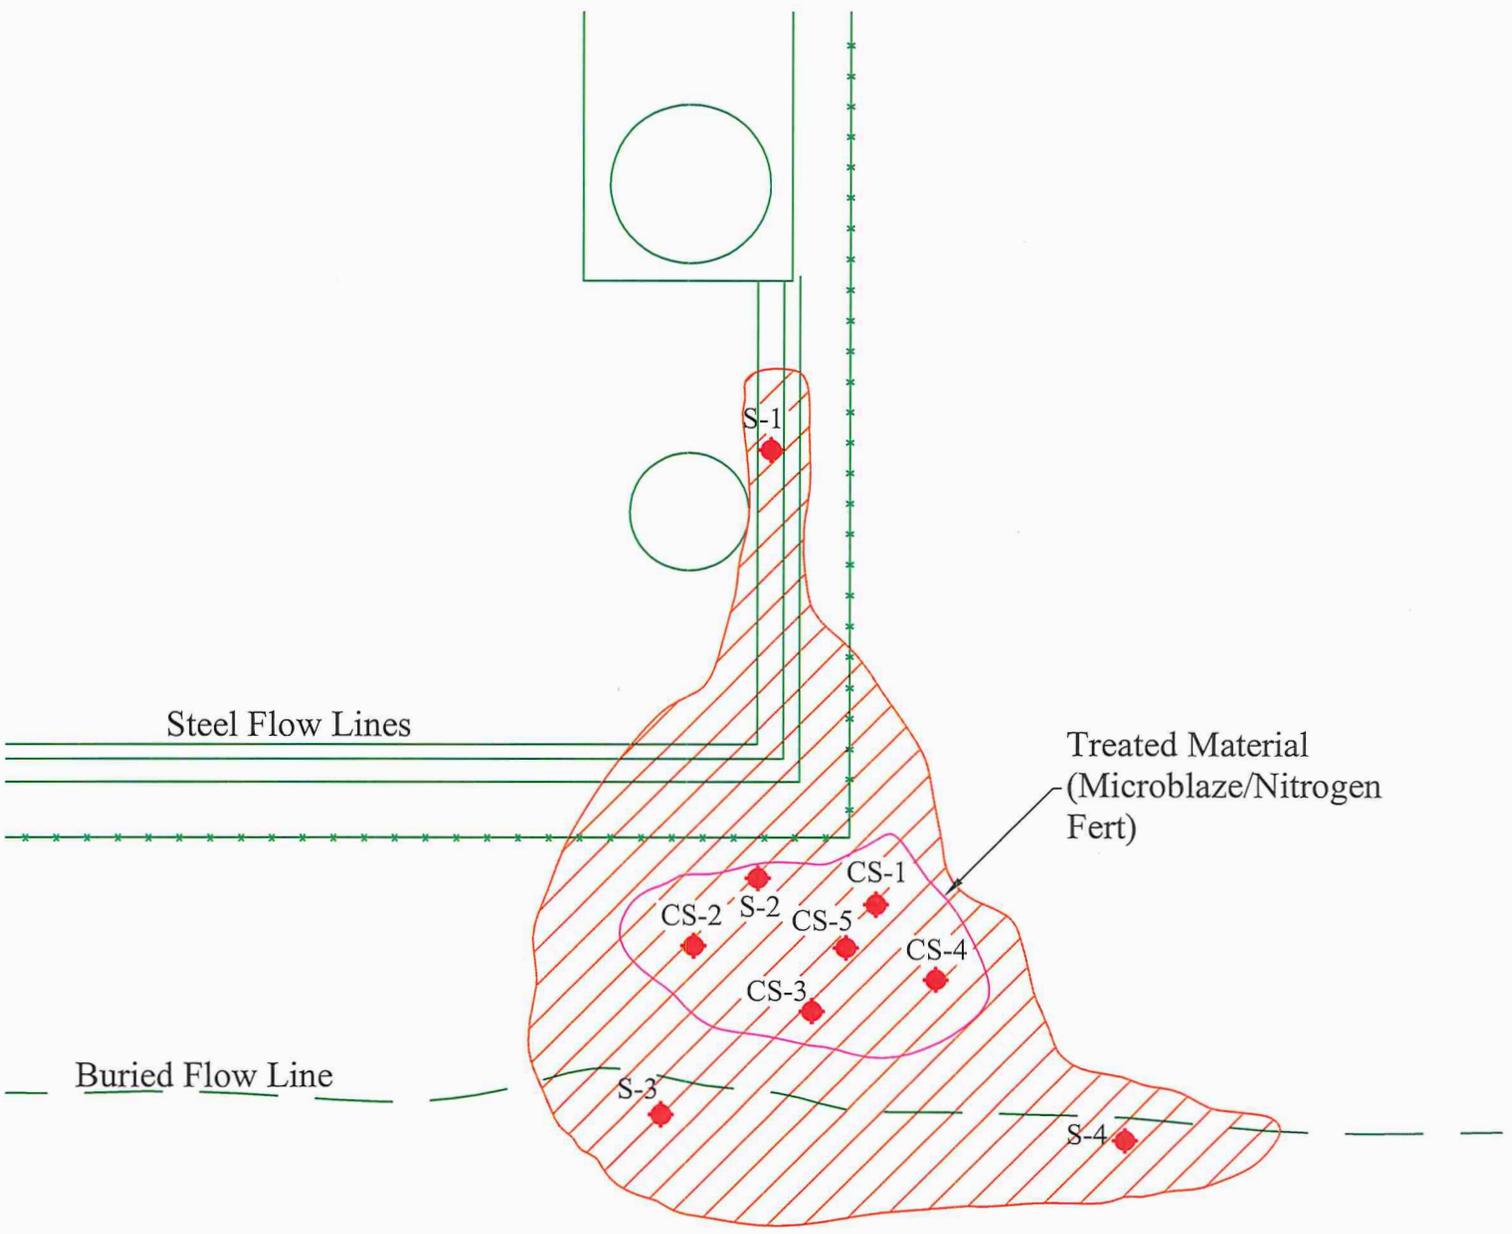

- Legend**
- Sample Location (Red diamond)
 - Barb Wire Line (Green dashed line with asterisks)
 - Impacted Area (Red hatched area)



1. Permission granted to backfill - 01/25/2016.



Date: 11/11/2015
Scale: NTS
Drawn By: TJS

Playa 2 State #1
Devon Energy Corporation
Lea County, New Mexico
Figure 2 - Site Plan



October 07, 2015

KIMBERLY WILSON

TALON LPE

408 W. TEXAS AVE.

ARTESIA, NM 88210

RE: PLAYA 2 STATE #1 H

Enclosed are the results of analyses for samples received by the laboratory on 10/06/15 9:54.

Cardinal Laboratories is accredited through Texas NELAP under certificate number T104704398-13-5. Accreditation applies to drinking water, non-potable water and solid and chemical materials. All accredited analytes are denoted by an asterisk (*). For a complete list of accredited analytes and matrices visit the TCEQ website at www.tceq.texas.gov/field/qa/lab_accred_certif.html.

Cardinal Laboratories is accredited through the State of Colorado Department of Public Health and Environment for:

Method EPA 552.2	Haloacetic Acids (HAA-5)
Method EPA 524.2	Total Trihalomethanes (TTHM)
Method EPA 524.4	Regulated VOCs (V1, V2, V3)

Accreditation applies to public drinking water matrices.

This report meets NELAP requirements and is made up of a cover page, analytical results, and a copy of the original chain-of-custody. If you have any questions concerning this report, please feel free to contact me.

Sincerely,

Celey D. Keene

Lab Director/Quality Manager

Analytical Results For:

 TALON LPE
 KIMBERLY WILSON
 408 W. TEXAS AVE.
 ARTESIA NM, 88210
 Fax To: (575) 745-8905

 Received: 10/06/2015
 Reported: 10/07/2015
 Project Name: PLAYA 2 STATE #1 H
 Project Number: 700794.150.01
 Project Location: 30-025-40405

 Sampling Date: 10/05/2015
 Sampling Type: Soil
 Sampling Condition: Cool & Intact
 Sample Received By: Judy Garcia

Sample ID: GS 1-0 (H502635-01)

BTEX 8021B		mg/kg		Analyzed By: MS					
Analyte	Result	Reporting Limit	Analyzed	Method Blank	BS	% Recovery	True Value QC	RPD	Qualifier
Benzene*	<0.050	0.050	10/06/2015	ND	2.21	110	2.00	0.252	
Toluene*	<0.050	0.050	10/06/2015	ND	2.08	104	2.00	0.0576	
Ethylbenzene*	<0.050	0.050	10/06/2015	ND	1.76	87.9	2.00	0.776	
Total Xylenes*	<0.150	0.150	10/06/2015	ND	5.96	99.3	6.00	1.07	
Total BTEX	<0.300	0.300	10/06/2015	ND					

Surrogate: 4-Bromofluorobenzene (PID) 111 % 85.6-137

TPH 8015M		mg/kg		Analyzed By: MS					
Analyte	Result	Reporting Limit	Analyzed	Method Blank	BS	% Recovery	True Value QC	RPD	Qualifier
GRO C6-C10	<10.0	10.0	10/07/2015	ND	190	95.1	200	0.614	
DRO >C10-C28	1160	10.0	10/07/2015	ND	207	104	200	0.380	

Surrogate: 1-Chlorooctane 91.8 % 47.2-157

Surrogate: 1-Chlorooctadecane 107 % 52.1-176

Cardinal Laboratories

*=Accredited Analyte

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Celey D. Keene, Lab Director/Quality Manager

Notes and Definitions

ND	Analyte NOT DETECTED at or above the reporting limit
RPD	Relative Percent Difference
**	Samples not received at proper temperature of 6°C or below.
***	Insufficient time to reach temperature.
-	Chloride by SM4500Cl-B does not require samples be received at or below 6°C Samples reported on an as received basis (wet) unless otherwise noted on report

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*=Accredited Analyte

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Celey D. Keene, Lab Director/Quality Manager

