

Submit 3 Copies To Appropriate District Office
District I
1625 N French Dr , Hobbs, NM 88240
District II
1301 W. Grand Ave , Artesia, NM 88210
District III
1000 Rio Brazos Rd , Aztec, NM 87410
District IV
1220 S St. Francis Dr , Santa Fe, NM 87505

State of New Mexico
Energy, Minerals and Natural Resources

Form C-103
May 27, 2004

OIL CONSERVATION DIVISION
1220 South St. Francis Dr.
Santa Fe, NM 87505

WELL API NO. 30-039-29691
5. Indicate Type of Lease STATE <input type="checkbox"/> FEE <input type="checkbox"/>
6. State Oil & Gas Lease No.
7. Lease Name or Unit Agreement Name RINCON UNIT
8. Well Number #503
9. OGRID Number 189071
10. Pool name or Wildcat BASIN DAKOTA/BLANCO MESAVERDE

SUNDRY NOTICES AND REPORTS ON WELLS (DO NOT USE THIS FORM FOR PROPOSALS TO DRILL OR TO DEEPEN OR PLUG BACK TO A DIFFERENT RESERVOIR USE "APPLICATION FOR PERMIT" (FORM C-101) FOR SUCH PROPOSALS) 1. Type of Well: Oil Well <input type="checkbox"/> Gas Well <input checked="" type="checkbox"/> Other	
2. Name of Operator Chevron MidContinent, L.P.	
3. Address of Operator P.O. Box 36366, Houston, TX 77236	
4. Well Location Unit Letter _____ 2125' _____ feet from the _____ NORTH _____ line and _____ 255' _____ feet from the _____ EAST _____ line Section 13 Township T27N Range R7W NMPM RIO ARRIBA County	
11. Elevation (Show whether DR, RKB, RT, GR, etc.)	
Pit or Below-grade Tank Application <input checked="" type="checkbox"/> or Closure <input type="checkbox"/>	
Pit type _____ Pit Tank _____ Depth to Groundwater >100' _____ Distance from nearest fresh water well >1000' _____ Distance from nearest surface water >1000' _____	
Pit Liner Thickness: _____ mil	Below-Grade Tank: Volume 95 bbls; Construction Material Steel

12. Check Appropriate Box to Indicate Nature of Notice, Report or Other Data

NOTICE OF INTENTION TO:		SUBSEQUENT REPORT OF:	
PERFORM REMEDIAL WORK <input type="checkbox"/>	PLUG AND ABANDON <input type="checkbox"/>	REMEDIAL WORK <input type="checkbox"/>	ALTERING CASING <input type="checkbox"/>
TEMPORARILY ABANDON <input type="checkbox"/>	CHANGE PLANS <input checked="" type="checkbox"/>	COMMENCE DRILLING OPNS. <input type="checkbox"/>	P AND A <input type="checkbox"/>
PULL OR ALTER CASING <input type="checkbox"/>	MULTIPLE COMPL <input type="checkbox"/>	CASING/CEMENT JOB <input type="checkbox"/>	
OTHER: CHANGE OF PLANNED FACILITIES <input checked="" type="checkbox"/>		OTHER: <input type="checkbox"/>	

13. Describe proposed or completed operations. (Clearly state all pertinent details, and give pertinent dates, including estimated date of starting any proposed work). SEE RULE 1103. For Multiple Completions: Attach wellbore diagram of proposed completion or recompletion.

Chevron MidContinent, L.P. reports that we have changed our planned facilities for the above mentioned location. A ~400 BBL steel tank, a ~95 BBL below-grade steel tank, a separator, and an Enterprise meter run will be installed on the well pad. Attached is a basic diagram of how these facilities would be arranged on a wellsite and a basic diagram of the 95Bbl below-grade steel tank. Should you have any questions or require any additional information, please feel free to contact us at anytime.

RCVD JUL31'07


OIL CONS. DIV.

DIST. 3

I hereby certify that the information above is true and complete to the best of my knowledge and belief. I further certify that any pit or below-grade tank has been/will be constructed or closed according to NMOCD guidelines ☒, a general permit ☐ or an (attached) alternative OCD-approved plan ☐.

SIGNATURE Jennifer Hudgens TITLE REGULATORY TECHICIAN DATE 7-27-2007
Type or print name Jennifer Hudgens E-mail address: jhio@chevron.com Telephone No: 281-561-3599
For State Use Only Deputy Oil & Gas Inspector,
District #3

APPROVED BY: [Signature] TITLE _____ DATE SEP 06 2007
Conditions of Approval (if any): _____

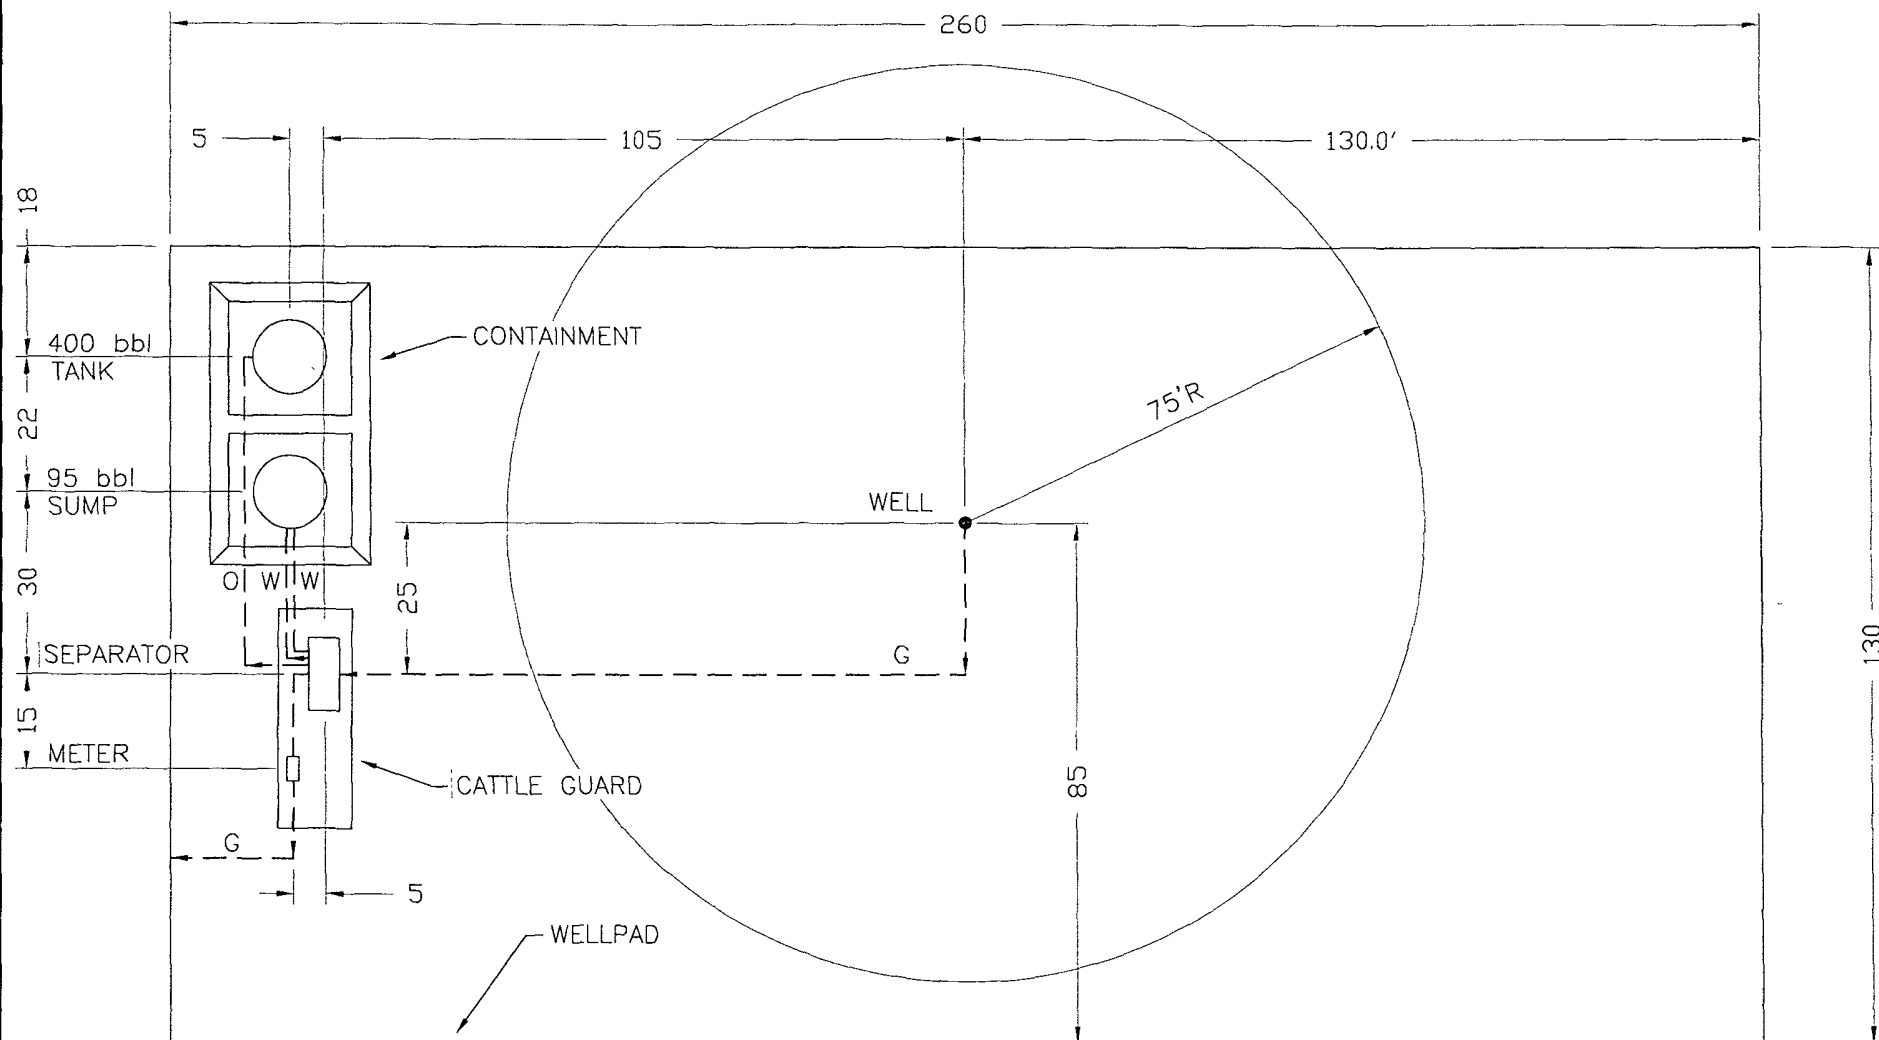

SITE PLAN

FORERUNNER
CORPORATION
211 Rock Point Drive, Suite 101
Durango, CO 81301
(970) 375-7767

NOTES:

Chevron
North
America
Exploration &
Production



TC-STANDARD FACILITY

DRAWN/DATE	SCALE 1"=30'	PROJ. NO.	DWG. NO.	REV
DRAWN BY	ENGINEER	FILE	CASE 3	

