

UNITED STATES
DEPARTMENT OF THE INTERIOR
BUREAU OF LAND MANAGEMENT

HOBBS OCD
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JAN 02 2013

FORM APPROVED
OMB No. 1004-0137
Expires: July 31, 2010

SUNDRY NOTICES AND REPORTS ON WELLS
Do not use this form for proposals to drill or to re-enter abandoned well. Use Form 3160-3 (APD) for such proposals.

5. Lease Serial No.
NM-84731

6. If Indian, Allottee or Tribe Name

SUBMIT IN TRIPLICATE - Other instructions on page 2.

7. If Unit of CA/Agreement, Name and/or No.

1. Type of Well
 Oil Well Gas Well Other

8. Well Name and No.
Kachina 8 Federal #003

2. Name of Operator
Devon Energy Production Co LP

9. API Well No.
30-025-31802

3a. Address
PO BOX 250, Artesia, NM 88211

3b. Phone No. (include area code)
575-748-0184

10. Field and Pool or Exploratory Area
South Corbin (Wolfcamp)

4. Location of Well (Footage, Sec., T., R., M., or Survey Description)
1980' FEL & 1980' FNL, Sec. 8, T18S, R33E, Unit G

11. Country or Parish, State
Lea

12. CHECK THE APPROPRIATE BOX(ES) TO INDICATE NATURE OF NOTICE, REPORT OR OTHER DATA

TYPE OF SUBMISSION	TYPE OF ACTION			
<input checked="" type="checkbox"/> Notice of Intent	<input type="checkbox"/> Acidize	<input type="checkbox"/> Deepen	<input type="checkbox"/> Production (Start/Resume)	<input type="checkbox"/> Water Shut-Off
<input type="checkbox"/> Subsequent Report	<input type="checkbox"/> Alter Casing	<input type="checkbox"/> Fracture Treat	<input checked="" type="checkbox"/> Reclamation	<input type="checkbox"/> Well Integrity
<input type="checkbox"/> Final Abandonment Notice	<input type="checkbox"/> Casing Repair	<input type="checkbox"/> New Construction	<input type="checkbox"/> Recomplete	<input type="checkbox"/> Other _____
	<input type="checkbox"/> Change Plans	<input type="checkbox"/> Plug and Abandon	<input type="checkbox"/> Temporarily Abandon	Drilling Pit
	<input type="checkbox"/> Convert to Injection	<input type="checkbox"/> Plug Back	<input type="checkbox"/> Water Disposal	

13. Describe Proposed or Completed Operation: Clearly state all pertinent details, including estimated starting date of any proposed work and approximate duration thereof. If the proposal is to deepen directionally or recomple horizontally, give subsurface locations and measured and true vertical depths of all pertinent markers and zones. Attach the Bond under which the work will be performed or provide the Bond No. on file with BLM/BIA. Required subsequent reports must be filed within 30 days following completion of the involved operations. If the operation results in a multiple completion or recomple in a new interval, a Form 3160-4 must be filed once testing has been completed. Final Abandonment Notices must be filed only after all requirements, including reclamation, have been completed and the operator has determined that the site is ready for final inspection.)

- Devon Energy has contracted Talon/LPE to do reclamation activities on the closed drilling pit at the Kachina 8 Federal No. 3, an active well location.
- On 10/24/2012 Talon/LPE mobilized personnel to the site to carry out soil sampling activities for the construction of a work plan. Grab soil samples were collected from the surface of the location. The soil samples were sent to Cardinal Laboratories for analysis of total Chlorides via Method SM4500Cl-B. The results for the soil samples are attached. A site plan is also attached.
- New soil will be transported in from a local borrow pit. A minimum of 1-foot of new soil will be placed on the closed drilling pit area.
- The soil lift will be contoured to match the surrounding terrain and will be seeded using the recommended BLM seed mixture for the area. #2
- Windrows will be installed over the soil lift for erosion control. See & M.S.

Notify Jim Amos @ 575-234-5909 @ completion

14. I hereby certify that the foregoing is true and correct. Name (Printed/Typed)
Jerry Channey

Title Assistant Production Foreman

Signature *Jerry Channey* Date 11/29/2012

THIS SPACE FOR FEDERAL OR STATE OFFICE USE



Approved by *James B. Amos* Title *SEPS* Date *12-29-12*

Conditions of approval, if any, are attached. Approval of this notice does not warrant or certify that the applicant holds legal or equitable title to those rights in the subject lease which would entitle the applicant to conduct operations thereon. Office *CFO*

Title 18 U.S.C. Section 1001 and Title 43 U.S.C. Section 1212, make it a crime for any person knowingly and willfully to make to any department or agency of the United States any false, fictitious or fraudulent statements or representations as to any matter within its jurisdiction.

(Instructions on page 2) *MJB/OCD 1/4/2013*

Jim
JAN 08 2013

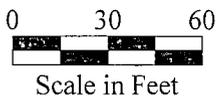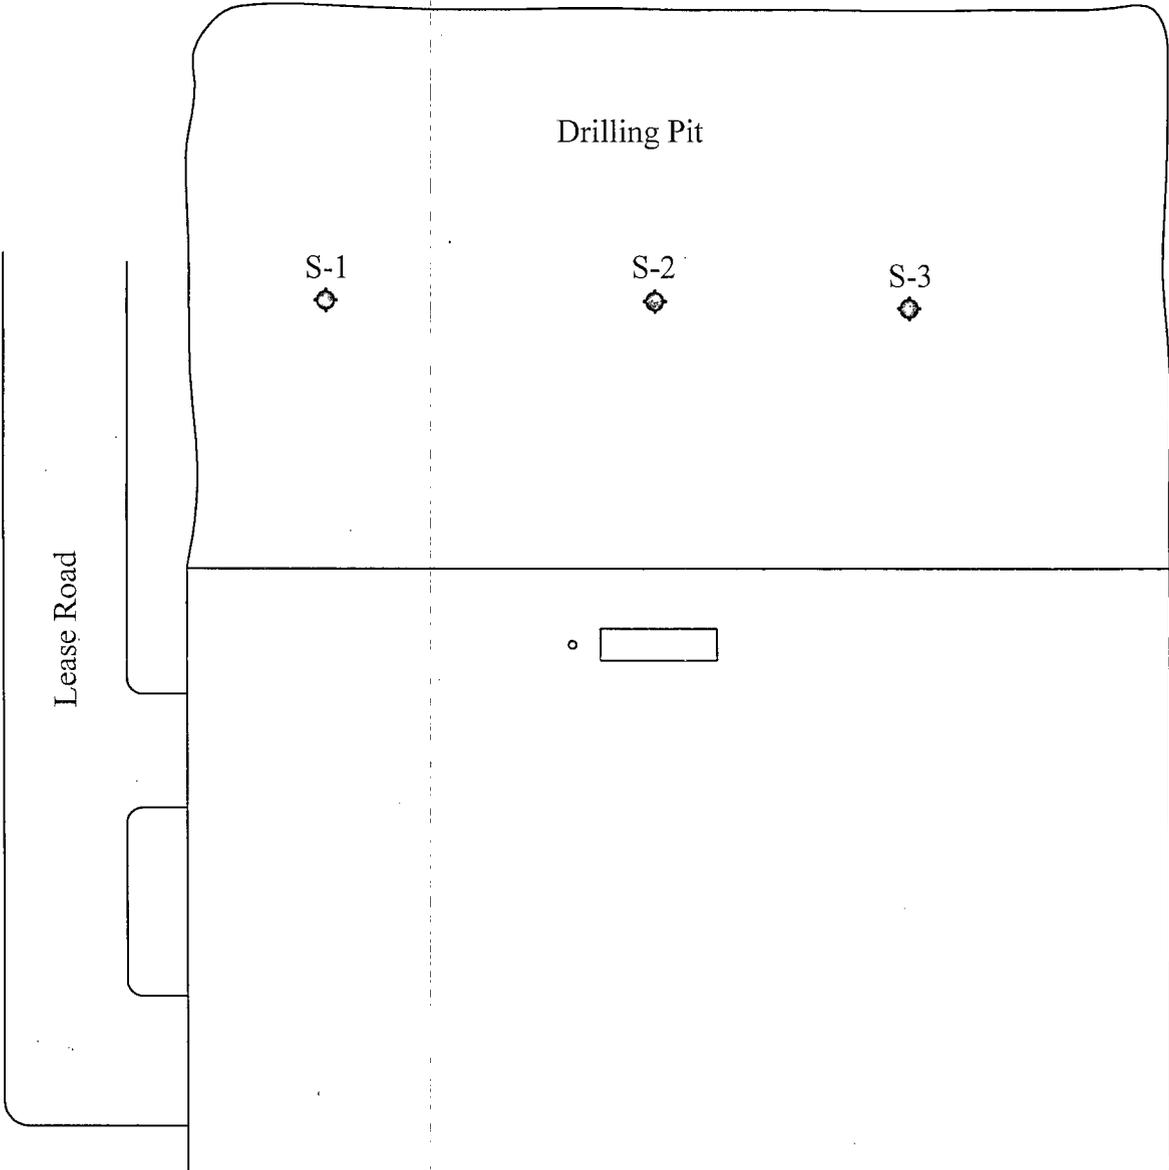

Legend

◆ - Sample Location



Date: 11/30/2012

Scale: 1" = 60'

Drawn By: TJS

Kachina 8 Federal No. 3
Devon Energy Corporation
Hobbs, New Mexico
Figure 1 - Site Plan

October 25, 2012

MIKE STUBBLEFIELD

TALON LPE

408 W. TEXAS AVE.

ARTESIA, NM 88210

RE: KACHINA 8 FEDERAL NO. 3

Enclosed are the results of analyses for samples received by the laboratory on 10/24/12 15:40.

Cardinal Laboratories is accredited through Texas NELAP under certificate number T104704398-11-3. Accreditation applies to drinking water, non-potable water and solid and chemical materials. All accredited analytes are denoted by an asterisk (*). For a complete list of accredited analytes and matrices visit the TCEQ website at www.tceq.texas.gov/field/qa/lab_accred_certif.html.

Cardinal Laboratories is accredited through the State of Colorado Department of Public Health and Environment for:

Method EPA 552.2	Haloacetic Acids (HAA-5)
Method EPA 524.2	Total Trihalomethanes (TTHM)
Method EPA 524.4	Regulated VOCs (V1, V2, V3)

Accreditation applies to public drinking water matrices.

This report meets NELAP requirements and is made up of a cover page, analytical results, and a copy of the original chain-of-custody. If you have any questions concerning this report, please feel free to contact me.

Sincerely,



Celey D. Keene

Lab Director/Quality Manager

Analytical Results For:

 TALON LPE
 MIKE STUBBLEFIELD
 408 W. TEXAS AVE.
 ARTESIA NM, 88210
 Fax To: (575) 745-8905

Received:	10/24/2012	Sampling Date:	10/24/2012
Reported:	10/25/2012	Sampling Type:	Soil
Project Name:	KACHINA 8 FEDERAL NO. 3	Sampling Condition:	** (See Notes)
Project Number:	700794.037.01	Sample Received By:	Jodi Henson
Project Location:	SEC. 8 - T18S - R33E		

Sample ID: S - 1 0' (H202592-01)

Chloride, SM4500Cl-B		mg/kg		Analyzed By: HM						
Analyte	Result	Reporting Limit	Analyzed	Method Blank	BS	% Recovery	True Value QC	RPD	Qualifier	
Chloride	848	16.0	10/25/2012	ND	416	104	400	3.77		

Sample ID: S - 2 0' (H202592-02)

Chloride, SM4500Cl-B		mg/kg		Analyzed By: HM						
Analyte	Result	Reporting Limit	Analyzed	Method Blank	BS	% Recovery	True Value QC	RPD	Qualifier	
Chloride	1170	16.0	10/25/2012	ND	416	104	400	3.77		


Sample ID: S - 3 0' (H202592-03)

Chloride, SM4500Cl-B		mg/kg		Analyzed By: HM						
Analyte	Result	Reporting Limit	Analyzed	Method Blank	BS	% Recovery	True Value QC	RPD	Qualifier	
Chloride	48.0	16.0	10/25/2012	ND	416	104	400	3.77		

Cardinal Laboratories

* = Accredited Analyte

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Celey D. Keene, Lab Director/Quality Manager

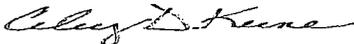Notes and Definitions

- ND Analyte NOT DETECTED at or above the reporting limit
- RPD Relative Percent Difference
- ** Samples not received at proper temperature of 6°C or below.
- *** Insufficient time to reach temperature.
- Chloride by SM4500Cl-B does not require samples be received at or below 6°C
Samples reported on an as received basis (wet) unless otherwise noted on report

Cardinal Laboratories

*=Accredited Analyte

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Celey D. Keene, Lab Director/Quality Manager

