Submit I Copy To Appropriate District Office	State of New Mexico		Form C-103			
District I - (575) 393-6161	Energy, Minerals and Natural Resources		Revised August 1, 2011 WELL API NO. 30-025-29324			
1625 N. French Dr., Hobbs, NM 88240 <u>District II</u> – (575) 748-1283	OIL CONSERVATION DIVISION					
811 S. First St., Artesia, NM 88210 <u>District III</u> - (505) 334-6178	1220 South St. Francis Dr.		5. Indicate Type of Lease STATE FEE			
1000 Rio Brazos Rd., Aztec, NM 87410 <u>District IV</u> – (505) 476-3460	Santa Fe, NM 87505		6. State Oil & Gas Lease No.			
1220 S. St. Francis Dr., Santa Fe, NM 87505						
SUNDRY NOTION (DO NOT USE THIS FORM FOR PROPOSE DIFFERENT RESERVOIR. USE "APPLIC PROPOSALS.)	CES AND REPORTS ON WELL ALS TO DRILL OR TO DEEPEN OR PI ATION FOR PERMIT" (FORM C-101) E	LUG BACK,TO,A	7. Lease Name or Unit Agreement Name ARCO STATE			
1 m m m m m m m m m m m m m m m m m m m			8. Well Number 1Y			
1. Type of Well: Oil Well Gas Well Other 2. Name of Operator: DEVON ENERGY COMPANY, LP			9. OGRID Number 6137			
3. Address of Operator: PO BOX 250 ARTESIA, NM 88	211	RECEIVED	10. Pool name or Wildcat: DEAN;PERMO UPPER PENN			
4. Well Location		N.C.				
Unit Letter <u>E</u> : 2310'		line and <u>930'</u>	feet from the <u>WEST</u> line			
Section 35	Township 15S Rar 11. Elevation (Show whether DI	nge 36E	NMPM County LEA			
		K, KKB, K1, GK, eic., 861.5' GL; 19.5' KB				
12. Check A	ppropriate Box to Indicate I	Nature of Notice,	Report or Other Data			
NOTICE OF INTENTION TO: PERFORM REMEDIAL WORK PLUG AND ABANDON REMEDIAL WORK ALTERING CASING						
TEMPORARILY ABANDON PULL OR ALTER CASING	CHANGE PLANS MULTIPLE COMPL	COMMENCE DRI	<u> </u>			
DOWNHOLE COMMINGLE						
OTHER:		OTHER: Loca	tion & Pit Reclamation ⊠			
13. Describe proposed or completed operations. (Clearly state all pertinent details, and give pertinent dates, including estimated date of starting any proposed work). SEE RULE 19.15.7.14 NMAC. For Multiple Completions: Attach wellbore diagram of proposed completion or recompletion.						
Actions Taken:						
1. Devon Energy had contracte	ed Talon/LPE to do reclamation ac	ctivities at the Arco 1	Y, a P&A location.			
2. The location, pasture and closed drilling pit were reclaimed per Landowner request. Due to high chlorides leaching to the surface in the closed drilling pit and an area of pasture they were excavated to a depth of 4-feet deep and 20 mil liners were installed.						
3. The impacted soil was transported to Lea Land, LLC.						
4. 4-feet of top soil was obtained from the landowner and placed over both liners. Once the caliche was removed from the location, top soil was used per farmer's request. He will use the land to grow his alfalfa.						
The caliche from the locatio surrounding terrain.	n was used for road repair. The d	Irilling pit, pasture ar	nd location were re-contoured to match the			
6. No further actions are require	ed.					
Spud Date:	Rig Release D	ate:				
I hereby certify that the information a	above is true and complete to the	best of my knowledg	e and belief.			
SIGNATURE denise M	Jenoul TITLE F	ield Admir	Suppose DATE 7/29/15			
Type or print name DENISE /	AENOUD E-mail address	s: denise · menou	10 dun. PHONE: 575-746-5544			
Accepted for	Record Only		8/5/2015			

ARCO 1Y * 30-015-29324 *

Lab data and on site field titration testing for chlorides

12/16/2014., see site maps

- Sample point S-1 was excavated at least to a depth of 2.5-feet with field titration to guide the excavation.
- Sample point S-2 was clean.
- Sample point S-3 was excavated to a depth of 2.5-feet with field titration.
- Sample point S-4 should be excavated to a depth of 2-feet.
- Sample point S-5 was excavated to a depth of 3-feet. This area was tested with a PID meter to guide the excavation.

Laboratory Results

The complete report is attached.

Sample ID	Depth (feet)	BTEX (mg/kg)	Chlorides (mg/kg)	TPH (mg/kg) GRO	TPH (mg/kg) DRO
S-1	0′	<0.300	7060	<10	<10
	1′	<0.300	1090	<10	<10
Refusal	1.5'	<0.300	2720	<10	<10
S-2	0′	<0.300	16	<10	<10
	1′	<0.300	<16	<10	<10
	2′	<0.300	<16	<10	<10
S-3	0′	<0.300	352	<10	<10
	1′	<0.300	3560	<10	14.4
Refusal	1.5'	<0.300	1040	<10	<10
S-4	0′	<0.300	384	<200	1890
	1′	<3.00	464	239	5460
	2′	<0.300	704	<10	137
	3′	<0.300	80	<50	260
S-5	0′	<1.20	880	144	16500
Refusal	0.5'	<1.20	64	173	9210




ARCO 1Y * 30-015-29324 *

6/18/2015, see site maps

My field titration testing results for chlorides were as follows:

Sample ID	Depth	Chlorides	
_	_	(mg/kg)	
P-1	0'	7161	
	1'	3616	
	2'	5672	
P-2	0'	4112	
	1'	3191	
	2'	5743	
P-3	0'	780	
	1'	1489	
	2'	1489	
D-1	0'	23600	
	1'	21800	
	2'	16400	
	3'	9100	
	4'	5112	
D-2	0'	25200	
	1'	11210	
	2'	8320	
	3'	9589	
	4'	10010	
D-3	0'	24000	
	1'	15200	
	2'	14320	
	3'	9600	
	4'	12600	

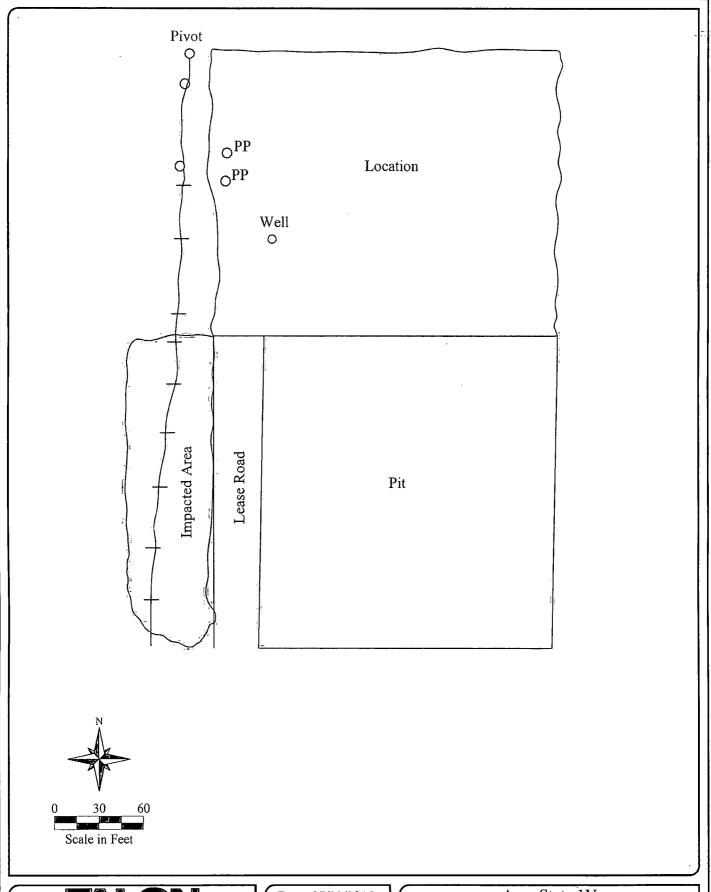




Date: 07/23/2015

Scale: 1" = 60'

Drawn By: TJS

Arco State 1Y
Devon Energy Corporation
Lea County, New Mexico
Figure 1 - Site Plan

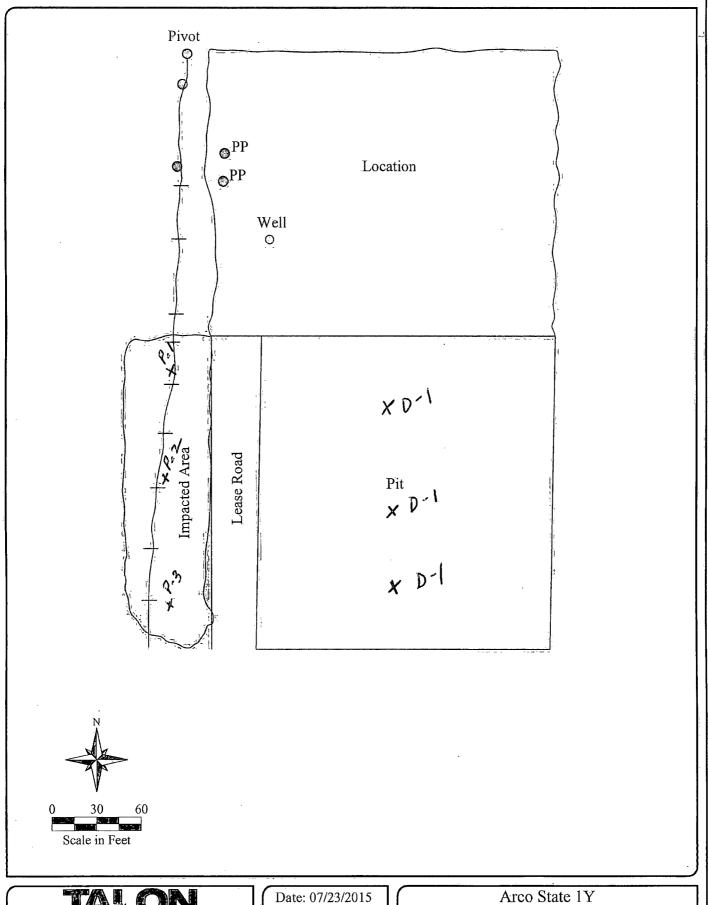




Scale: 1'' = 60'

Drawn By: TJS

Arco State 1Y
Devon Energy Corporation
Lea County, New Mexico
Figure 1 - Site Plan

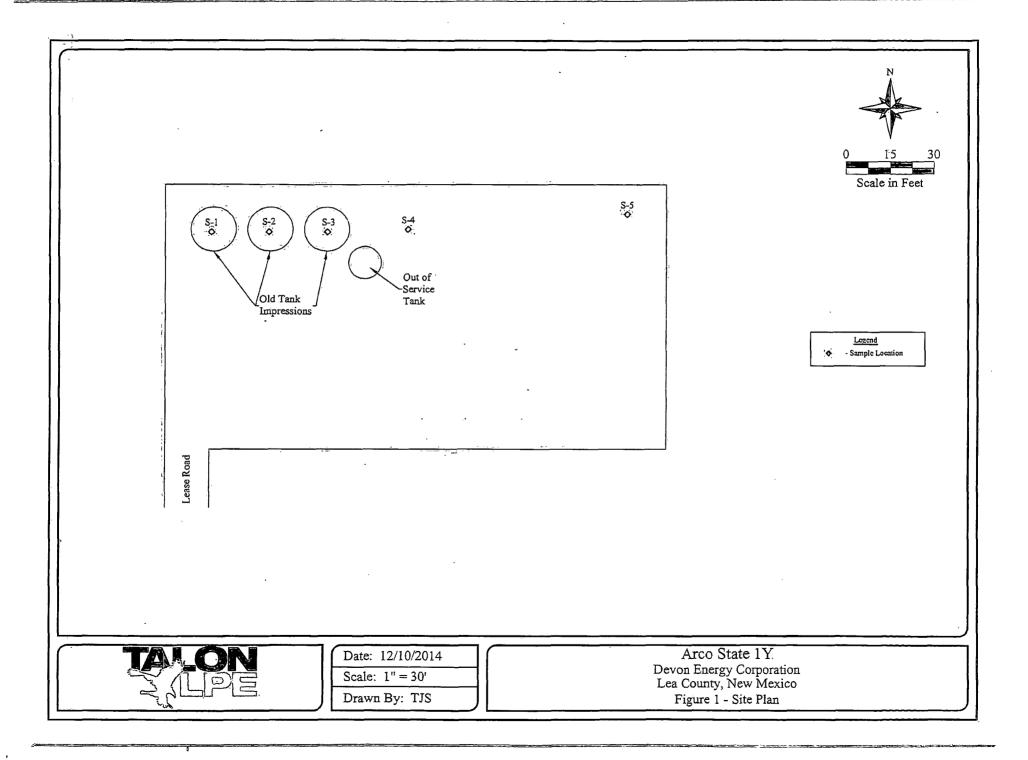

Menoud, Denise

From:

Kimberly M. Wilson < kwilson@talonlpe.com>

Sent:

Tuesday, July 28, 2015 12:02 PM

To:

Menoud, Denise; Fulks, Brett

Cc:

Kidd, Aaron; David Adkins

Subject:

Arco 1Y * 30-025-29324 * P&A location

Attachments:

Arco site map.pdf; Aroc 1Y sub sub PA c103.pdf; Arco 1Y notes.pdf; Arco 1Y sub

C-103.pdf; Arco 1Y old site maps with sample loc..pdf

Good Afternoon All,

Please find the Closure report for the above location. The C-103's need signatures and filed with the NMOCD Hobbs office attention Maxey Brown. The notes are for your files along with the site map with the sample locations on it.

If you have any questions or concerns please feel free to contact me.

Thank you. I appreciated your business.

Respectfully submitted,

Kimberly

Kimberly M. Wilson

Project Manager

TALON/LPE

408 W. Texas

Artesia, NM 88210

Direct: 575-616-4023 Cell: 575-602-3826 Office: 575-746-8768 Emergancy: 866-

Email: kwilson@talonlpe.com



Better Business Bureau Torch Award for Marketplace Ethics: 2010 Winner, 2009 Finalist Staples Foundation for Learning Hall of Fame Recipient: 2010 ICIC and Business Week-Top 100: 2010, 2009, 2008, 2007, 2006 Inc. 500/5000: 2012, 2011, 2010, 2009, 2008, 2007