

NE MEXICO OIL CONSERVATION COMMISSION
Santa Fe, New Mexico

MISCELLANEOUS NOTICES

Submit this notice in triplicate to the Oil Conservation Commission or its proper agent before the work specified is to begin. A copy will be returned to the sender on which will be given the approval, with any modifications considered advisable, or the rejection by the Commission or agent, of the plan submitted. The plan as approved should be followed, and work should not begin until approval is obtained. See additional instructions in the Rules and Regulations of the Commission.

Indicate nature of notice by checking below:

NOTICE OF INTENTION TO TEST CASING SHUT-OFF		NOTICE OF INTENTION TO SHOOT OR CHEMICALLY TREAT WELL	
NOTICE OF INTENTION TO CHANGE PLANS		NOTICE OF INTENTION TO PULL OR OTHERWISE ALTER CASING	
NOTICE OF INTENTION TO REPAIR WELL		Notice of Intention to flow seven wells into one central tank battery	
NOTICE OF INTENTION TO DEEPEN WELL		NOTICE OF INTENTION TO PLUG WELL	

Odessa, Texas

August 25, 1941

Place

Date

OIL CONSERVATION COMMISSION,
Santa Fe, New Mexico

Gentlemen:

Following is a notice of intention to do certain work as described below at the

3-8-33-36-38

Phillips Petroleum Company

Santa Fe

Well No. **39-45**

in

Company or Operator

Lease

of Sec. **4 & 5**, T. **18-S**, R. **35-E**, N. M. P. M., **Vacuum** Field,

Lea

County.

FULL DETAILS OF PROPOSED PLAN OF WORK

FOLLOW INSTRUCTIONS IN THE RULES AND REGULATIONS OF THE COMMISSION

All of the wells listed above are in Section 5-183-35E, with the exception of #39 in the NW/4 of Sec. 4, as shown on the attached plat. Permission was obtained from the Oil Conservation Commission on April 12, 1940, to flow six wells into one tank battery. We now wish to request permission to add a seventh well (#45) to this tank battery, which consists of five 210-bbl. welded steel tanks. These seven wells can be efficiently produced into one central tank battery, provided an exception will be made to the Oil Conservation Commission ruling against flowing more than five wells into one central battery. Unless this exception is granted, it will be necessary to set an additional separator and two additional stock tanks for one well (#45), which involves a considerable expenditure.

AUG 27 1941

Approved _____, 19

except as follows:

Phillips Petroleum Company

Company or Operator

By

Position **District Superintendent**

Send communications regarding well to

OIL CONSERVATION COMMISSION,

By

OIL & GAS INSPECTOR

Title

Name **M. L. Atkinson**

Address **Box #6666, Odessa, Texas**



COMF


Sheet No. _____

Nature of Work _____ Date _____ Line No. _____

District _____ Plant or Station _____ JOB AFE No. _____

Sec. _____ Twp. _____ Range _____ Blk. _____ Survey _____ Co. _____ State _____

NORTH

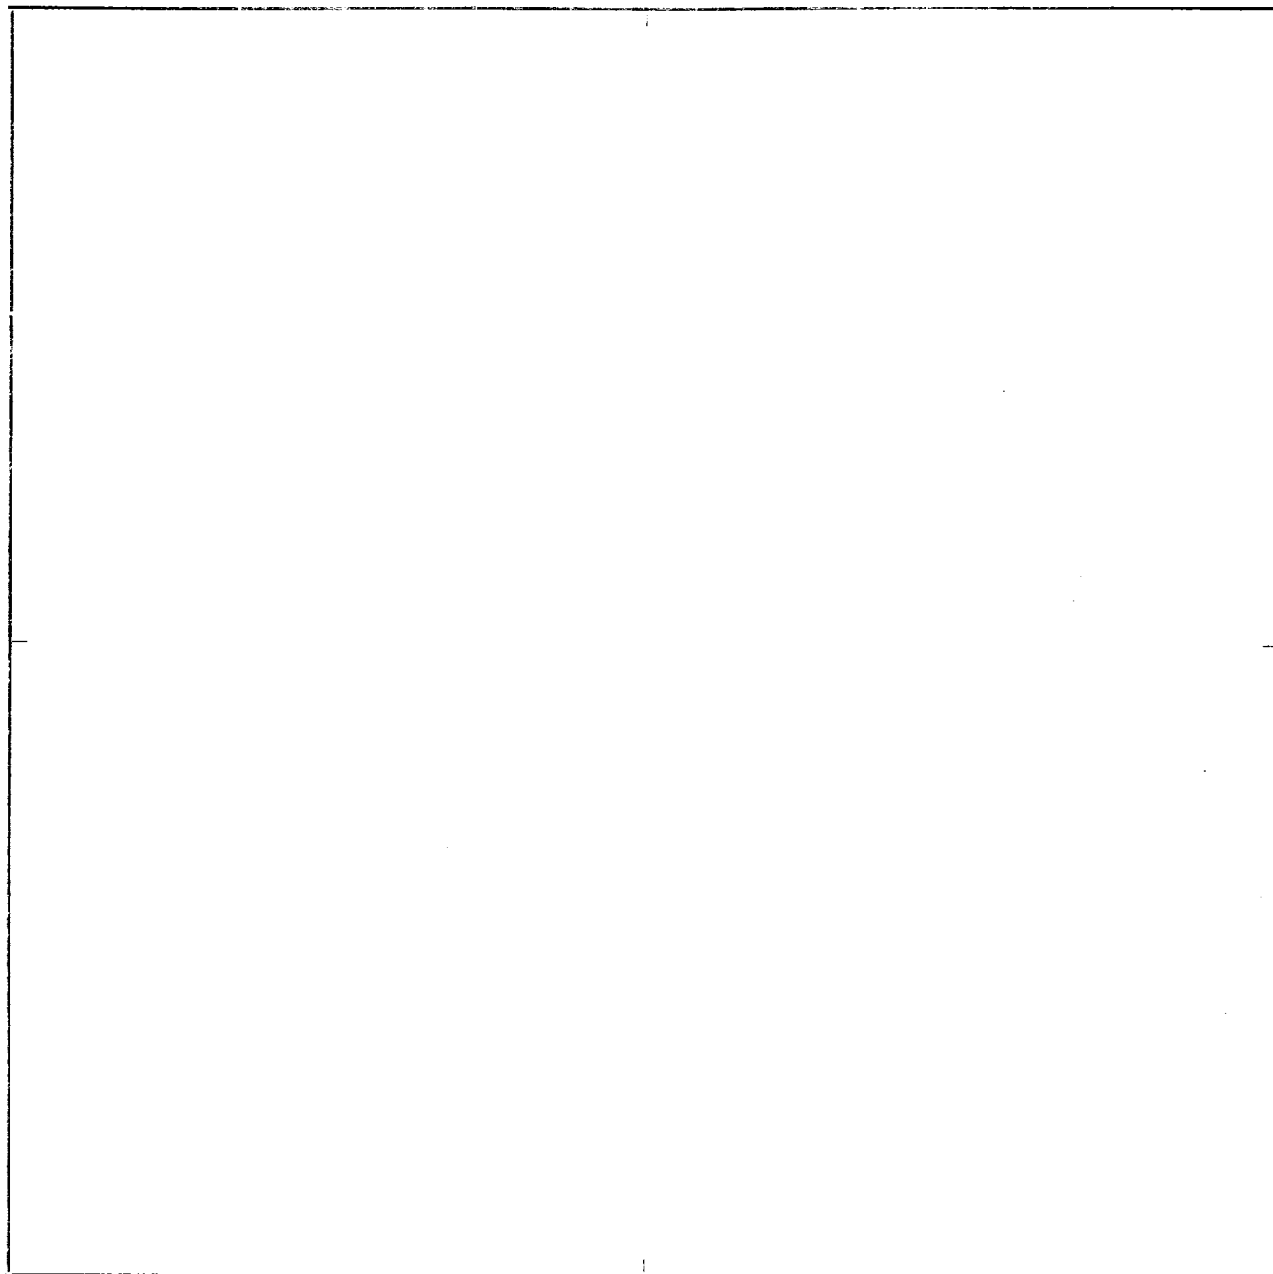

This Plat to be used for Section or 1/4 Section — Scale: for Sec. 1"=800' for 1/4 Sec. 1"=400'

PRELIMINARY SURVEY INSTRUCTIONS

1. Tie line to survey and property corners
2. Show ownership, state of cultivation and plusses on property lines
3. Attach plan and profile of all railroads, steam or road crossings
4. Show plusses and bearings on all benches
5. Mention rock and timber conditions or any surface observations of special interest
6. Use authorized conventions
7. Make notes complete

Remarks: _____

Signed _____ Dept. _____

FOR CHANGES & REQUIREMENTS THIS PLAT TO BE ACCOMPANIED BY PIPE LINE
REPORT FORM NO. 367

CONVENTIONS		PIPE LAID	
—X—	Gate Valve	Size	Amt.
—<—	Check Valve	"	"
—(P)—	Pipes	"	"
—(D)—	Dresser	"	"
—(D)—	Drip	PIPE TAKEN UP	
—(R)—	Regulators	Size	Amt.
—(F)—	Flange	"	"
—(C)—	Change in Size	"	"
—(S)—	Pipe Supports	"	"
—(T)—	Tie Line	Map No.	Sheet No.
—(L)—	4" R.R. Pipe on Line	Plotted by	
—(H)—	Highway	Date	
—(R)—	Railroads		