

NEW MEXICO OIL CONSERVATION COMMISSION  
Santa Fe, New Mexico

**MISCELLANEOUS NOTICES**

Submit this notice in triplicate to the Oil Conservation Commission or its proper agent before the work specified is to begin. A copy will be returned to the sender on which will be given the approval, with any modifications considered advisable, or the rejection by the Commission or agent, of the plan submitted. The plan as approved should be followed, and work should not begin until approval is obtained. See additional instructions in the Rules and Regulations of the Commission.

Indicate nature of notice by checking below:

NOTICE OF INTENTION TO TEST CASING SHUT-OFF		NOTICE OF INTENTION TO SHOOT OR CHEMICALLY TREAT WELL	
NOTICE OF INTENTION TO CHANGE PLANS		NOTICE OF INTENTION TO PULL OR OTHERWISE ALTER CASING	
NOTICE OF INTENTION TO REPAIR WELL		<b>Notice of Intention to flow eight wells into One Central Tank Battery</b>	
NOTICE OF INTENTION TO DEEPEN WELL		NOTICE OF INTENTION TO PLUG WELL	

Odessa, Texas

December 9, 1941

Place

Date

OIL CONSERVATION COMMISSION,  
Santa Fe, New Mexico

Gentlemen:

Following is a notice of intention to do certain work as described below at the

Phillips Petroleum Company, Santa Fe Well No. 14-26-37-49 in NW/4  
Company or Lease  
of Sec. 28, T. 17-S, R. 35-E, N. M. P. M., Vacuum Field,  
Lea County.

**FULL DETAILS OF PROPOSED PLAN OF WORK**

FOLLOW INSTRUCTIONS IN THE RULES AND REGULATIONS OF THE COMMISSION

Wells #6 & #9 are located in Sec 21, T-17, R-35; Wells #12, #15 & #37 are located in Sec 28, T-17, R-35; Well #14 is located in Sec 20, T-17, R-35; Wells #36 & #49 are located in Sec 29, T-17, R-35. Permission was obtained from the Oil Conservation Commission on July 24, 1941, to flow seven wells into one tank battery. We now wish to request permission to add an eighth well(49) to this battery, which consists of six 300 bbl welded steel tanks. These eight wells can be efficiently produced into one central tank battery, provided an exception will be made to the Oil Conservation Commission ruling against flowing more than five wells into one central battery. Unless exception is granted, it will be necessary to set an additional separator and two additional stock tanks for one well (49), which involves considerable expenditure.

Approved DEC 13 1941, 19  
except as follows:

Phillips Petroleum Company  
Company or Operator

By M. L. Atkinson

Position District Superintendent

Send communications regarding well to

OIL CONSERVATION COMMISSION,

By Roy Yarbrough  
Title OIL & GAS INSPECTOR

Name M. L. Atkinson

Address Box 6666, Odessa, Texas

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• *Pharmaceuticals* – The pharmaceutical industry is the largest of the three, with sales of \$100 billion in 2000. It is the most profitable, with a profit margin of 25%.



COMPANY \_\_\_\_\_


Sheet No. \_\_\_\_\_

Nature of Work \_\_\_\_\_ Date \_\_\_\_\_ Line No. \_\_\_\_\_

District \_\_\_\_\_ Plant or Station \_\_\_\_\_ JOB No. \_\_\_\_\_

Sec. \_\_\_\_\_ Twp. \_\_\_\_\_ Range \_\_\_\_\_ Blk. \_\_\_\_\_ Survey \_\_\_\_\_ Co. \_\_\_\_\_ State \_\_\_\_\_

NORTH

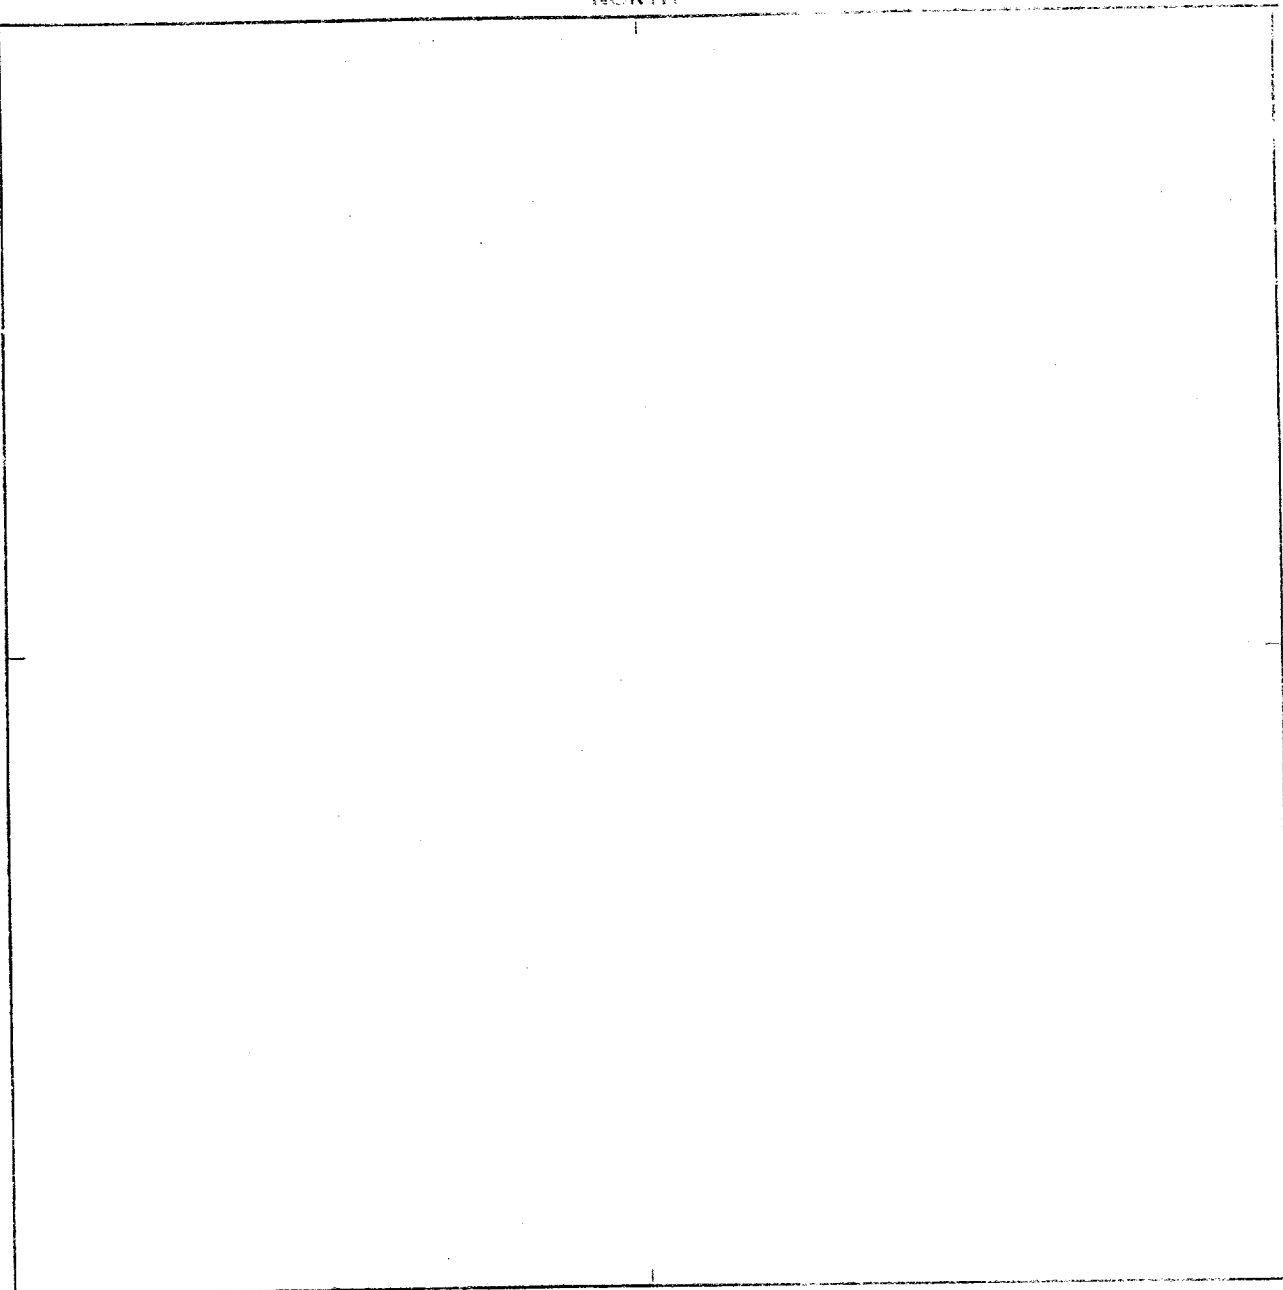

This Plat to be used for Section or 1/4 Section — Scale: for Sec. 1"=800'; for 1/4 Sec. 1"=400'

**PRELIMINARY SURVEY INSTRUCTIONS**

1. Tie line to survey and property corners
2. Show ownership, state of cultivation and plusses on property lines
3. Attach plan and profile of all railroads, steam or road crossings
4. Show plusses and bearings on all bends
5. Mention rock and timber conditions or any surface observations of special interest
6. Use authorized conventions
7. Make notes complete

Remarks: \_\_\_\_\_

Signed \_\_\_\_\_

Dept. \_\_\_\_\_

FOR CHANGES &amp; RESURVEYS, THIS PLAT TO BE ACCOMPANIED BY PIPE LINE

CONVENTIONS		PIPE LAID	
<input checked="" type="checkbox"/> Gate Valve	Size	Amt.	
<input checked="" type="checkbox"/> Check Valve	"	"	
<input checked="" type="checkbox"/> Meter	"	"	
<input checked="" type="checkbox"/> Drift	"	"	
<input checked="" type="checkbox"/> Drip	PIPE TAKEN UP		
<input checked="" type="checkbox"/> Regulators	Size	Amt.	
<input checked="" type="checkbox"/> Flange	"	"	
<input checked="" type="checkbox"/> Change in Size	"	"	
<input checked="" type="checkbox"/> Pipe Supports	"	"	
<input checked="" type="checkbox"/> Tee & Bull Head	Map No.	Sheet No.	
<input checked="" type="checkbox"/> Tee with Gate	Plotted by		
<input checked="" type="checkbox"/> Bolt Reg on Flange	Date		
<input checked="" type="checkbox"/> Check Top P.N.			
<input checked="" type="checkbox"/> A. P. Road			